

Consult with University Representative prior to specifying signage. Given the age of this document, not all sign types herein are considered campus standards.

Use current campus logo artwork and standard colors (blue and gold). Specifications are available in the UCR Brand Book 2020 available online at <https://brand.ucr.edu/>

INTERIOR SIGNAGE: See Multidisciplinary Research Building (MRB) submittal included in this package at PDF page no. 67 to 97. There is some latitude with panel color and material.

For all other exterior signage, refer to this document for style guidance, and confirm with University representative for appropriate materials and implementation.

UNIVERSITY OF CALIFORNIA RIVERSIDE

CAMPUS SIGN PROGRAM
100% PACKAGE

Section 1: Sign Type Drawings
Section 2: Sign Location Plans
Section 3: Building Identification Survey

1.04.08

LAST UPDATED 12.01.2021

- 1.1–1.44 **Section 1**
Sign Type Drawings
- 2.1–2.43 **Section 2**
Sign Location Plans
- 3.1–3.87 **Section 3**
Building Identification Sign Survey

1.1 Typefaces & Color

Electronic Message Boards

- 1.2 W10 Site ID, Freeway
- 1.3 W11 Campus ID

Campus Entry Monument

- 1.4 W15 Primary ID
- 1.5 W16 Secondary ID

Vehicular Directional

- 1.6 W20 Primary
- 1.7 W20.1 Primary, Engineering
- 1.8 W21 Secondary
- 1.9 W21.1 Secondary, Engineering
- 1.10 W22 Pole Mounted
- 1.11 W22.1 Pole Mounted, Engineering

Pedestrian Directional

- 1.12 W30 Blade Sign
- 1.13 W30.1 Blade Sign, Engineering
- 1.14 W35 Wall Mounted
- 1.15 W36 Accessible Pathway

Pedestrian Information

- 1.16 W40 Freestanding Directory, primary
- 1.17 W40.1 Freestanding Directory, primary, Engineering
- 1.18 W40.2 Freestanding Directory, primary, Engineering
- 1.19 W41 Wall Mounted Directory
- 1.20 W41.1 Wall Mounted Directory, Engineering
- 1.21 W42 Freestanding Directory, secondary
- 1.22 W42.1 Freestanding Directory, secondary Engineering
- 1.23 W42.2 Freestanding Directory, secondary Engineering
- 1.24 W46 Info Kiosk, Posted Messages
- 1.25 W46.1 Info Kiosk, Engineering
- 1.26 W46.2 Info Kiosk, Engineering
- 1.27 W48 Interactive Kiosk
- 1.28 W48.1 Interactive Kiosk

Building Identity

- 1.29 W50 Primary, Vehicular
- 1.30 W50.1 Primary, Vehicular
- 1.31 W50.2 Primary, Vehicular
- 1.32 W50.3 Primary, Vehicular, Engineering
- 1.33 W51 Freestanding, Ped
- 1.34 W51.1 Freestanding, Ped
- 1.35 W51.2 Freestanding, Ped
- 1.36 W52 Wall Mounted
- 1.37 W53 Vinyl Letters on Door
- 1.38 W54 Parapet Letters
- 1.39 W55 Building ID, small
(Refer to sheet 1.66 for Loading Dock Identification)

Parking Lot Identity & Information

- 1.40 W70 Primary ID
- 1.41 W70.1 Primary ID
- 1.42 W71 Secondary ID
- 1.43 W71.1 Secondary ID
- 1.44 W72 Pole Mounted ID
- 1.45 W72.1 Pole Mounted ID
- 1.46 W97 Street Sign

Building Interior Identity Program

- 1.47 B20 Ceiling Mounted Department Area ID
- 1.48 B22 Blade Sign ID
- 1.49 B30 Wall Mounted Changeable Room ID **ADDED B31**
- 1.50 B32 Wall Mounted Room ID (Paper Holder) **ADDED B32A**
- 1.51 B36 Wall Mounted Restroom ID (ADA)
- 1.52 B42 Wall Mounted Directional
- 1.53 B50 Wall Mounted Building Directory
- 1.54 B52 Wall Mounted Floor Directory
- 1.55 B60 Wall Mounted Secondary Information
- 1.56 B64 Wall Mounted Bulletin Board
- 1.57 B70 Wall Mounted Permanent Room ID
- 1.58 B75 Wall Mounted Evacuation Map
- 1.59 B80 Wall Mounted Restroom ID
- 1.60 B81 Wall Mounted Stair Level ID (ADA)
- 1.61 B82 Wall Mounted Stair Level ID
- 1.62 B86 Wall Mounted Maximum Occupancy
- 1.63 B90 Door Entry / Exit Information
- 1.64 B92 Wall Mounted Accessible ID
- 1.65 B94 Wall Mounted Accessible Information
- 1.66 B95 Wall Mounted Loading Dock Parking Regulatory Information



Key Plan

2.1 Overall Campus Map

Sign Location Plans:
includes the following sign types

 **Electronic Message Boards**
W10 Site ID, Freeway
W11 Campus ID

 **Campus Entry Monument**
W15 Primary ID
W16 Secondary ID

 **Pedestrian Information**
W36 Accessible Pathway

 **Pedestrian Information**
W40 Freestanding Directory, primary
W41 Wall Mounted Directory
W42 Freestanding Directory, secondary
W46 Info Kiosk, Posted Messages
W48 Interactive Kiosk

 **Building Identity**
W50 Primary, vehicular
W51 Freestanding, Ped

 **Parking Lot Id/Info**
W70 Primary ID
W71 Secondary ID
W72 Pole Mounted ID

 W97 Street Signs

- 2.2 Section A
- 2.3 Section B
- 2.4 Section C
- 2.5 Section D
- 2.6 Section E
- 2.7 Section F
- 2.8 Section G
- 2.9 Section H
- 2.10 Section I
- 2.11 Section J
- 2.12 Section K
- 2.13 Section L
- 2.14 Section M
- 2.15 Section N
- 2.16 Section O
- 2.17 Section P
- 2.18 Section R
- 2.19 Section S

Vehicular Directionals
includes the following sign types

 **Vehicular Directional**
W20 Primary
W21 Secondary
W22 Pole Mounted

- 2.20 Introduction
- 2.21 Section B
- 2.22 Section C
- 2.23 Section E
- 2.24 Section F
- 2.25 Section G
- 2.26 Section H
- 2.27 Section I
- 2.28 Section J
- 2.29 Section K
- 2.30 Section M
- 2.31 Section N
- 2.32 Section Q
- 2.33 Section R
- 2.34 Section S

Pedestrian Directionals
includes the following sign types

 **Pedestrian Directional**
W30 Blade Sign
W35 Wall Mounted

- 2.35 Introduction
- 2.36 Section E
- 2.37 Section F
- 2.38 Section H
- 2.39 Section I
- 2.40 Section J
- 2.41 Section M
- 2.42 Section N
- 2.43 Section S



A

- 3.1 Aberdeen-Inverness Residence Hall (343)
- 3.2 Agricultural Operations (489)
- 3.3 Anderson Hall 1 & 2 (325 & 357)
- 3.4 Arts Building (411)

B

- 3.5 The Barn, Theater Workshop, & Barn Stable (358)
- 3.6 Bannockburn Village *Bldgs A-V* (590–611)
- 3.7 Batchelor Hall (501 & 501a)
- 3.8 Biological Sciences (186)
- 3.9 Biomedical Teaching Complex
& Biomedical Trailers 2 & 3 (385 & 561)
- 3.10 Bookstore (224)
- 3.11 Botanical Gardens (254)
- 3.12 Bourns Hall (261)
- 3.13 Boyce Hall (341)
- 3.14 Boyden Laboratory (482)

C

- 3.15 California Museum of Photography (720) downtown
- 3.16 Campus Surge (380)
- 3.17 Canyon Crest Family Student Housing (000–183)
- 3.18 Central Utility Plant (295)
- 3.19 Chapman Hall (215)
- 3.20 Chemical Sciences (414)
- 3.21 Child Development Center A (396)
- 3.22 College Building North (517)
& College Building South (231)
- 3.23 Computing & Communications Center (381)
- 3.24 Corporation Yard A–C (485–487)
- 3.25 Costo Hall (311)
- 3.26 The Cottage (218)
- 3.27 Culver Center for the Arts (757) downtown
- 3.28 Custodial & Grounds Building (507)

E

- 3.29 Engineering Building Unit 2 (194)
- 3.30 Entomology (417)
- 3.31 Entomology Museum (256)
- 3.32 Environmental Health & Safety (241)

F

- 3.33 Fawcett Laboratory (503)

G

- 3.34 Geology Building (335)
- 3.35 Greenhouses 6–10 (200, & 275–278)
- 3.36 Greenhouses 11–14 (279–281, & 481)
- 3.37 Greenhouses 15–21
(210, 284, 483, 513–515, & 202)

H

- 3.38 Headhouse Greenhouses 1–3 (378, 259, & 374)
- 3.39 Health Services Building (495)
- 3.40 Herbarium (319)
- 3.41 Highlander Hall (716)
- 3.42 Hinderaker Hall (480)
- 3.43 Housing Administration (581)
- 3.44 Human Resources Building (788)
- 3.45 Humanities Building (498)
- 3.46 Humanities & Social Sciences Building (307)

I

- 3.47 East Campus Insectary
& Quarantine Facility (289)
- 3.48 International Village Apartments (998)

K

- 3.49 KUCR Radio Station (176)

L

- 3.50 Life Science Building (316)
- 3.51 Lothian Residence Hall (502)

O

- 3.52 Olmsted Hall (497)

P

- 3.53 Parking Services Building (272)
- 3.54 Pentland Hills Residence Hall A–Q
(365, 369, 636–648)
- 3.55 Physics Building (504)
- 3.56 Physics 2000 Lecture Hall (504A)
- 3.57 Physical Education Building (334)
- 3.58 Pierce Hall (508)
- 3.59 Police Building (566)

R

- 3.60 Rivera Library (322)

S

- 3.61 Satellite Chiller Plant (367)
- 3.62 Science Laboratories 1 (416)
- 3.63 Science Library (418)
- 3.64 Spieth Hall (323)
- 3.65 Sproul Hall (523)
- 3.66 Statistics Computer Building (588)
- 3.67 Stonehaven Apartments (991)
- 3.68 Student Recreation Center (511)

U

- 3.69 UCR/City Athletic Complex (285)
- 3.70 UCR Extension Center (722)
- 3.71 University Laboratory Building (263)
- 3.72 University Lecture Hall (383)
- 3.73 University Office Building (205)
- 3.74 University Office Building A (987)
- 3.75 University Plaza Apartments (715)

W

- 3.76 Watkins Hall (354)
- 3.77 Webber Hall (342)

Not included:

- Alumni & Visitors Center (197)
- Belltower (530)
- Child Development Center B (190)
- Chancellor's Residence (488)
- CHASS Interdisciplinary
North & South (403 & 372)
- Commons Expansion (404)
- Falkirk Apartments 1–19 (671–689)
- Genomics (196)
- Glen Mor Housing A–E (470–475)
- SASS (614)
- School of Education Clinic (397)

PLEASE NOTE:

Sign types W50 and W51 are shown both in the Building Identity Survey and the sign location plan.



CAMPUS WIDE SIGNAGE

The hundreds of signs on the UCR campus not only provide important information; they collectively form powerful and lasting impressions of the University and campus environment. Each sign should be considered a direct message from the administration and each is an opportunity to communicate clearly and present a positive image to students, faculty, staff and visitors.

Intent

Signage and graphics design guidelines seek to unify and improve all signage on the campus by:

- Organizing campus signs into useful, integrated categories
- Standardizing materials, colors and type styles
- Setting scale and size formats
- Creating appropriate relationships to landscape, architectural and lighting elements
- Selecting appropriate design details
- Organize wayfinding

Campus signage has been organized into the following functional groups:

Monument & Entry Signs

Substantial monument signs will be designed and located at key entrances to the campus. Those entrances are identified as

- [1] University Avenue & West Campus Drive
- [2] Martin Luther King Boulevard & Chicago Avenue
- [3] Canyon Crest Drive & Martin Luther King Boulevard
- [4] Big Springs Road & Valencia Hill Drive

For the main entrance signs, permanent, monumental materials such as natural stone and metal will be used to present a formal, welcoming appearance. The signs will be illuminated by remotely mounted fixtures. Letters may be fabricated of metals or incised into the surface of the monument.

In addition to the monument signs, a pylon sign of significant height and visibility will be located adjacent to the freeway. The purpose of this sign is to identify the UCR campus to freeway drivers and to provide an opportunity for University announcements of events. A high resolution LED screen will be incorporated into the pylon, providing a methodology by which the University can communicate directly with the community.

Vehicular Directional Signs and Parking Identification

A system of vehicular signage will be designed and deployed throughout the campus roadways and parking areas. The vehicular sign system will be comprised of directional signs, parking identification signs and street name signs. These signs will display important and “reachable-by-car” campus destinations, and adjacent parking areas, with directional arrows. The signs

will be highly visible and recognizable from over 150 ft. where sight lines allow. *(Drivers should always be able to see at least one directional sign from anywhere on the campus roadways, thus providing substantial driver reassurance.)* The type style should be Trade Gothic Bold No.2 for clarity and easy reading by drivers with reflective qualities for night reading.

Pedestrian Directional Signs

A system of pedestrian-directional signage will be designed and deployed throughout the campus. The directional signs should display important and frequented campus destinations with directional arrows. The directional signs will be a “finger-sign” or pointer style design that features pointed slats for each destination. Signs of this style are very pedestrian friendly and are less prone to vandalism. The height of these signs will be eight to ten feet. The type style should be a simple, bold sans-serif font for clarity and easy reading. Wording on the signs should be simple and use the shortest messages possible. The formal names of some destinations may need to be shortened for effective display on signs.

Pedestrian Map Directories

A system of map directories with lighting for night reading will be designed and deployed throughout the campus presenting an illustrated campus map and detailed listing of all destinations. The directories will present a clear, colorful map, matching that of printed hand-out maps. Maps will be easily changeable to allow for regularly updating campus information.

Information Kiosks

Interactive kiosks will be installed for the display of campus information. Information links within the kiosk software can help foster communication, student interest and help build community on the campus.

Freestanding Building Signage

A system of free-standing building identification signage will be designed and deployed throughout the campus. Each sign will display the formal name of a campus building and be located near the main building entry door. The signs should be highly visible and recognizable from over 200 feet where sight lines allow. These signs will be reflect the University’s blue and gold coloration, but will feature a more architecturally sensitive neutral background color. A letter size of approximately two to three inches will be used. The type style should be Trade Gothic Bold No.2 for clarity and easy reading.

Building-Mounted Signage

Building-mounted signs will be comprised of three categories; architectural letter signs, panel signs and door mounted signs. These signs are to be used in a variety of configurations in order to provide adequate visibility and identification for the building. Architectural letter signs are to be used to prominently identify buildings, generally at or near the top of the structure. Letter size and location should be appropriately scaled and proportioned to the overall

building. Panel signs usually at eye level or slightly above, should be used to supplement the architectural letter signs where building identification is required closer to the entry path. Door mounted signs shall be applied to all main building entry doors. These signs shall be applied vinyl letters applied subsurface to clear glass.

Design Considerations

A wide variety of design approaches and opportunities exist for the signage at UCR. However, while the designs can be simple and understated, or play a more dramatic role, a contemporary, clean-line approach should be used. The buildings of the University are an eclectic mix of architectural and design styles. Signage will be designed to compliment and help unify the campus’s diversity of styles.

Interior Signage

A system of interior signs has been developed to give consistency to the location, size, materials and color of the graphic elements within buildings. Directional signage, room number identification, building and floor directories, and all code required signs shall be laid out and located in accordance with the UCR Interior Signage Guidelines

Color and Contrast

With its large scale, open spaces and long sight lines, the campus needs highly visible and recognizable signs. The use of bold and high contrast colors and materials will help signage elements stand out in the environment. Directional signage will reflect the University’s school colors of blue and gold with sign messages in white. Monument signage will be constructed using a more architectural palette of natural stone and metal finishes.

For more details, please consult the Campus Sign Program, posted on the UCR Capital and Physical Planning website. (www.ucrapb.ucr.edu)

PROJECT TYPESTYLES:

ABCDEFGHIJKLMNOPQRSTUVWXYZ 1234567890

abcdefghijklmnopqrstuvwxyz

Times Bold

ABCDEFGHIJKLMNOPQRSTUVWXYZ 1234567890

abcdefghijklmnopqrstuvwxyz

Times Regular

ABCDEFGHIJKLMNOPQRSTUVWXYZ 1234567890

abcdefghijklmnopqrstuvwxyz

Trade Gothic Bold

ABCDEFGHIJKLMNOPQRSTUVWXYZ 1234567890

abcdefghijklmnopqrstuvwxyz

Trade Gothic Bold No. 2

ABCDEFGHIJKLMNOPQRSTUVWXYZ 1234567890

abcdefghijklmnopqrstuvwxyz

Din Medium



Project Symbols and Arrow

Note:
Times (Bold/Regular) is not to be used on any sign required to be ADA compliant. Use only sans serif font on any sign complying with accessibility code.

GUIDELINES FOR TEXT KERNING:


Letter Spacing

Spacing "0 pt." Minimum

Letter Spacing

Spacing "20 pt." Maximum (Recommended Standard)

Line Spacing

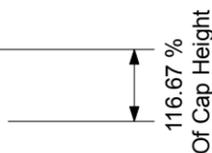

Spacing Between Lines In Paragraph Format 116.67 % Of Letter Height.

COLOR SCHEDULE: EXTERIOR SIGNAGE


| No. | Color No. | Color Name | Finish |
|-----|------------------------|------------------------|------------|
| 1 | MP10273 | Blue | Semi gloss |
| 2 | MP04516 | Gold | Semi gloss |
| 3 | Davis Concrete Color | Mesa Buff 2lbs. 5447 | |
| 4 | 3M Scotchlite EGR 3290 | White Reflective Vinyl | |
| 5 | MP-White | White | Semi gloss |
| 6 | 3M Scotchcal 7125-10 | White | |
| 7 | MP18100 | Light Silver | Semi gloss |
| 8 | MP20140 | Gray | Semi gloss |
| 9 | MP07694 | Light Blue | Semi gloss |
| 10 | 3M Scotchcal 7125-13 | Red | |
| 11 | 3M Scotchlite EGR 3275 | Blue Reflective Vinyl | |
| 12 | MP04705 | Terra Cotta | Semi gloss |
| 13 | 3M Scotchlite EGR 3271 | Yellow | |
| 14 | 3M Scotchlite EGR 3272 | Red | |
| 15 | 3M Scotchcal 7125-12 | Black | |


COLOR SCHEDULE: BUILDING INTERIOR SIGNAGE

| No. | Color No. | Color Name | Finish |
|-----|--------------------|---------------|------------------------|
| 1 | MP13915 | Gray | Satin Finish |
| 2 | MP 06668 | Light Gray | Satin Finish |
| 3 | 3M Scotchcal Vinyl | 7125-10 White | |
| 4 | 3M Scotchcal Vinyl | 7125-13 Red | |
| 5 | MP White | White | Satin Finish |
| 6 | Gravoply II 21927 | Gray/white | |
| 7 | Aluminum | | Light Sandblast Finish |

MP = Matthews Paint

EGR = 3M Engineering Grade Reflective Vinyl

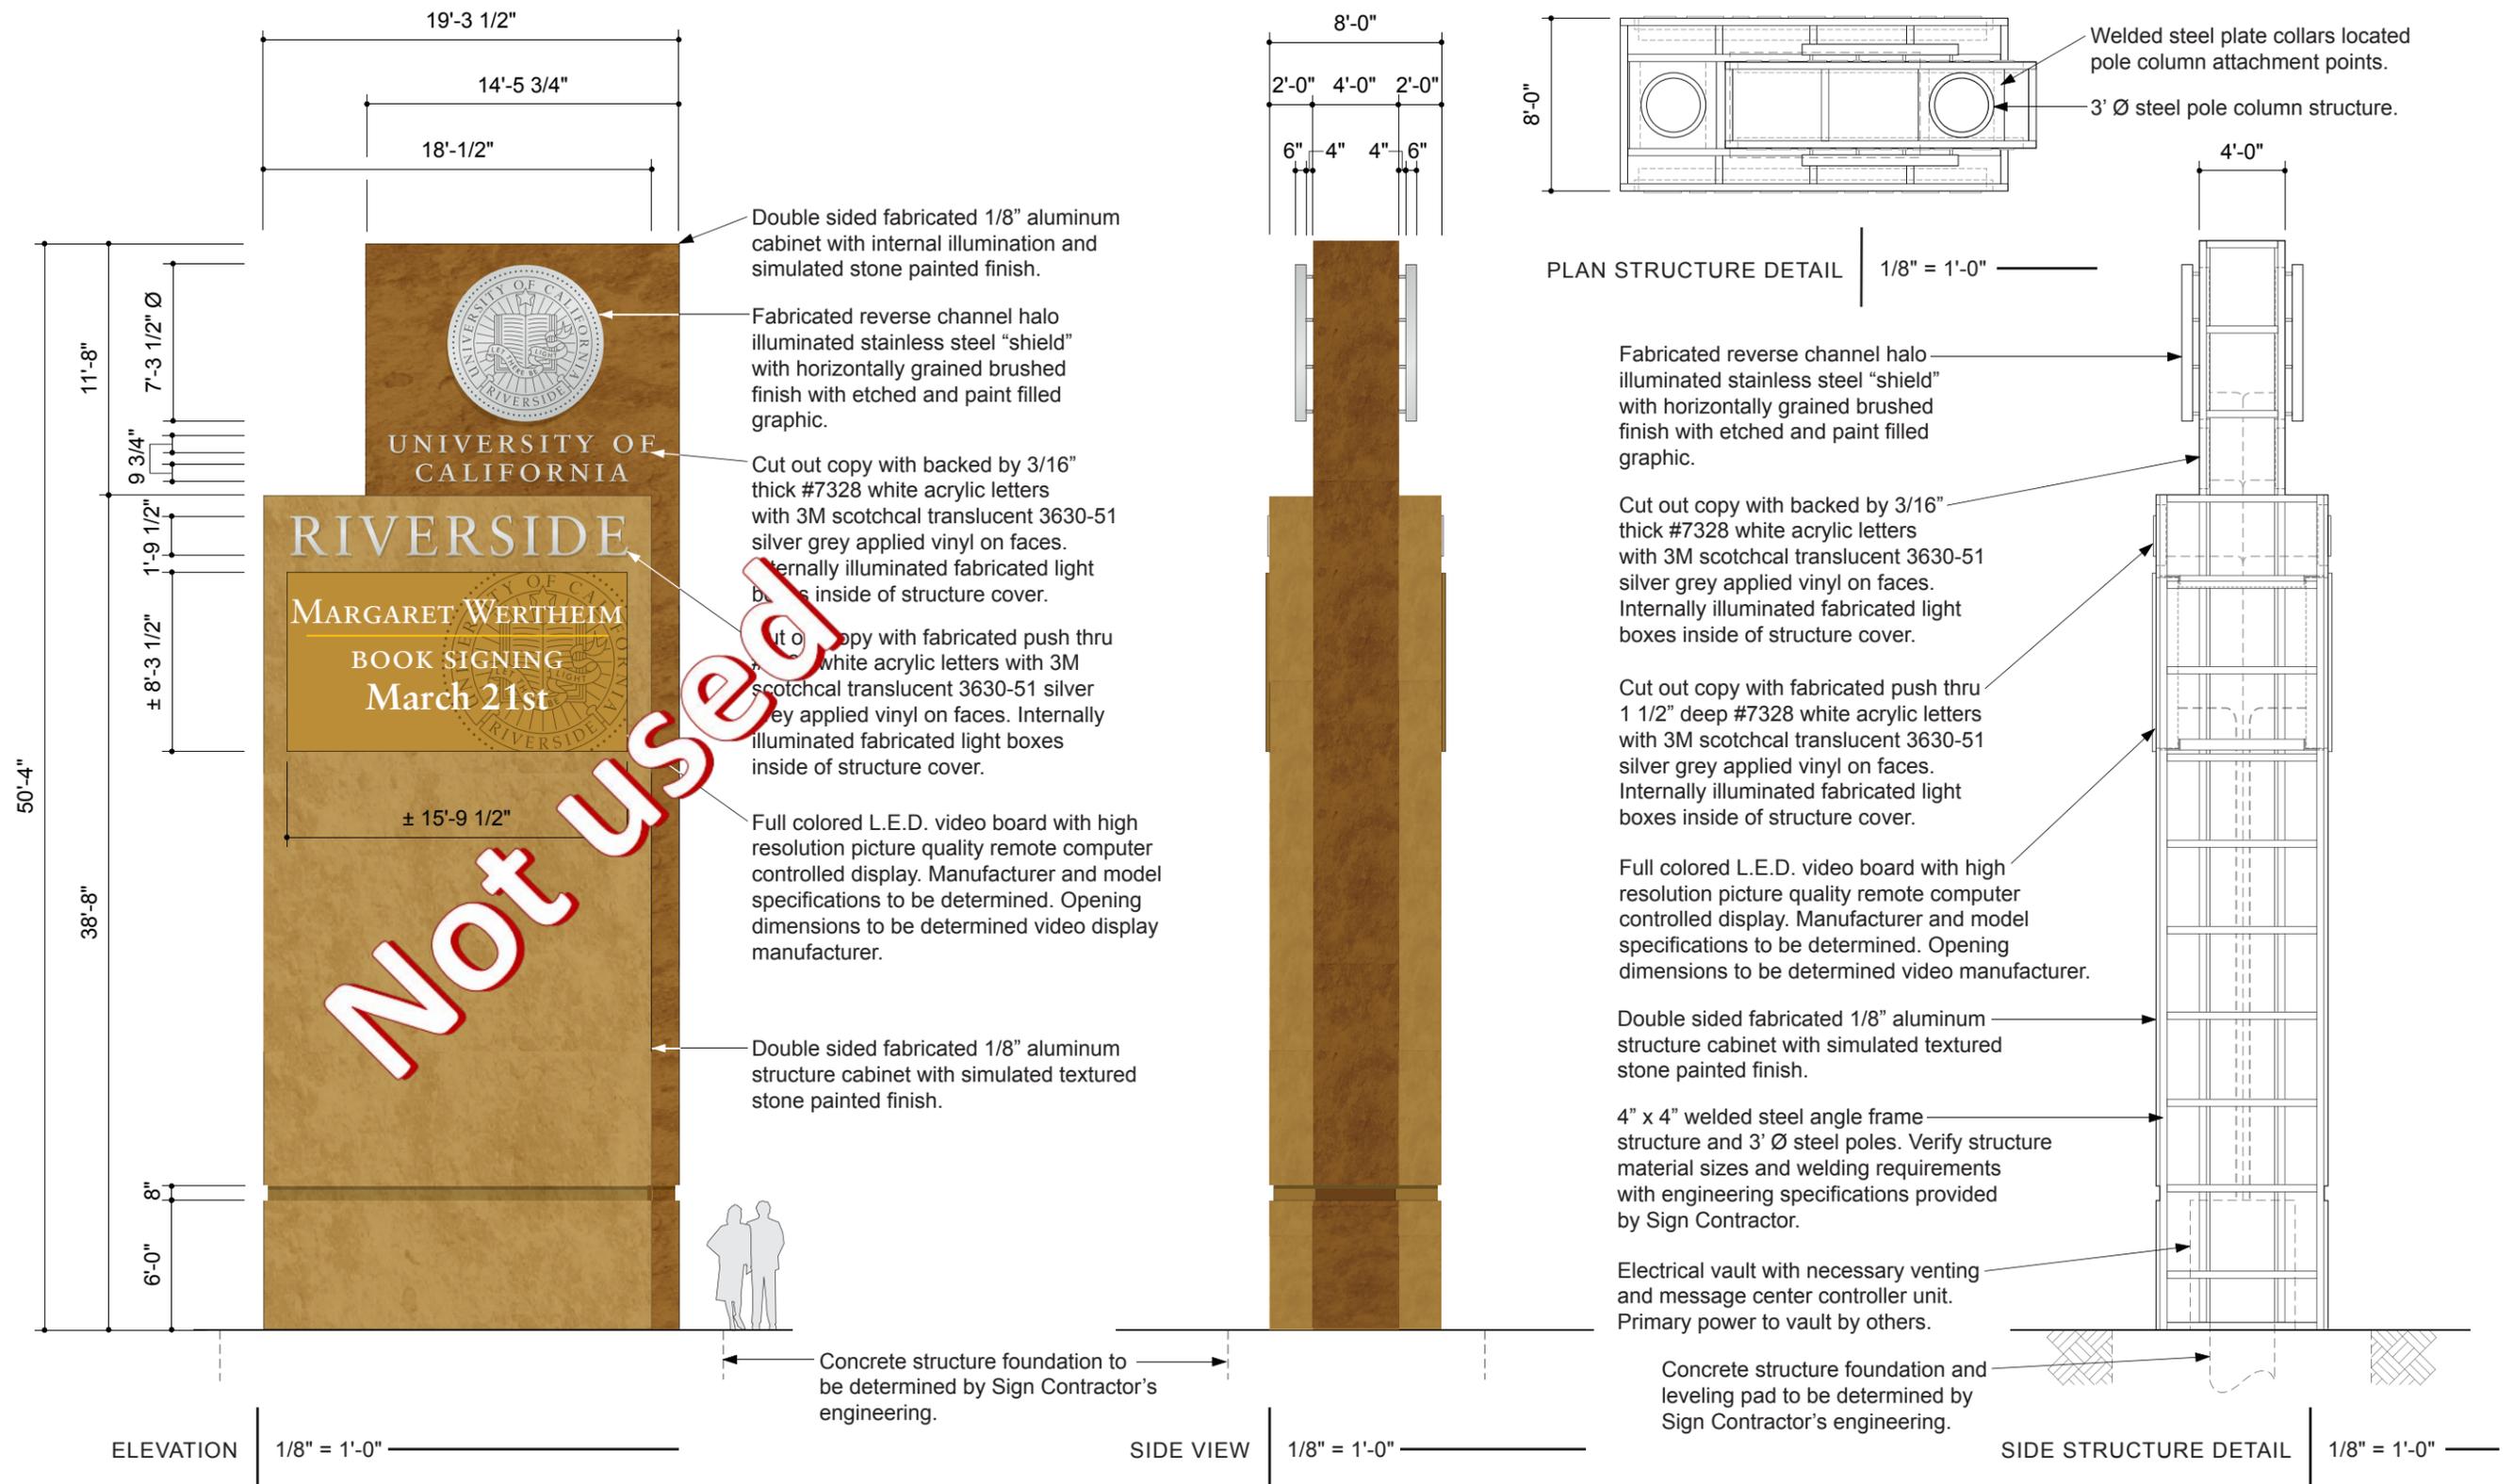

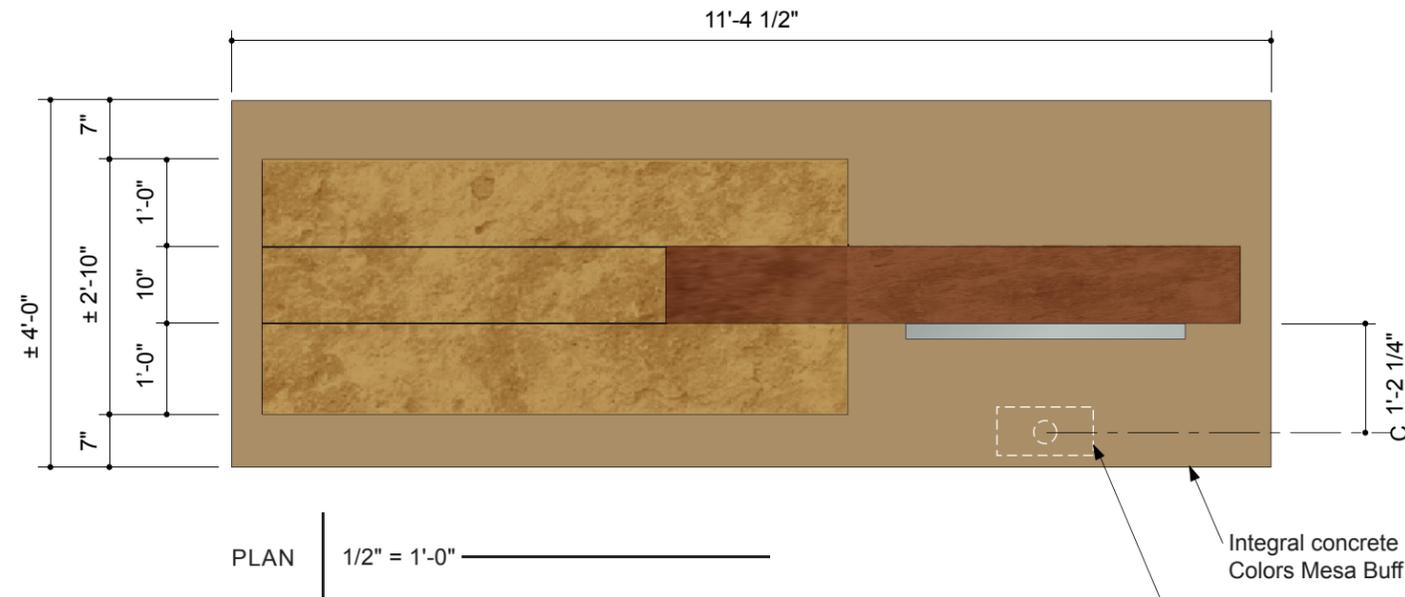

W11 SINGLE SIDE SIGN ORIENTATION: Not To Scale

- Single Faced - (Location sheet 2.6) Linden St. @ Canyon Crest Dr.
- Single Faced - (Location sheet 2.12) Valencia Hills Dr. @ Big Springs Rd.
- Single Faced - (Location sheet 2.14) Campus Dr. @ Canyon Crest Dr.



Flat cut out horizontally brushed stainless steel letters with 1/4" stainless steel spacer sleeves and blind studs.

Fabricated 2" thick stainless steel "shield" with light horizontal brushed finish. Graphics to be etched 1/32" deep and paint filled.


1" deep Incised letters with painted finish inside of letters. Paint color Matthews MP10217 Brown.


Full colored L.E.D. video board with high resolution picture quality remote computer controlled display. Manufacturer and model specifications to be determined. Opening dimensions to be determined video display manufacturer.

Fabricated aluminum frame structure with stone facing. Dark red / brown facing to be morning glory stone with oil rubbed finish. Light ochre / brown facing to be sunflower stone with oil rubbed finish.

Arida fluorescent outdoor architectural lighting. Sign Contractor to minimize fixture above grade as possible. (or equivalent lighting product)

Concrete footing / integral colored mow pad to be determined by Sign Contractor's engineering.

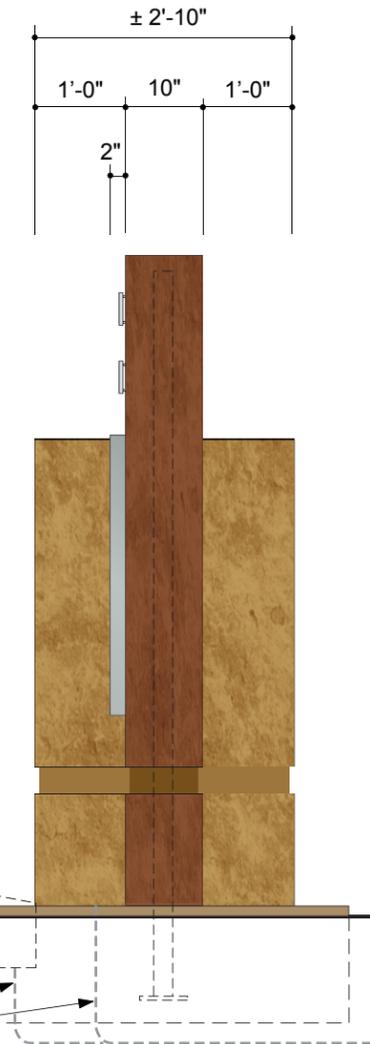


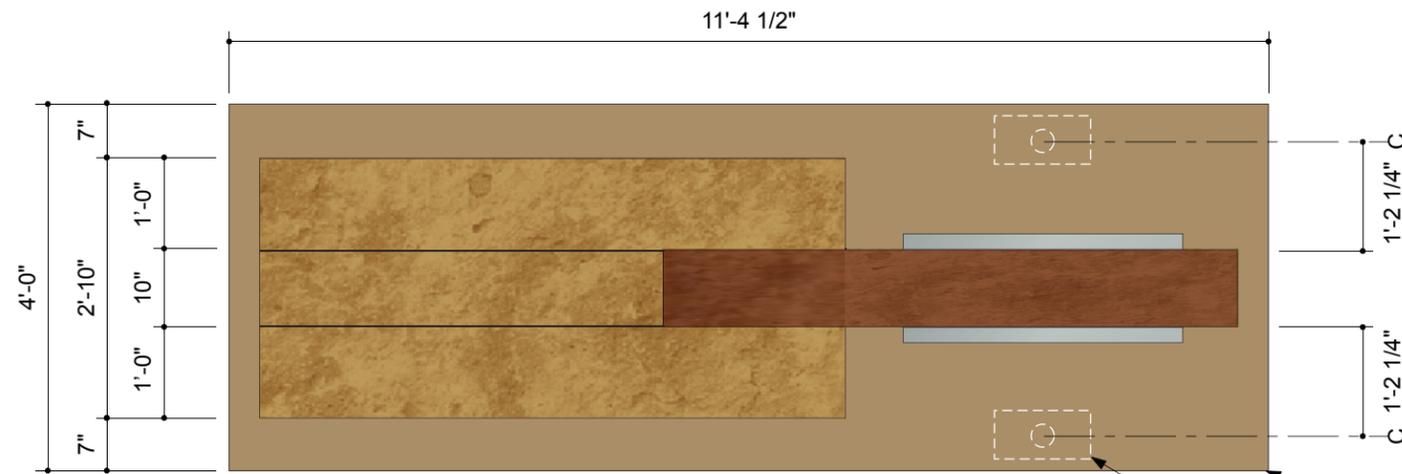

PLAN 1/2" = 1'-0"




W11 DOUBLE SIDED SIGN ORIENTATION: Not To Scale
 Double Faced - (Location sheet 2.6) Linden St. @ Flower St.
 Double Faced - (Location sheet 2.10) University Dr. @ W. Campus Dr.

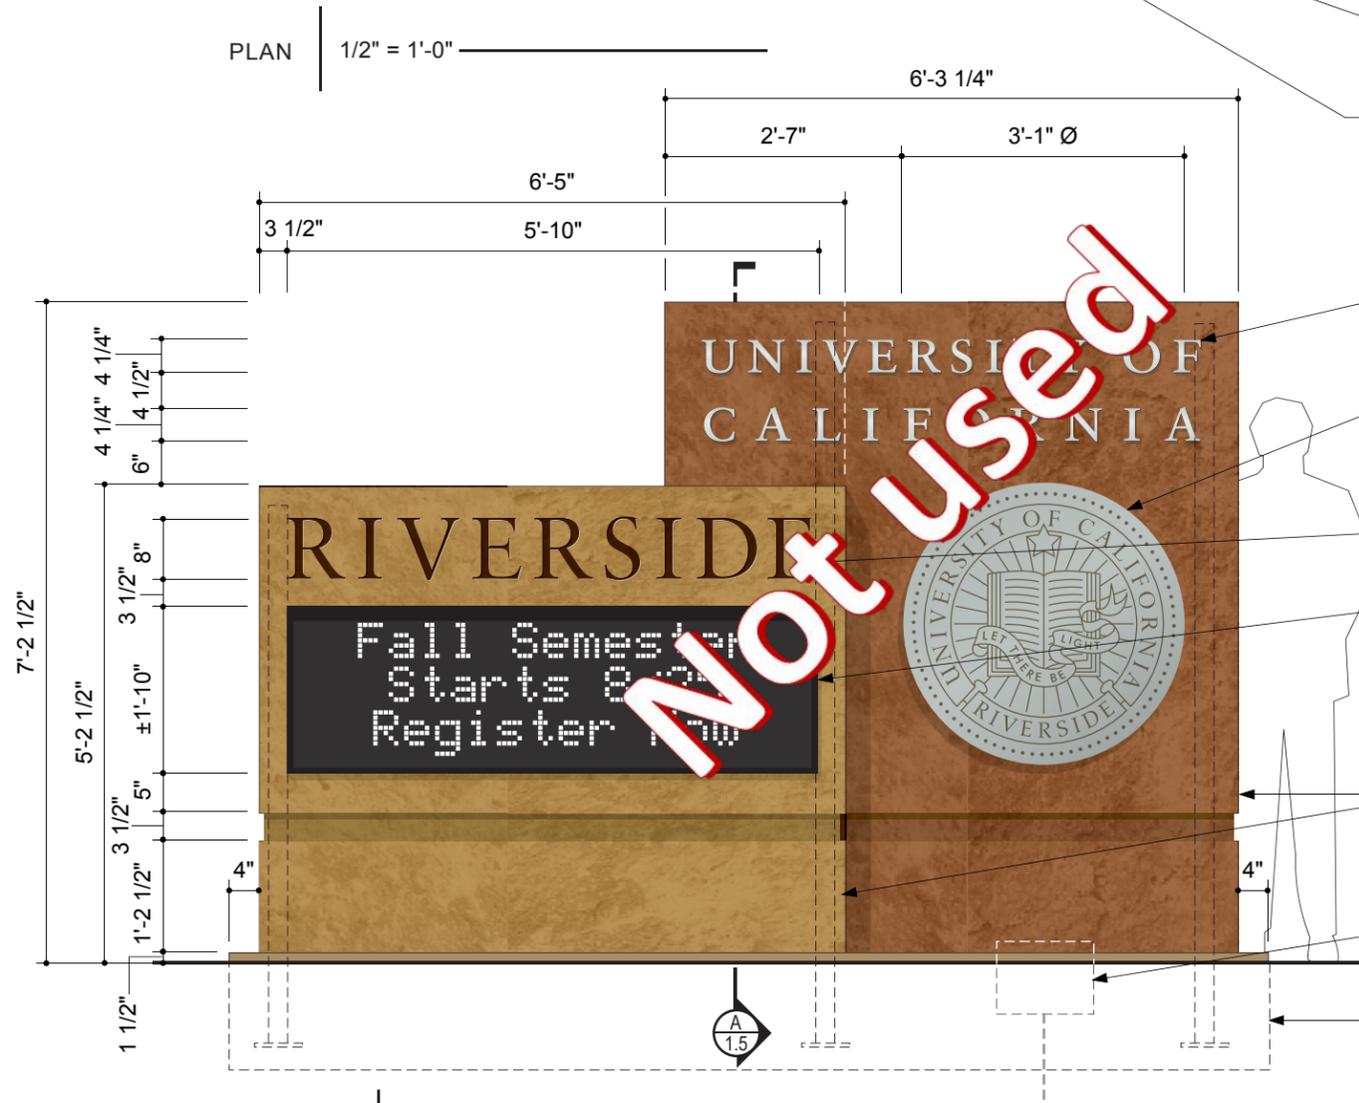


ELEVATION 1/2" = 1'-0"

- Integral concrete color Davis Concrete Colors Mesa Buff 2lbs 5447.
- Exterior lighting to front illuminate "Shields".
- Flat cut out horizontally brushed stainless steel letters with 1/4" stainless steel spacer sleeves and blind studs.
- Fabricated 2" thick stainless steel "shield" with light horizontal brushed finish. Graphics to be etched 1/32" deep and paint filled.
- 1" deep Incised letters with painted finish inside of letters. Paint color Matthews MP10217 Brown.
- Full colored L.E.D. video board with high resolution picture quality remote computer controlled display. Manufacturer and model specifications to be determined. Opening dimensions to be determined video display manufacturer.
- Fabricated aluminum frame structure with stone facing. Dark red / brown facing to be morning glory stone with oil rubbed finish. Light ochre / brown facing to be sunflower stone with oil rubbed finish.
- Arida fluorescent outdoor architectural lighting. Sign Contractor to minimize fixture above grade as possible. (or equivalent lighting product)
- Concrete footing / integral colored mow pad to be determined by Sign Contractor's engineering.
- Primary power to sign location by UCR.

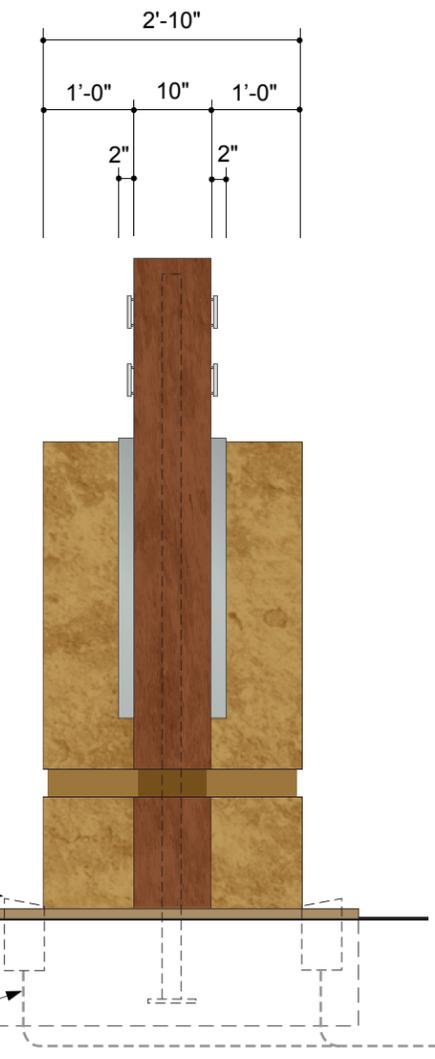

SIDE 1/2" = 1'-0"

NOT USED

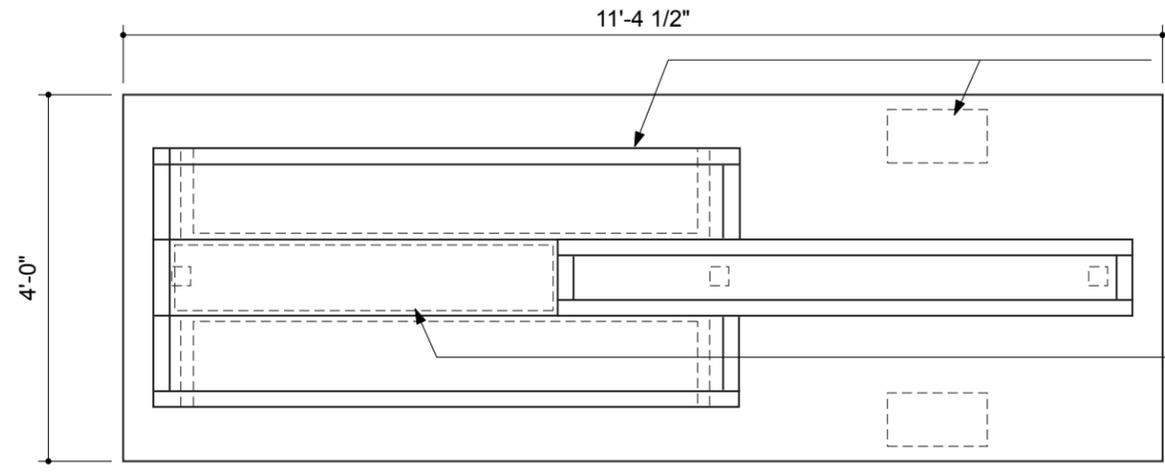


PLAN 1/2" = 1'-0"

For single faced displays cover message display opening with stone panel and eliminate exterior lighting on back side only.

Flush aluminum service access for message display controller. Venting for excess heat to be determined by message display manufacturer. Use tamperproof fastening or locking device for panel access.

General Notes:

1. Sign construction details conceptual only, sign contractor's engineering to take precedence over any drawing details.
2. Stone and or color matches can be purchased through Contractor's Tile Mart, 1063 E. Las Tunas Dr., San Gabriel, Calif. 91776 - Tel. (626) 287-6483 - Attn. Albert Maloof

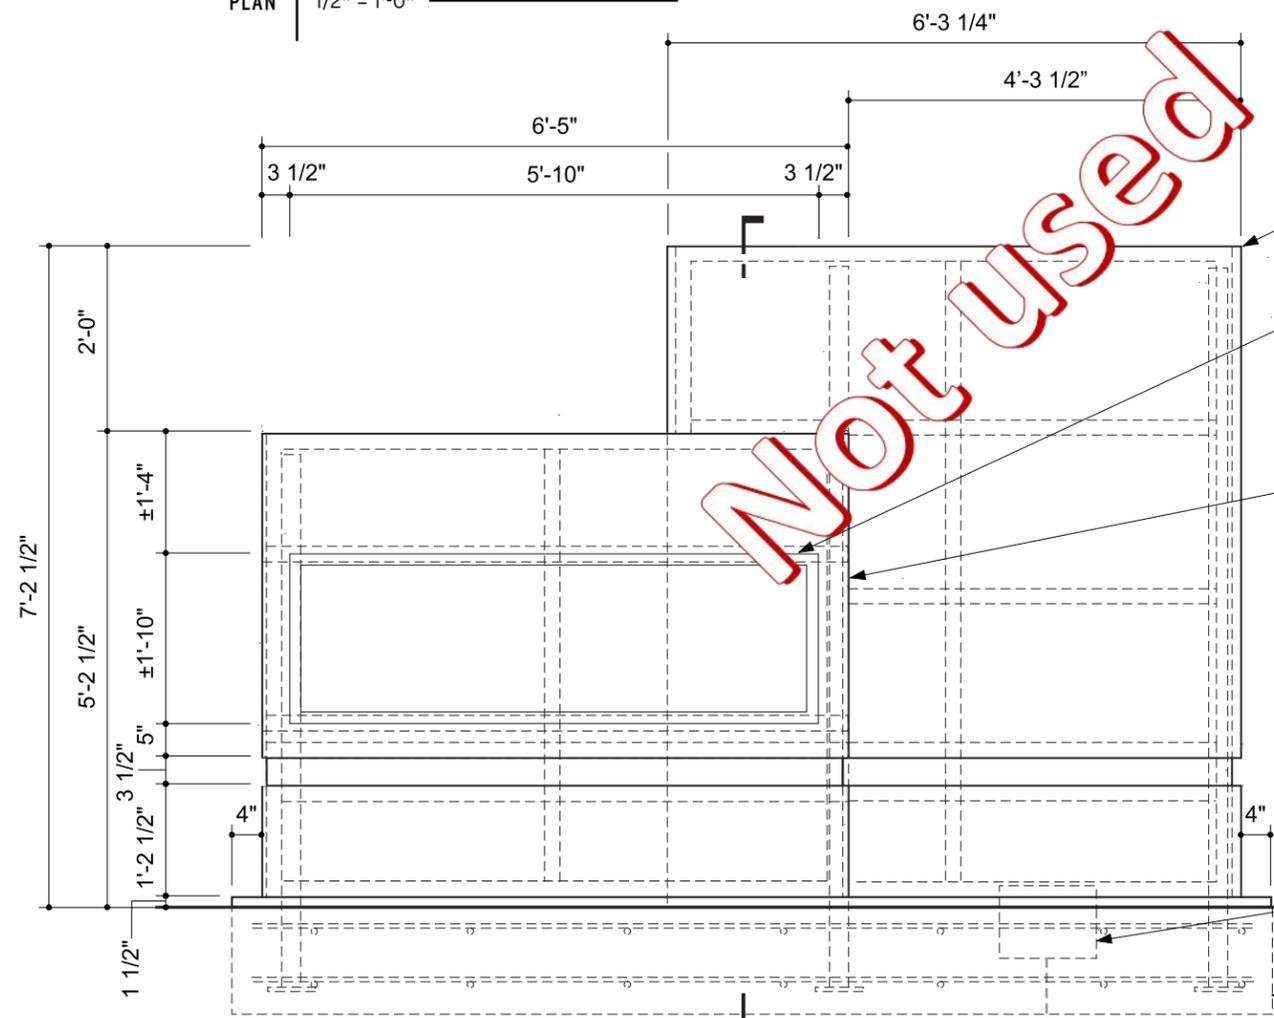

ELEVATION 1/2" = 1'-0"

Not Used

Flat cut out horizontally brushed stainless steel letters with 1/4" stainless steel spacer sleeves and blind studs.

Fabricated aluminum frame structure with stone facing. stone facing. Light ochre / brown facing to be sunflower stone with oil rubbed finish.

Full colored L.E.D. video board with high resolution picture quality remote computer controlled display. Manufacturer and model specifications to be determined. Opening dimensions to be determined video display manufacturer.

Fabricated aluminum frame structure with stone facing. Dark red / brown facing to be morning glory stone with oil rubbed finish.

Threaded stainless steel studs / anchor pins with masonry holes filled with epoxy sealant.

3" square steel tubes with 3/8" thick bottom plate. Verify with Sign Contractor's engineering.

Perforated aluminum around display for venting painted black.


Stainless steel "Z" clips / brackets with fasteners to support stone.

2" x 2" x 1/4" steel angle welded frame structure to support stone and electronic message display.


Arida fluorescent outdoor architectural lighting. Sign Contractor to minimize fixture above grade as possible. (or equivalent lighting product)


Concrete footing / integral colored mow pad to be determined by Sign Contractor's engineering.

Primary power to sign location by UCR.

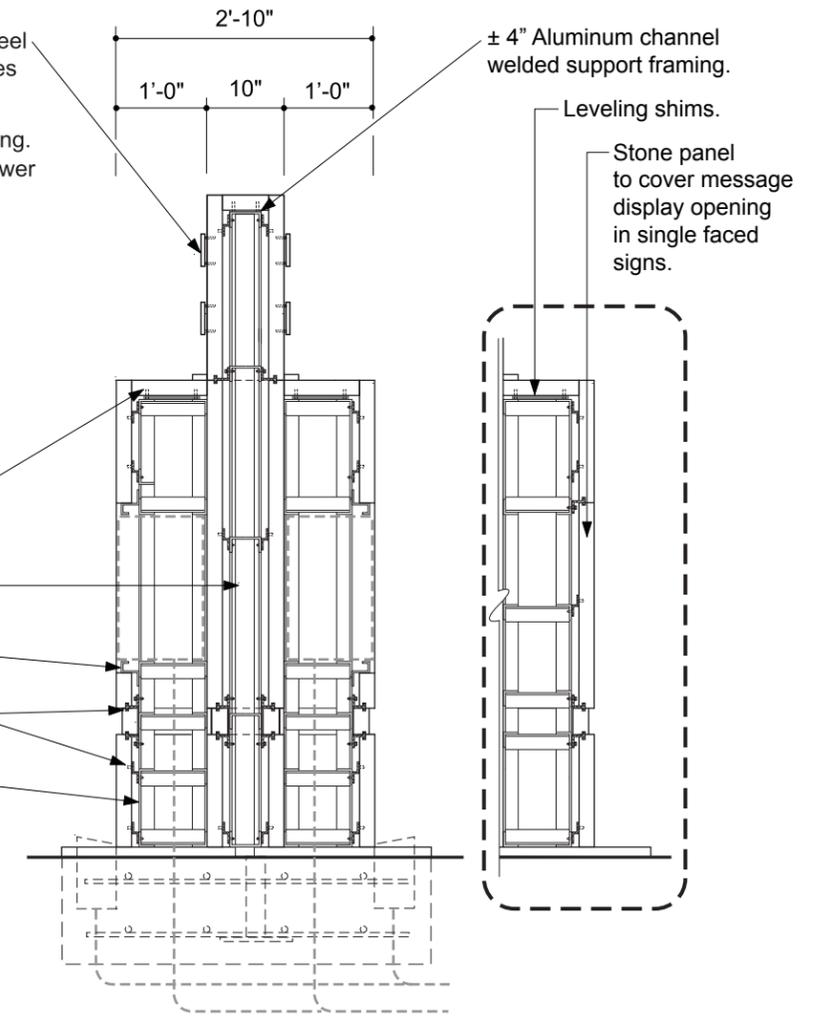


DOUBLE SIDED SECTION 1/2" = 1'-0" A

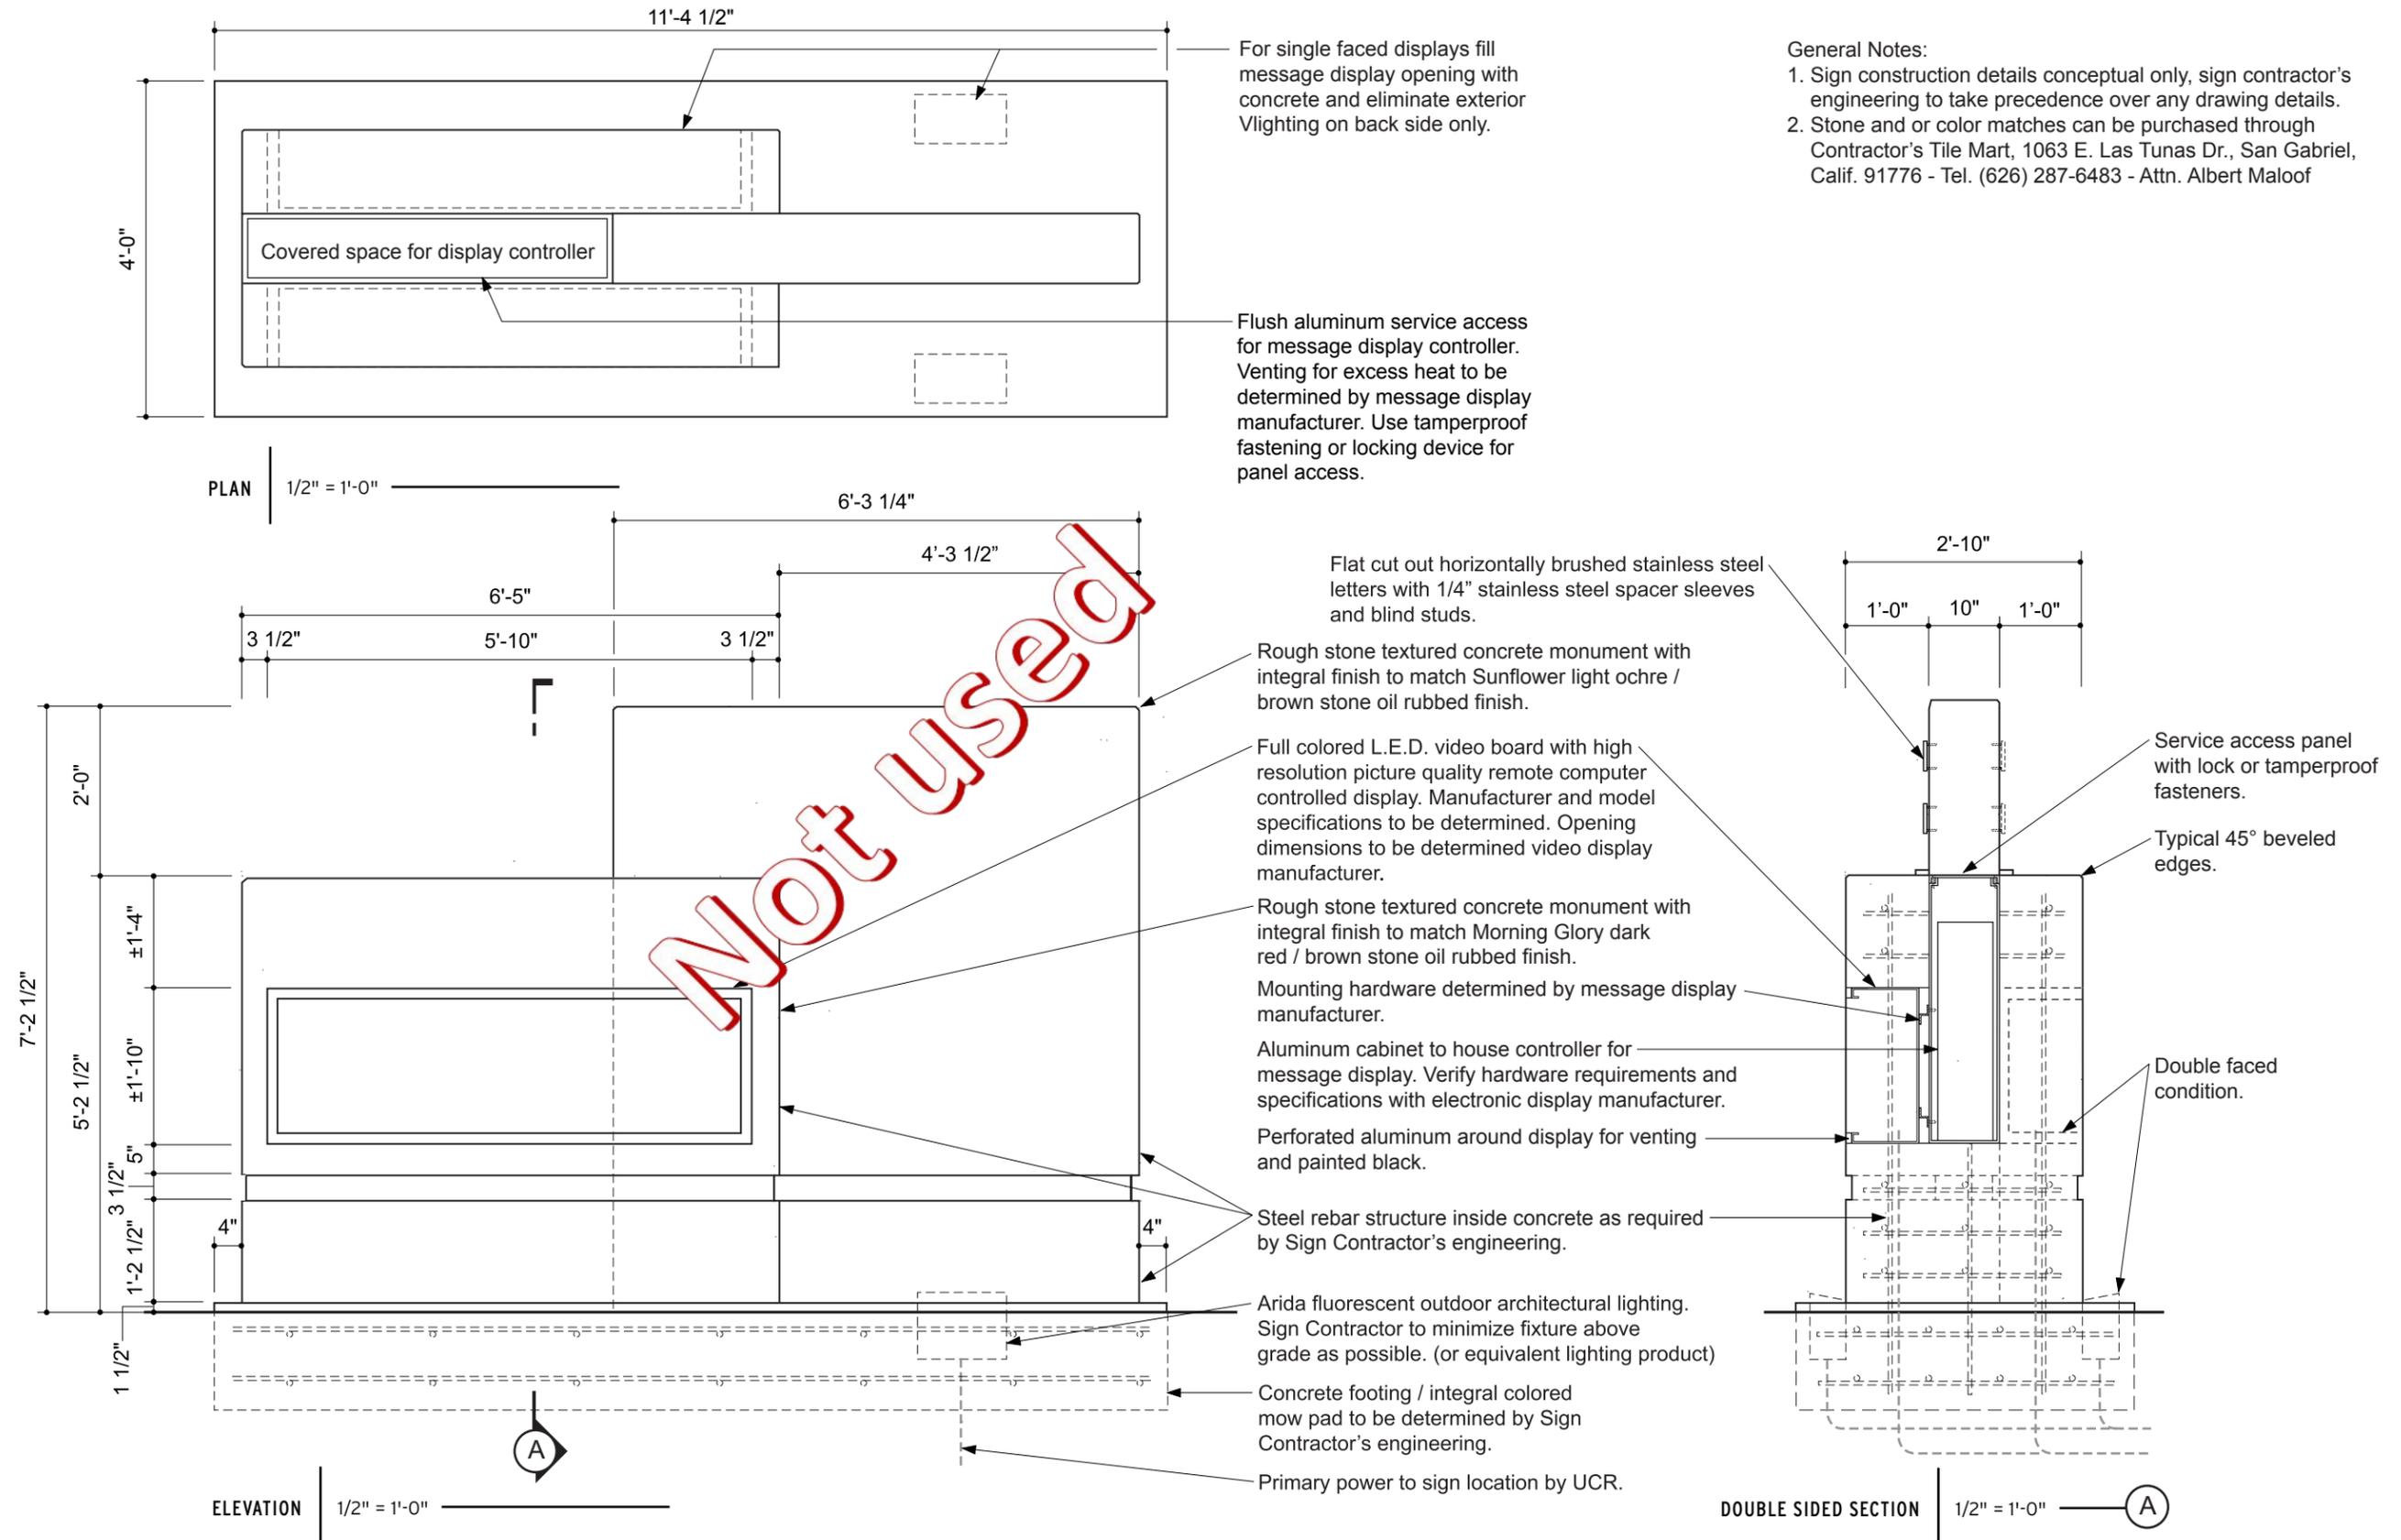


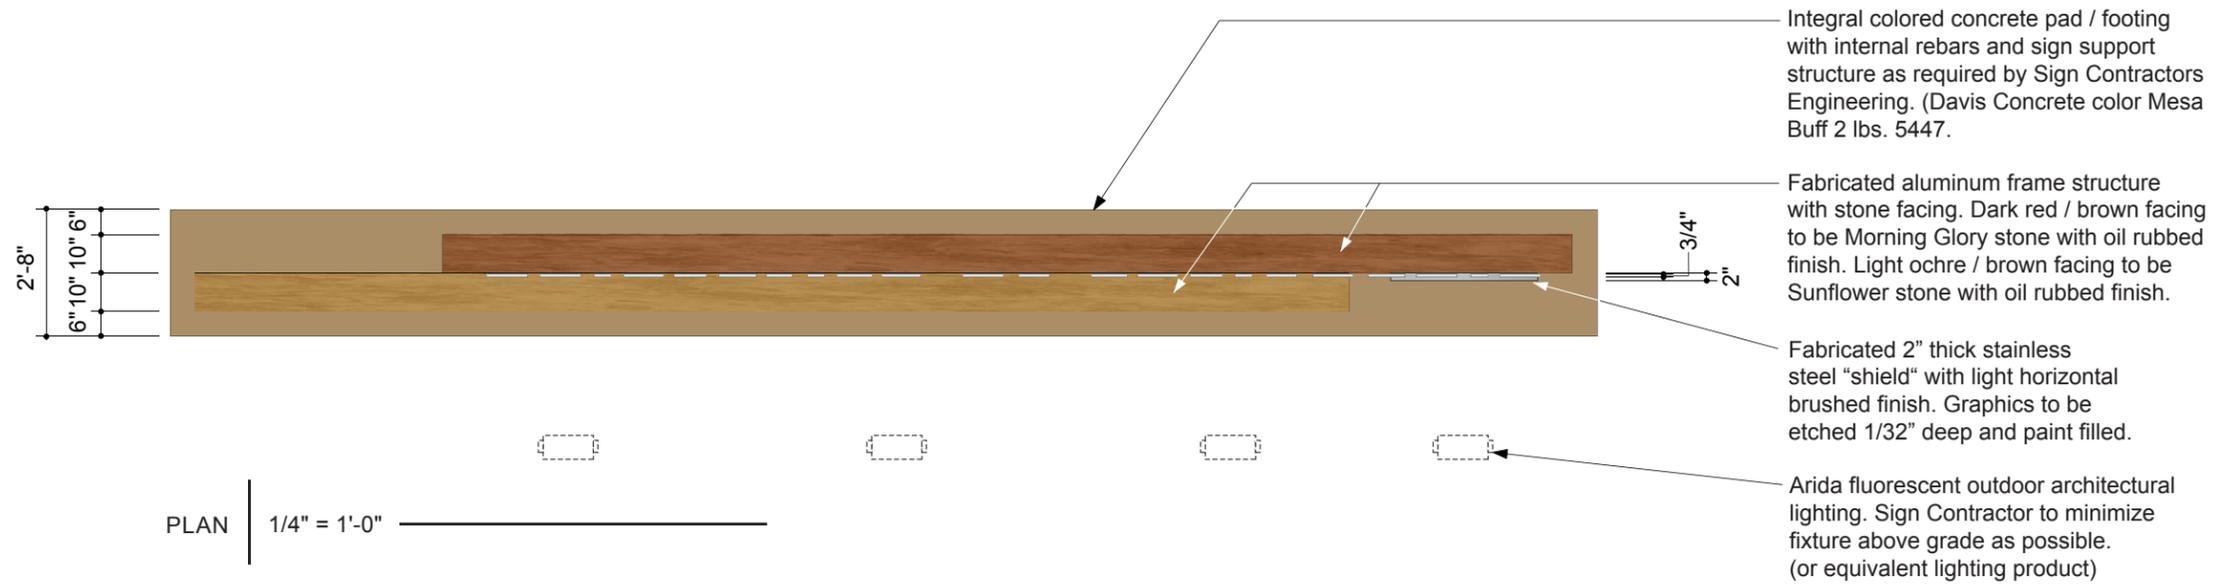

Not used

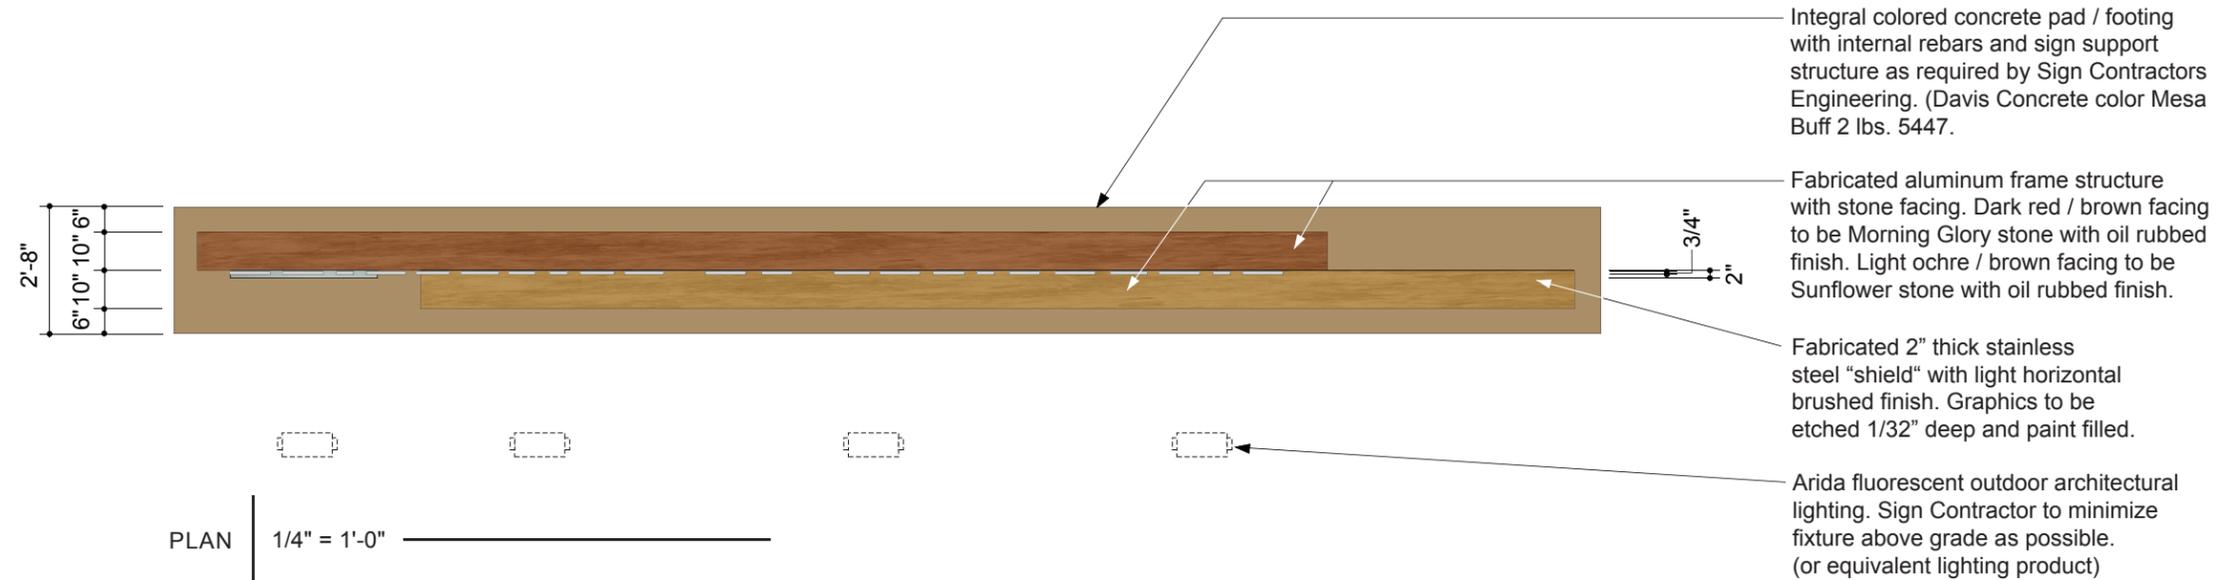

- 3/4" thick flat cut out horizontally brushed stainless steel letters with 1/4" stainless steel spacer sleeves and blind studs.
- 1" deep Incised letters with painted Matthews MP10217 Brown.
- Exterior lighting.
- Primary power to location by UCR.
- Concrete footing / integral colored mow pad to be determined by Sign Contractor's engineering.

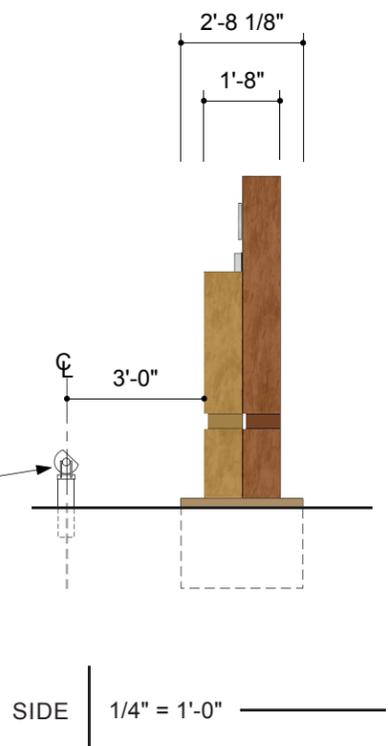

Not used


Not Used



East side of Canyon Crest Dr. - (1) single faced sign

Fabricated 2" thick stainless steel "shield" with light horizontal brushed finish. Graphics to be etched 1/32" deep and paint filled.

ELEVATION 3/16" = 1'-0" W16 Single Faced - (Location sheet 2.18) MLK Jr. Blvd. @ Canyon Crest Dr.

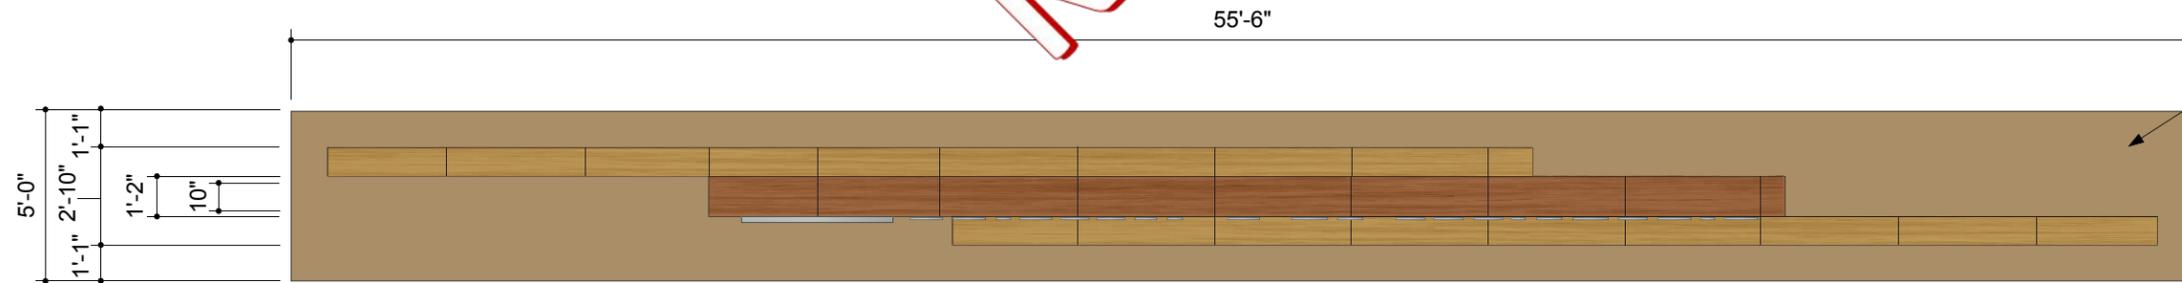


PLAN 3/16" = 1'-0"

Fabricated aluminum frame structure with stone facing. Dark red / brown facing to be Morning Glory stone with oil rubbed finish. Light ochre / brown facing to be Sunflower stone with oil rubbed finish.

Integral colored concrete pad / footing with internal rebar and sign support structure as required by Sign Contractors Engineering. (Davis Concrete color Mesa Buff 2 lbs. 5447.

Arida fluorescent outdoor architectural lighting. Sign Contractor to minimize fixture above grade as possible. (or equivalent lighting product)

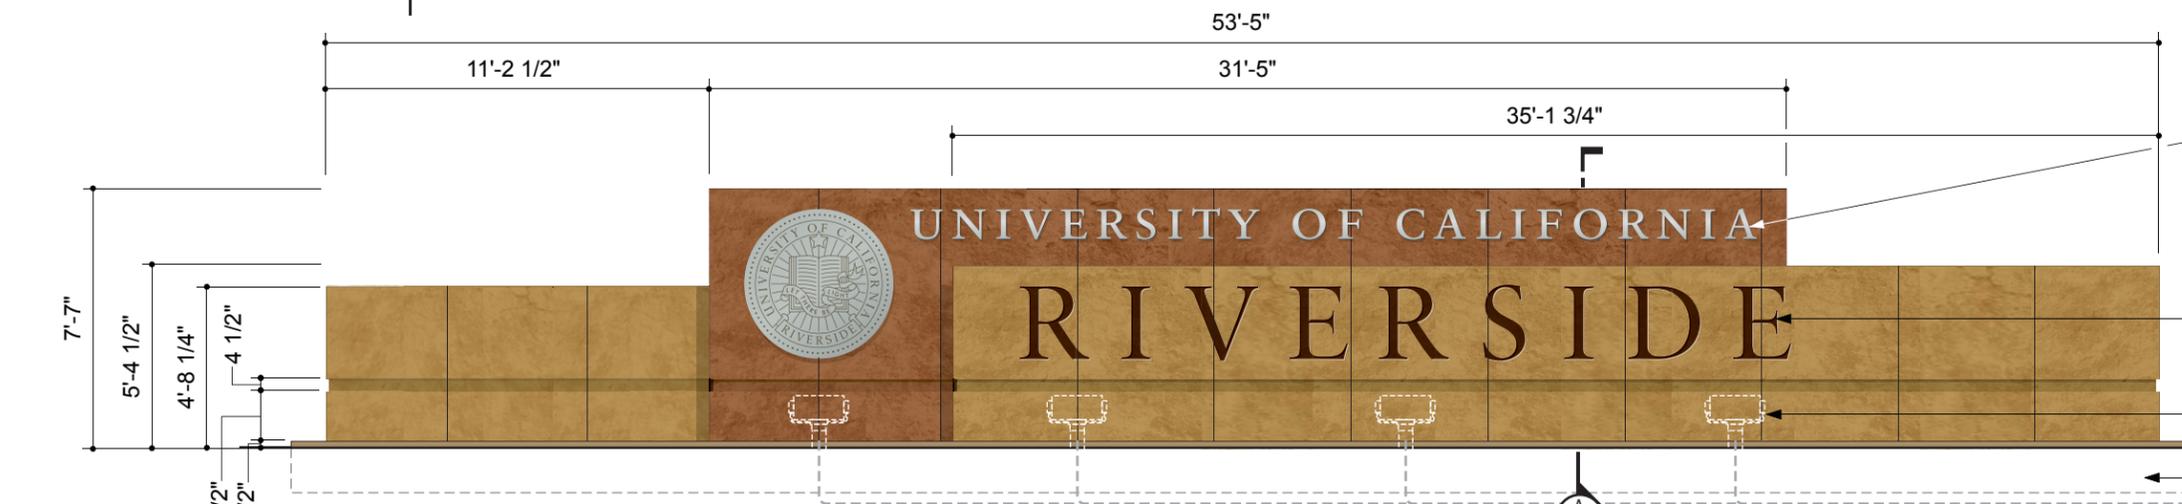

West side of Canyon Crest Dr. - (1) single faced sign

3/4" thick flat cut out horizontally brushed stainless steel letters with 1/4" stainless steel spacer sleeves and blind studs.


1" deep Incised letters with painted Matthews MP10217 Brown.

Exterior lighting.


Concrete footing / integral colored mow pad to be determined by Sign Contractor's engineering.


Primary power to sign location by UC Riverside.

ELEVATION 3/16" = 1'-0" W16 Single Faced - (Location sheet 2.18) MLK Jr. Blvd. @ Canyon Crest Dr.

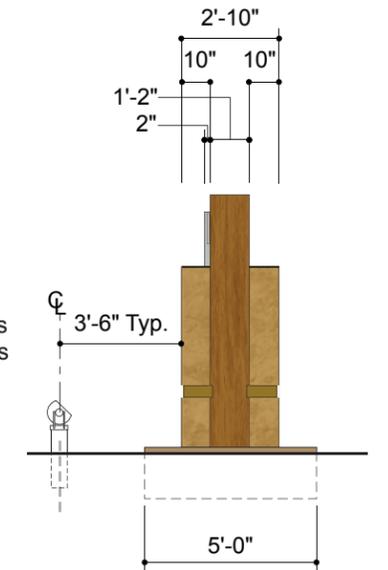

SIDE 3/16" = 1'-0"


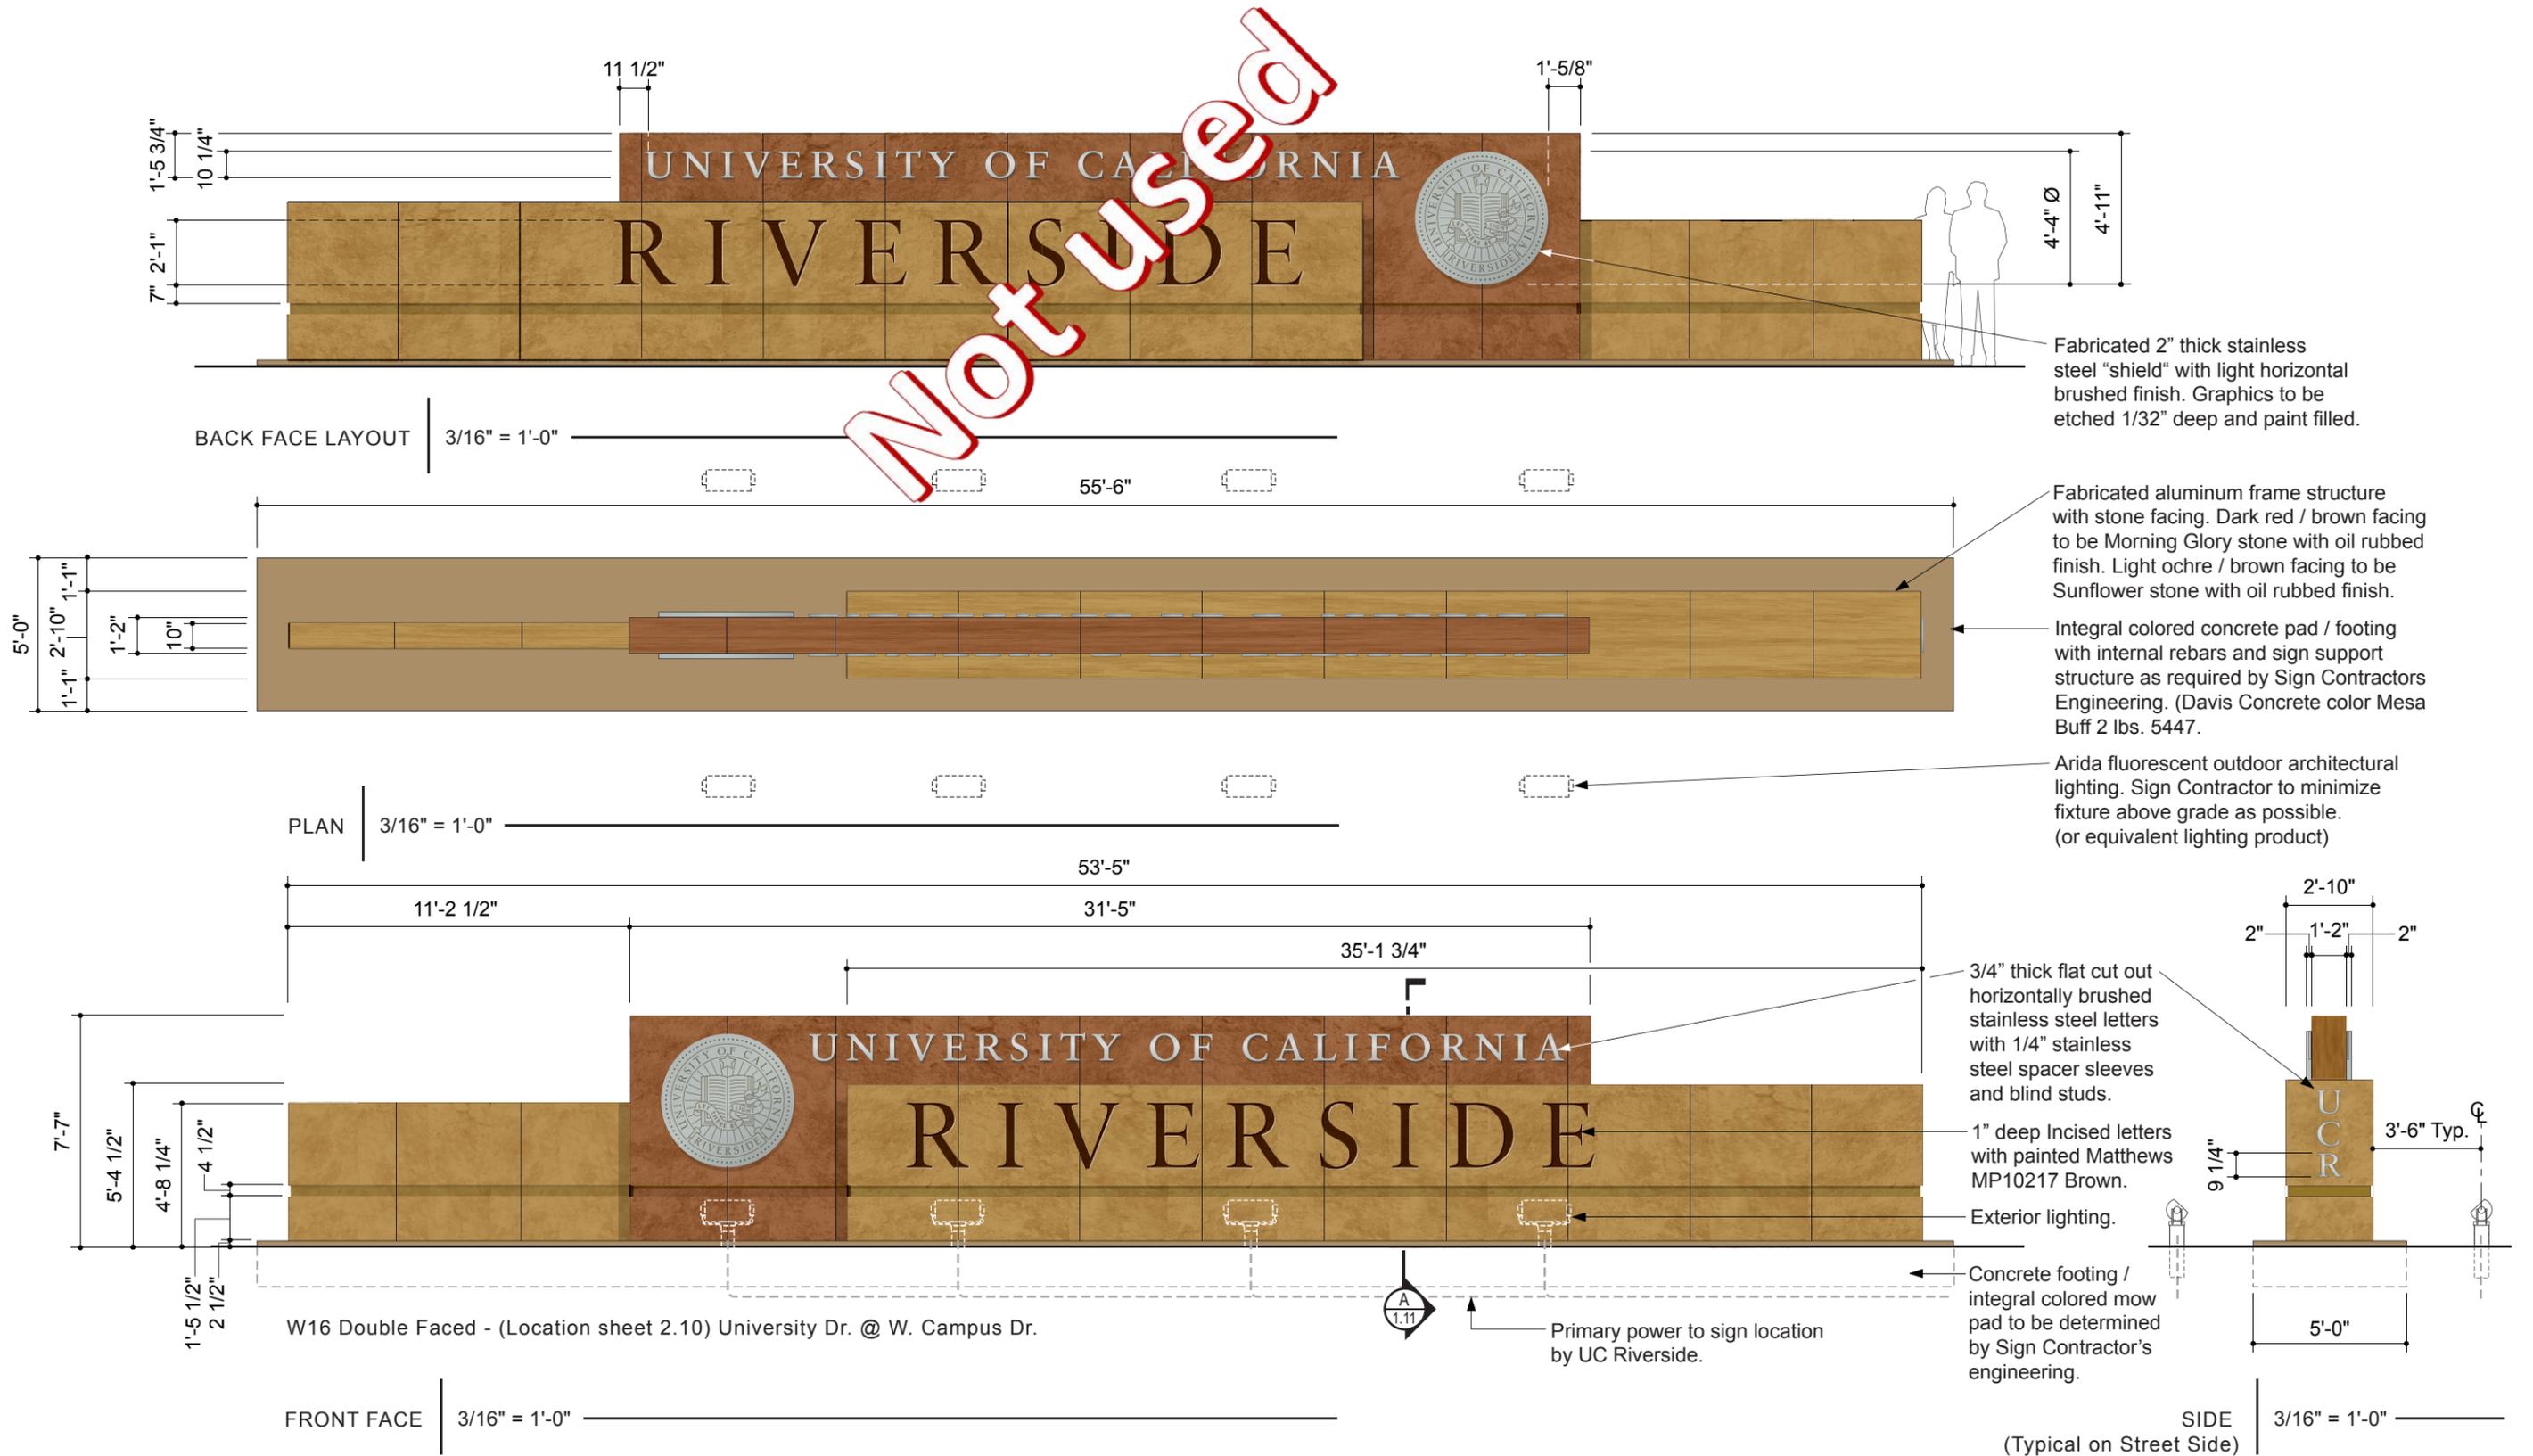


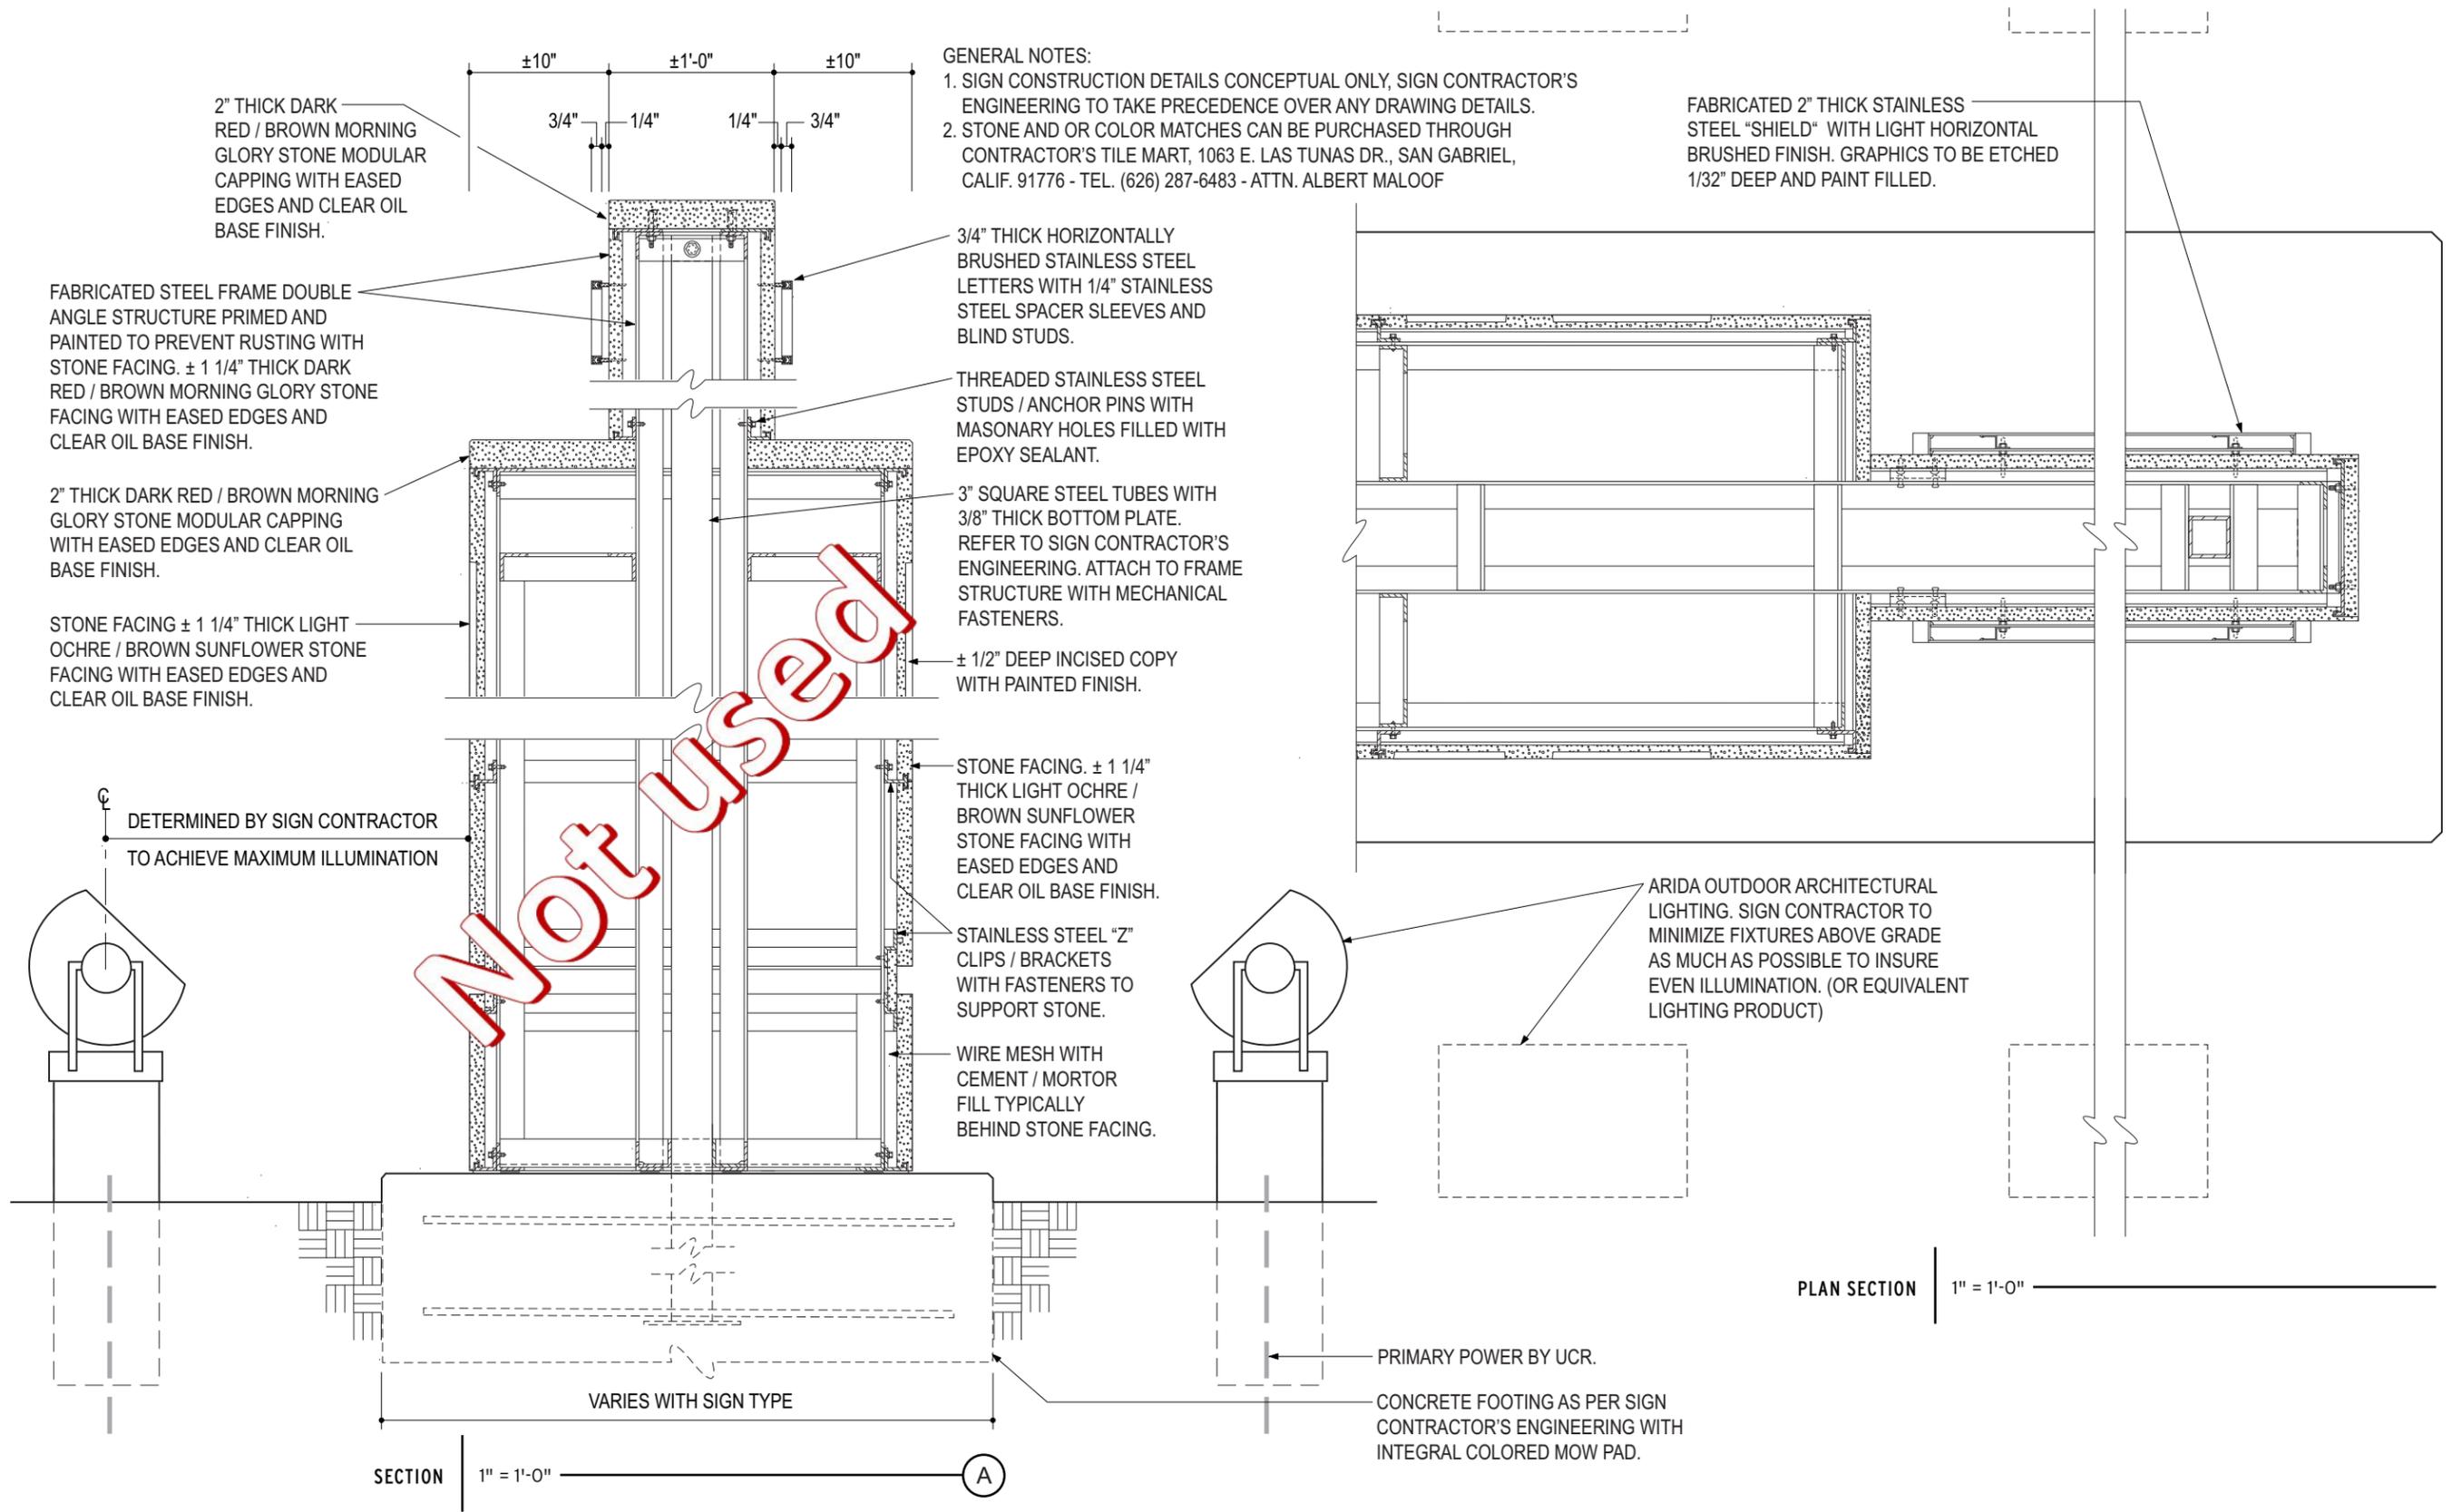


Not Used

GENERAL NOTES:


1. SIGN CONSTRUCTION DETAILS CONCEPTUAL ONLY, SIGN CONTRACTOR'S ENGINEERING TO TAKE PRECEDENCE OVER ANY DRAWING DETAILS.
2. STONE AND OR COLOR MATCHES CAN BE PURCHASED THROUGH CONTRACTOR'S TILE MART, 1063 E. LAS TUNAS DR., SAN GABRIEL, CALIF. 91776 - TEL. (626) 287-6483 - ATTN. ALBERT MALOOF

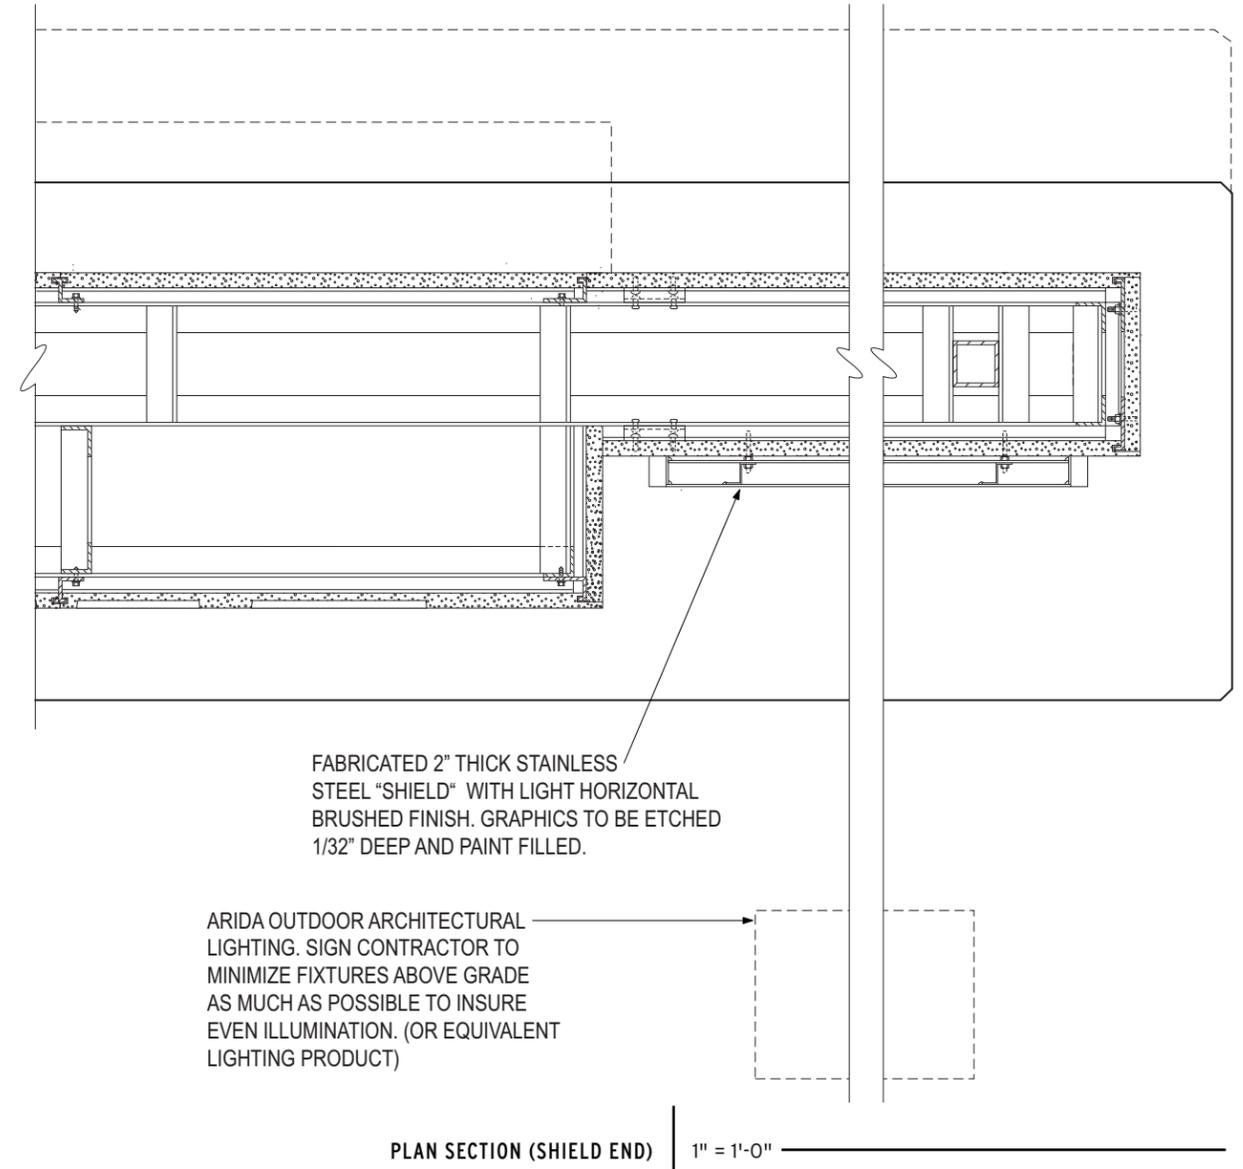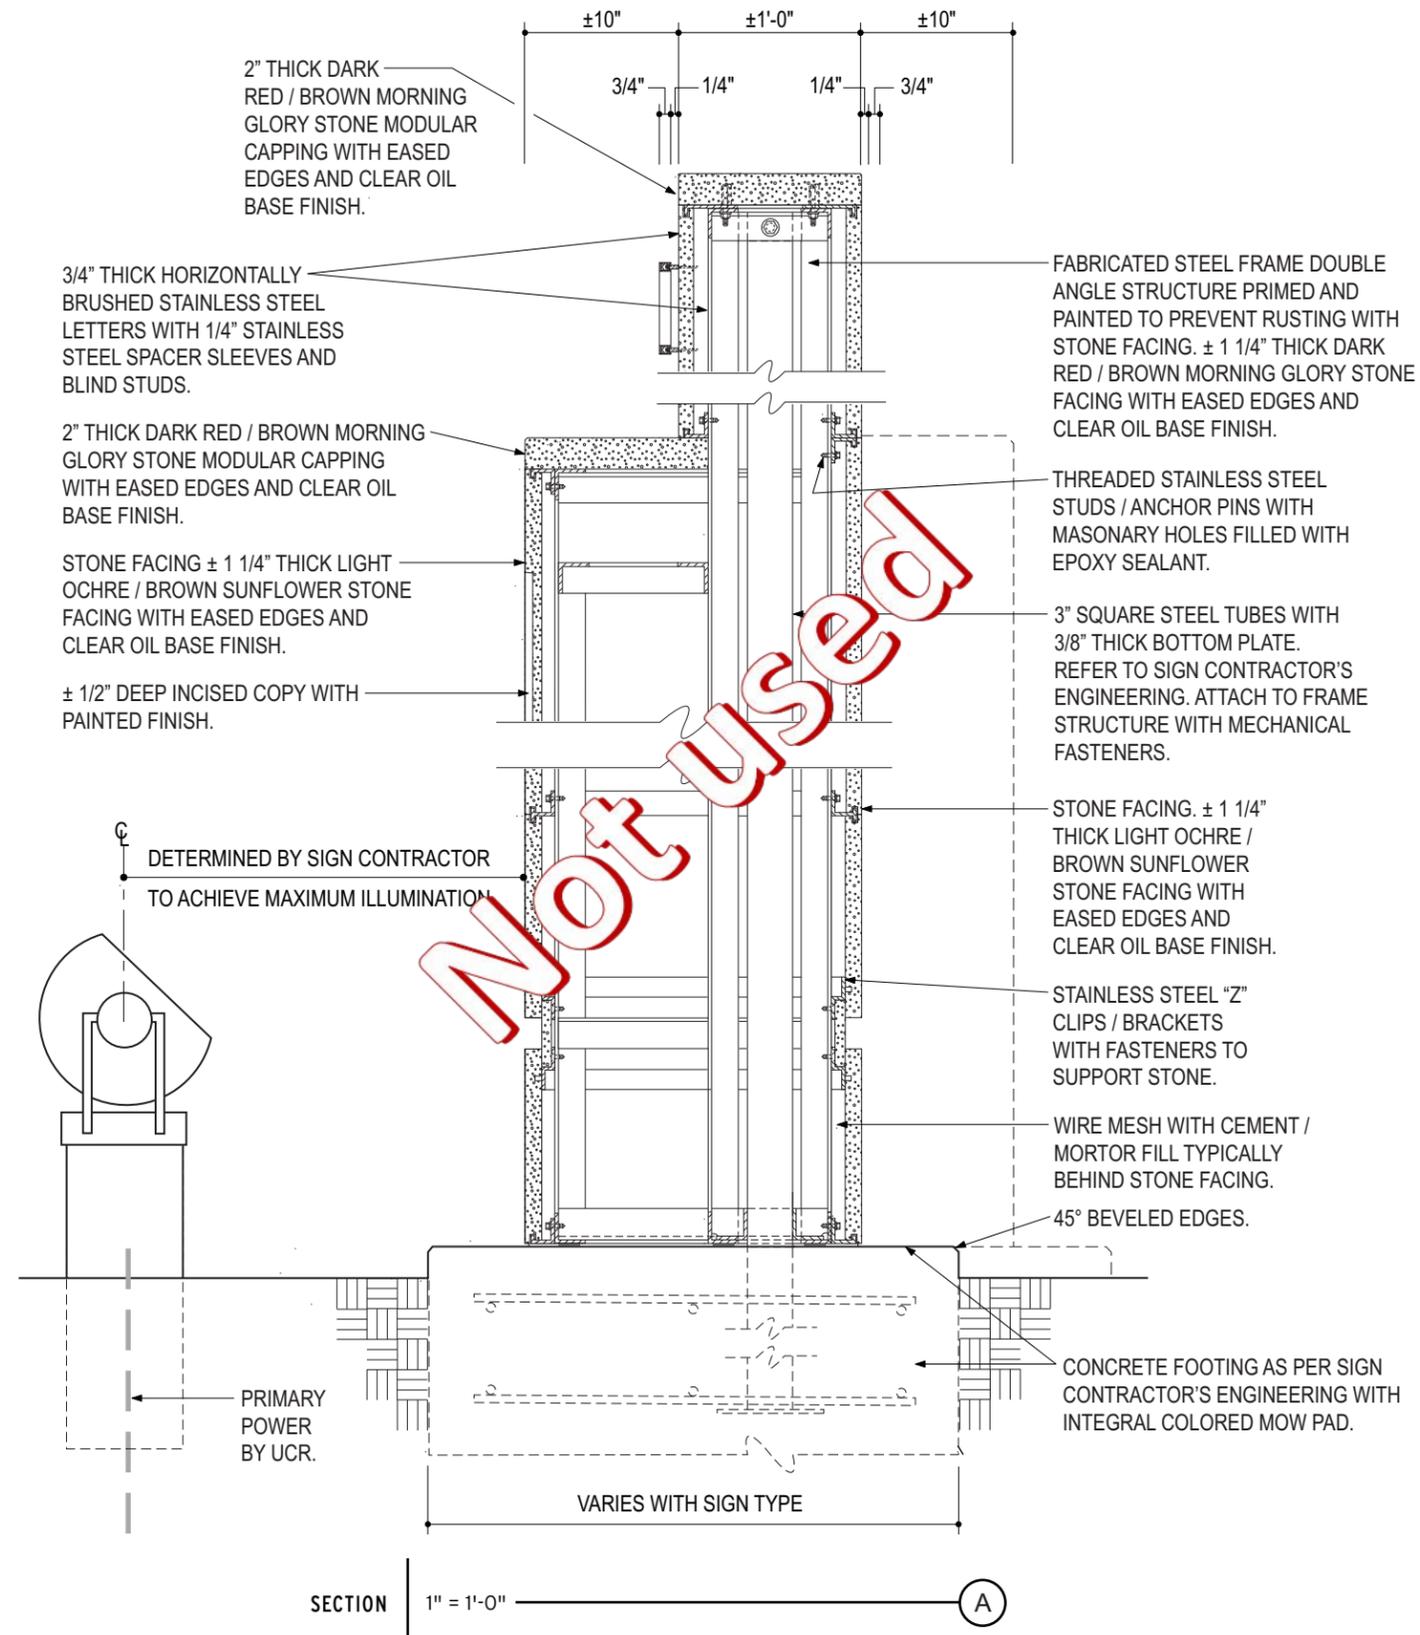

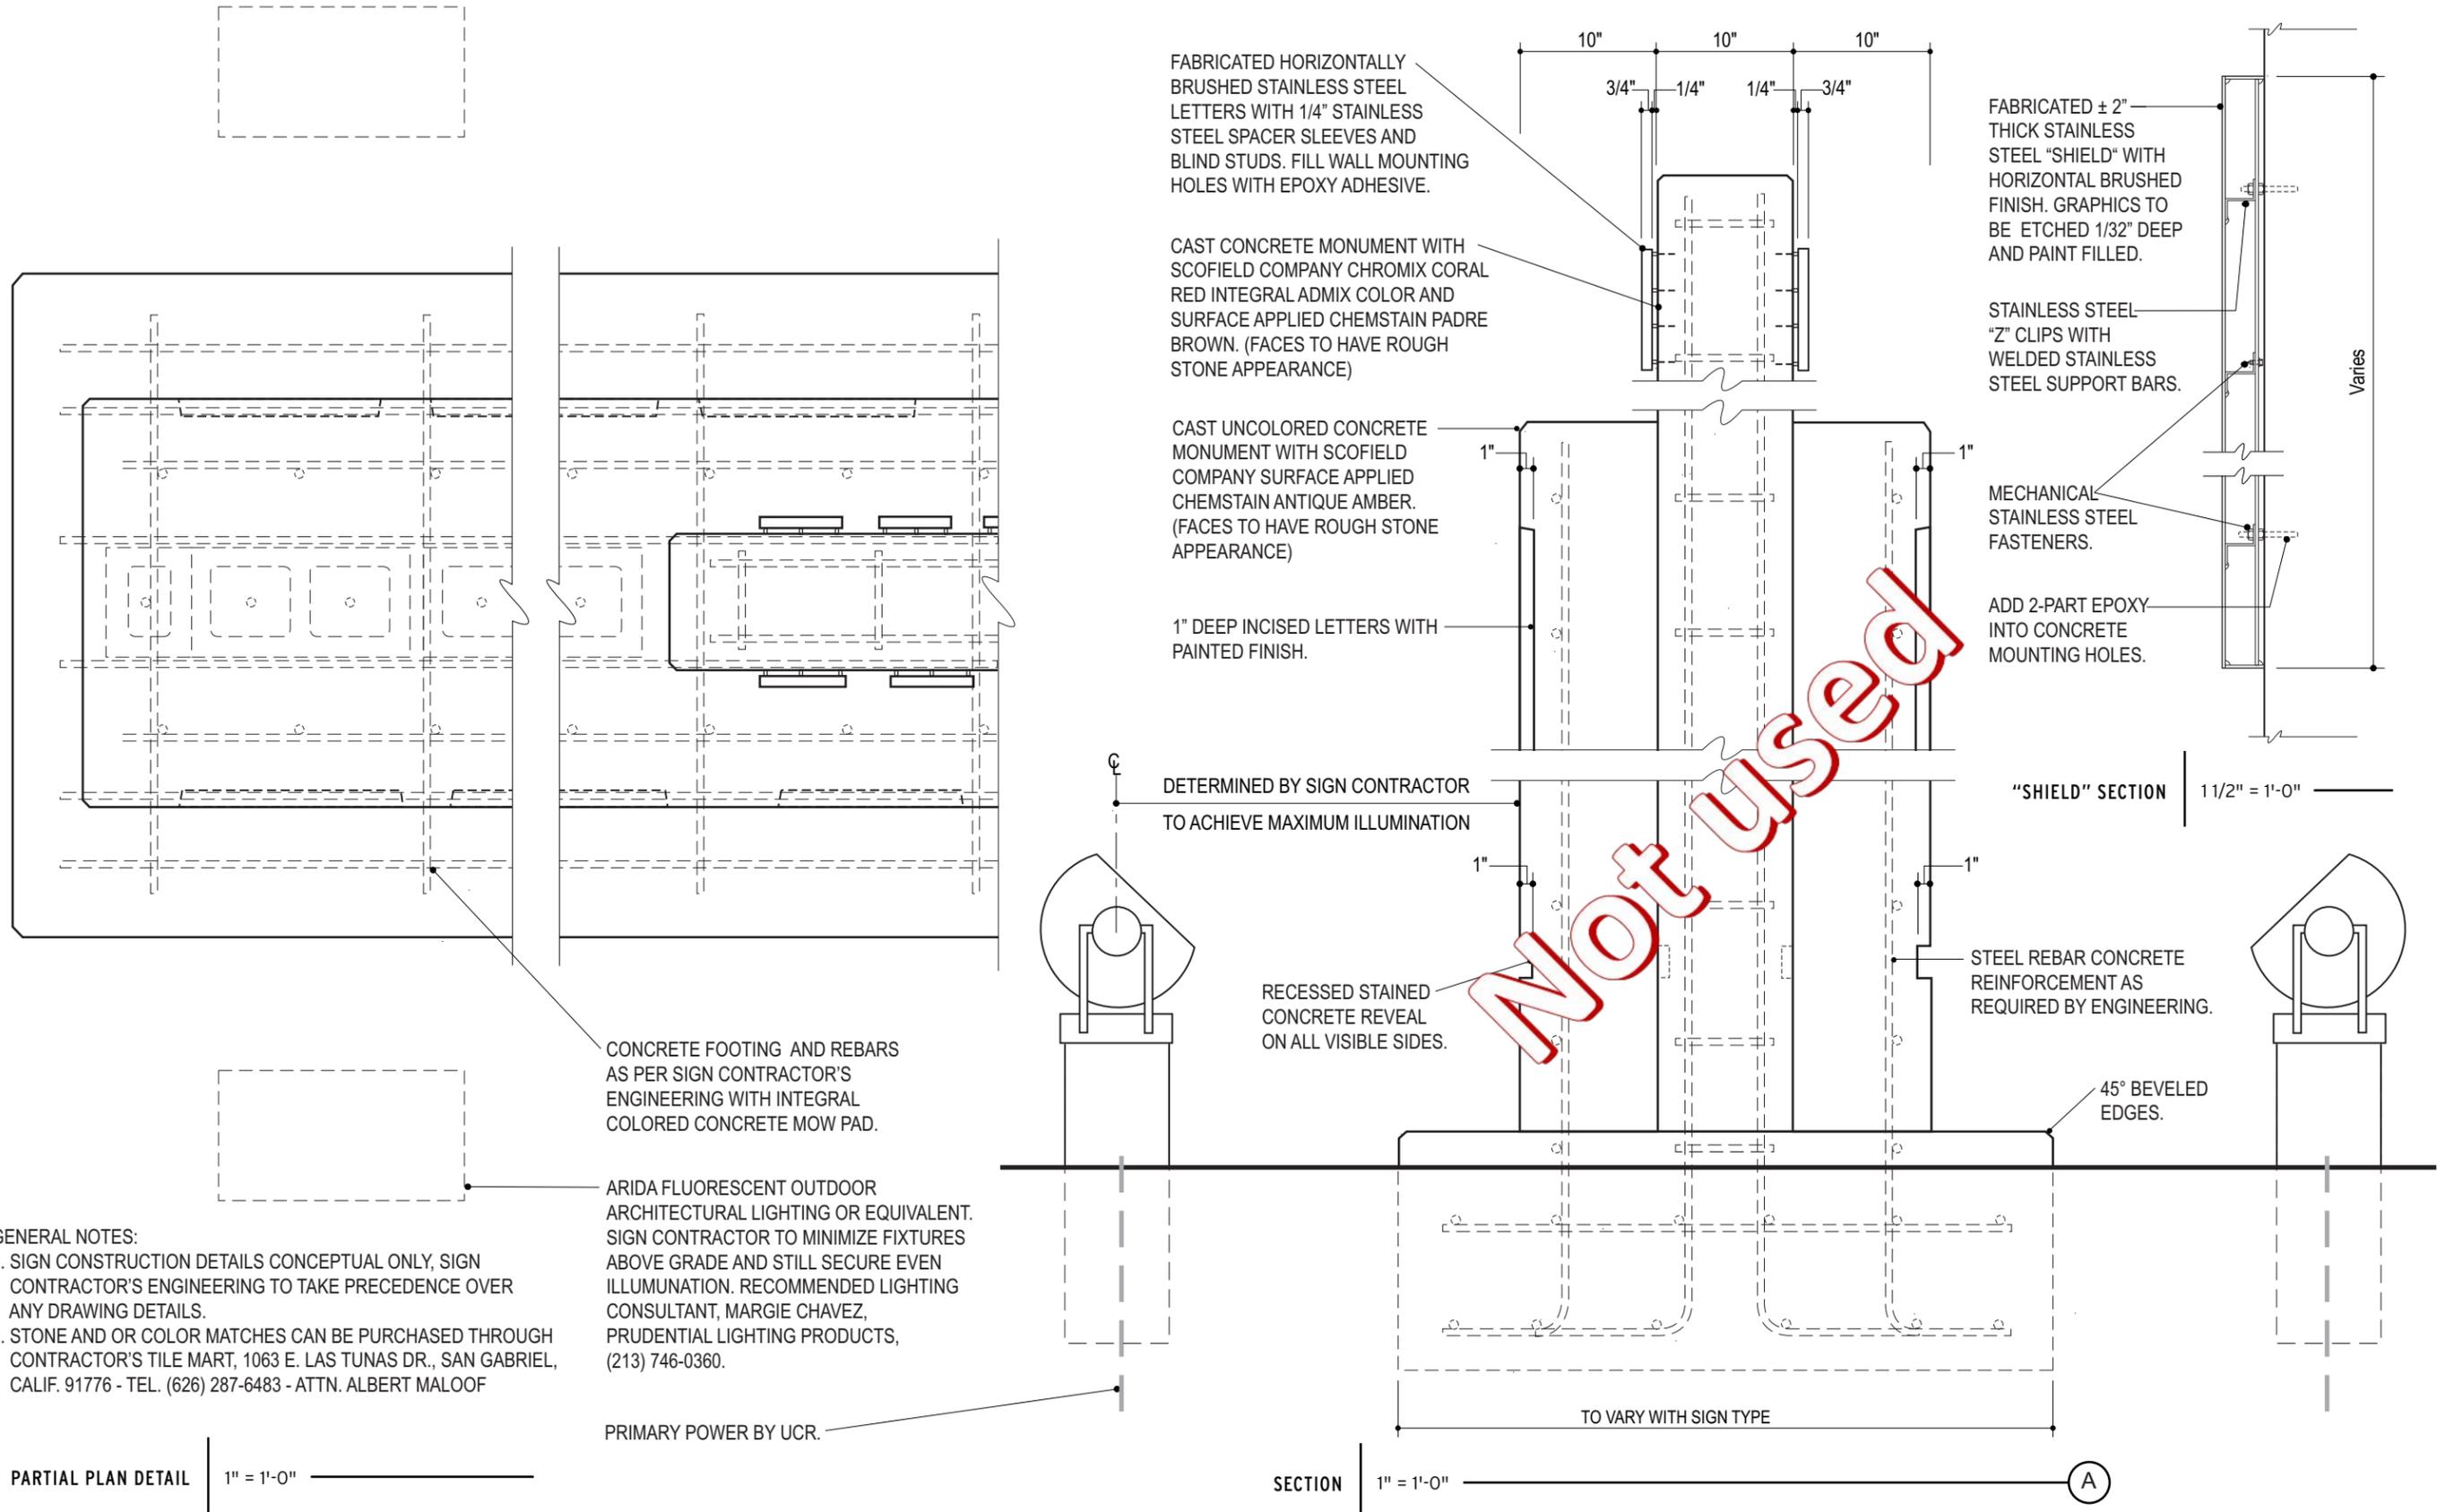

GENERAL NOTES:

1. SIGN CONSTRUCTION DETAILS CONCEPTUAL ONLY, SIGN CONTRACTOR'S ENGINEERING TO TAKE PRECEDENCE OVER ANY DRAWING DETAILS.
2. STONE AND OR COLOR MATCHES CAN BE PURCHASED THROUGH CONTRACTOR'S TILE MART, 1063 E. LAS TUNAS DR., SAN GABRIEL, CALIF. 91776 - TEL. (626) 287-6483 - ATTN. ALBERT MALOOF

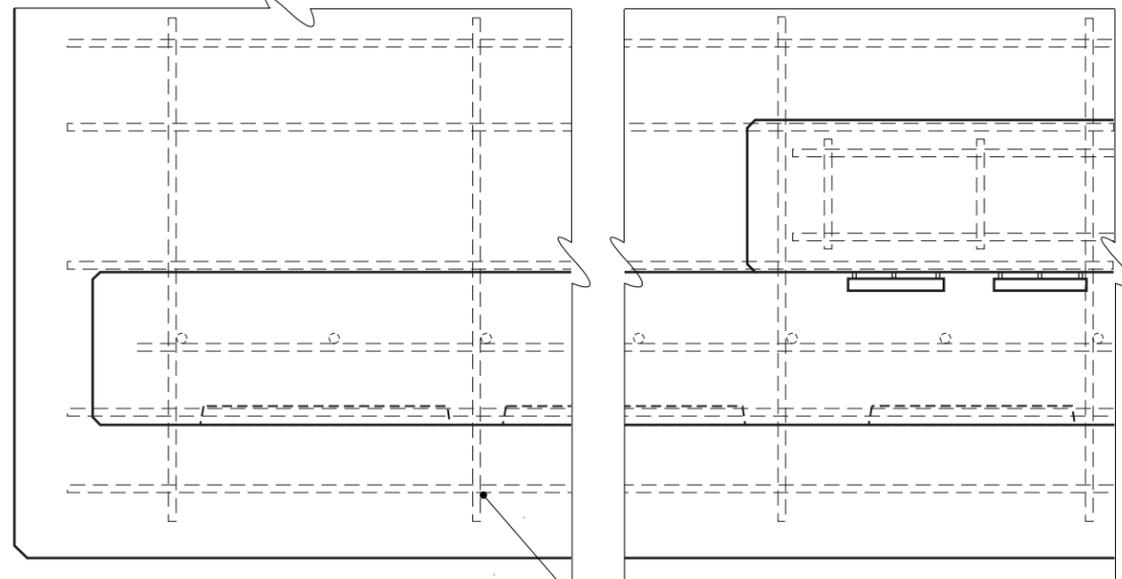


PARTIAL PLAN DETAIL

1" = 1'-0"

CONCRETE FOOTING AND REBARS AS PER SIGN CONTRACTOR'S ENGINEERING WITH INTEGRAL COLORED CONCRETE MOW PAD.

ARIDA FLUORESCENT OUTDOOR ARCHITECTURAL LIGHTING OR EQUIVALENT. SIGN CONTRACTOR TO MINIMIZE FIXTURES ABOVE GRADE AND STILL SECURE EVEN ILLUMINATION. RECOMMENDED LIGHTING CONSULTANT, MARGIE CHAVEZ, PRUDENTIAL LIGHTING PRODUCTS, (213) 746-0360.

PRIMARY POWER BY UCR.

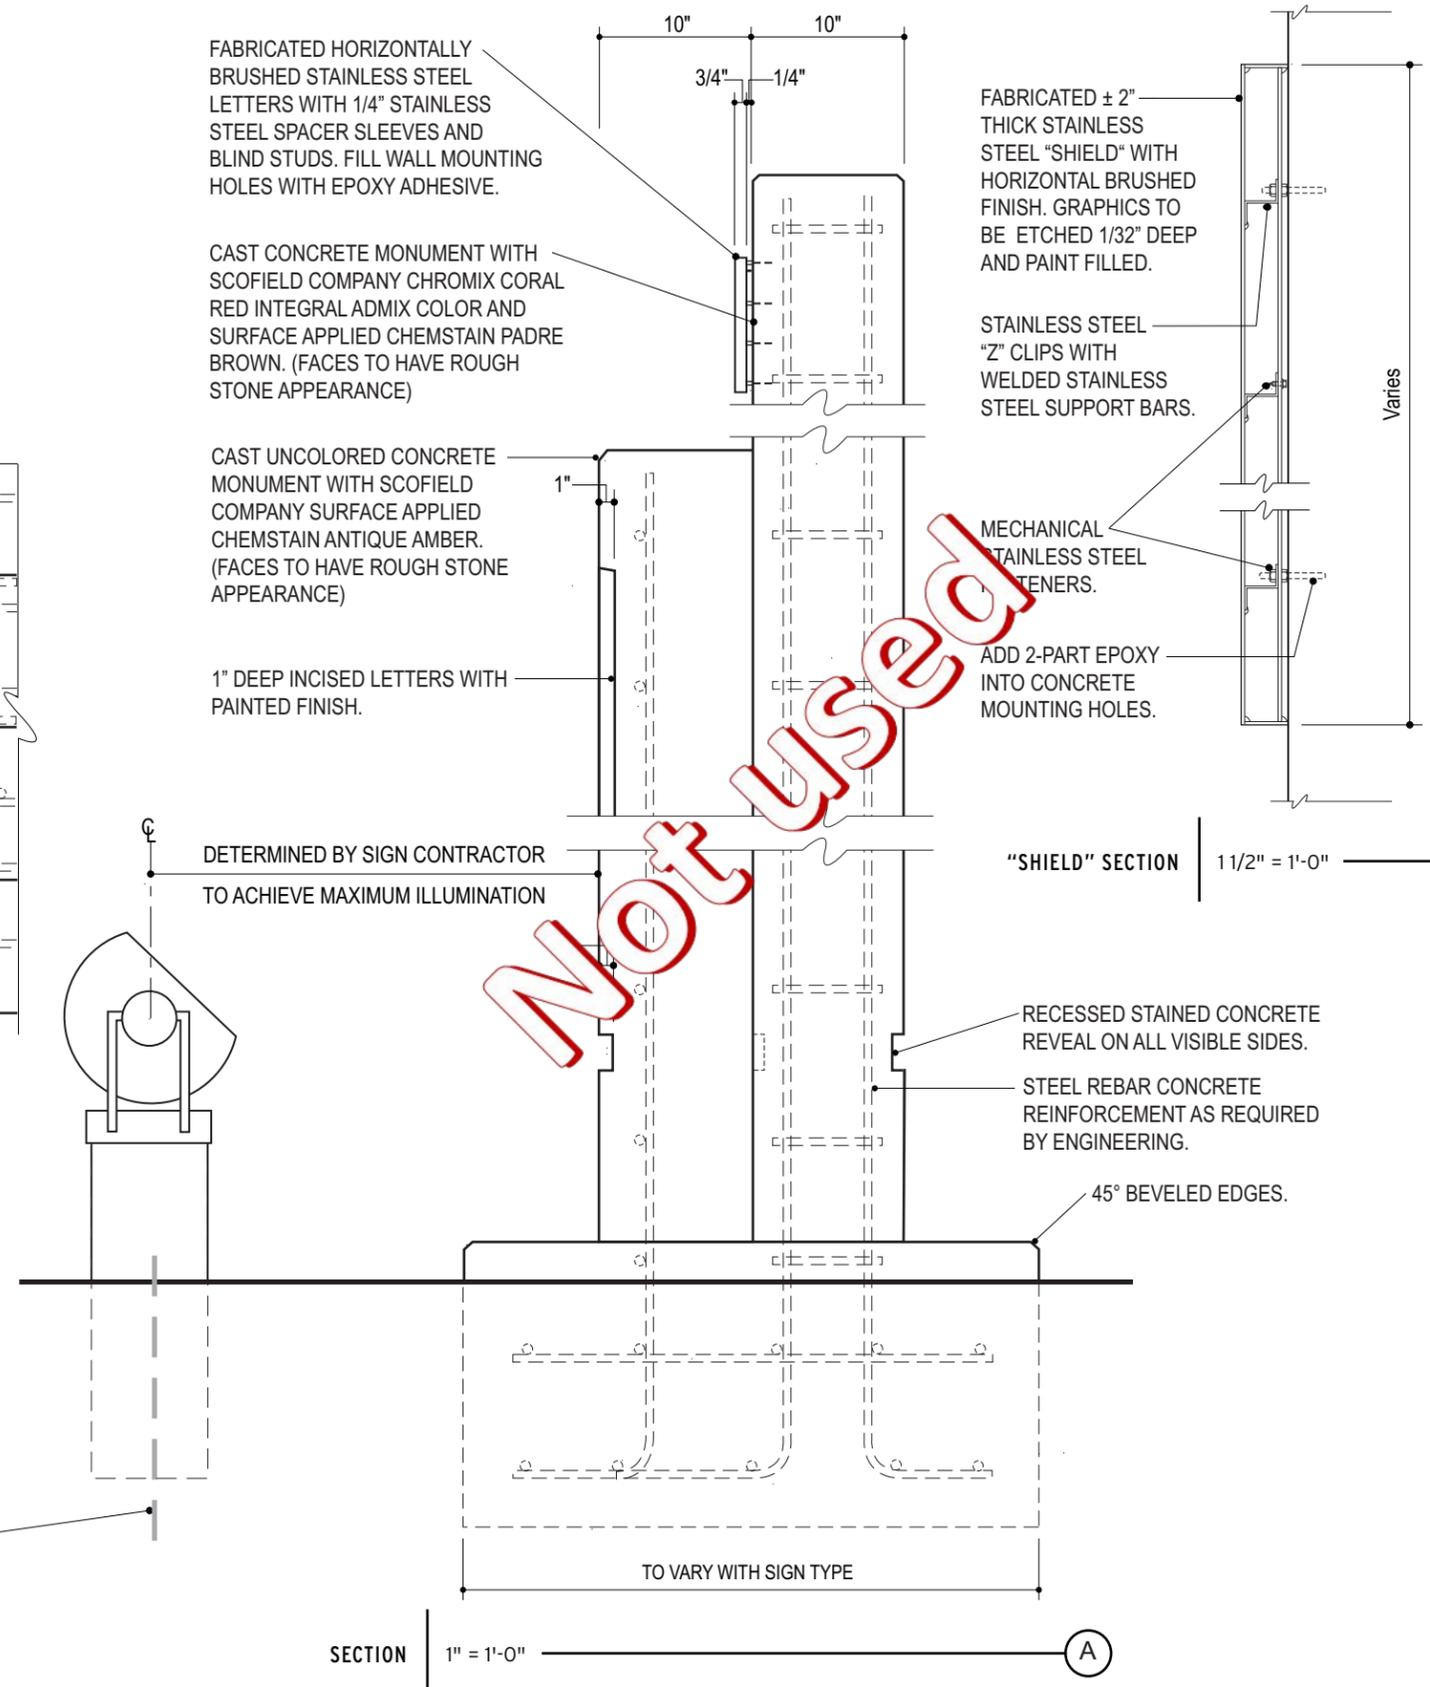

FABRICATED HORIZONTALLY BRUSHED STAINLESS STEEL LETTERS WITH 1/4" STAINLESS STEEL SPACER SLEEVES AND BLIND STUDS. FILL WALL MOUNTING HOLES WITH EPOXY ADHESIVE.

CAST CONCRETE MONUMENT WITH SCOFIELD COMPANY CHROMIX CORAL RED INTEGRAL ADMIX COLOR AND SURFACE APPLIED CHEMSTAIN PADRE BROWN. (FACES TO HAVE ROUGH STONE APPEARANCE)

CAST UNCOLORED CONCRETE MONUMENT WITH SCOFIELD COMPANY SURFACE APPLIED CHEMSTAIN ANTIQUE AMBER. (FACES TO HAVE ROUGH STONE APPEARANCE)

1" DEEP INCISED LETTERS WITH PAINTED FINISH.

DETERMINED BY SIGN CONTRACTOR TO ACHIEVE MAXIMUM ILLUMINATION

FABRICATED ± 2" THICK STAINLESS STEEL "SHIELD" WITH HORIZONTAL BRUSHED FINISH. GRAPHICS TO BE ETCHED 1/32" DEEP AND PAINT FILLED.

STAINLESS STEEL "Z" CLIPS WITH WELDED STAINLESS STEEL SUPPORT BARS.

MECHANICAL STAINLESS STEEL TENSERS.

ADD 2-PART EPOXY INTO CONCRETE MOUNTING HOLES.

"SHIELD" SECTION 1 1/2" = 1'-0"

RECESSED STAINED CONCRETE REVEAL ON ALL VISIBLE SIDES.


STEEL REBAR CONCRETE REINFORCEMENT AS REQUIRED BY ENGINEERING.

45° BEVELED EDGES.




TO VARY WITH SIGN TYPE


SECTION 1" = 1'-0"

A

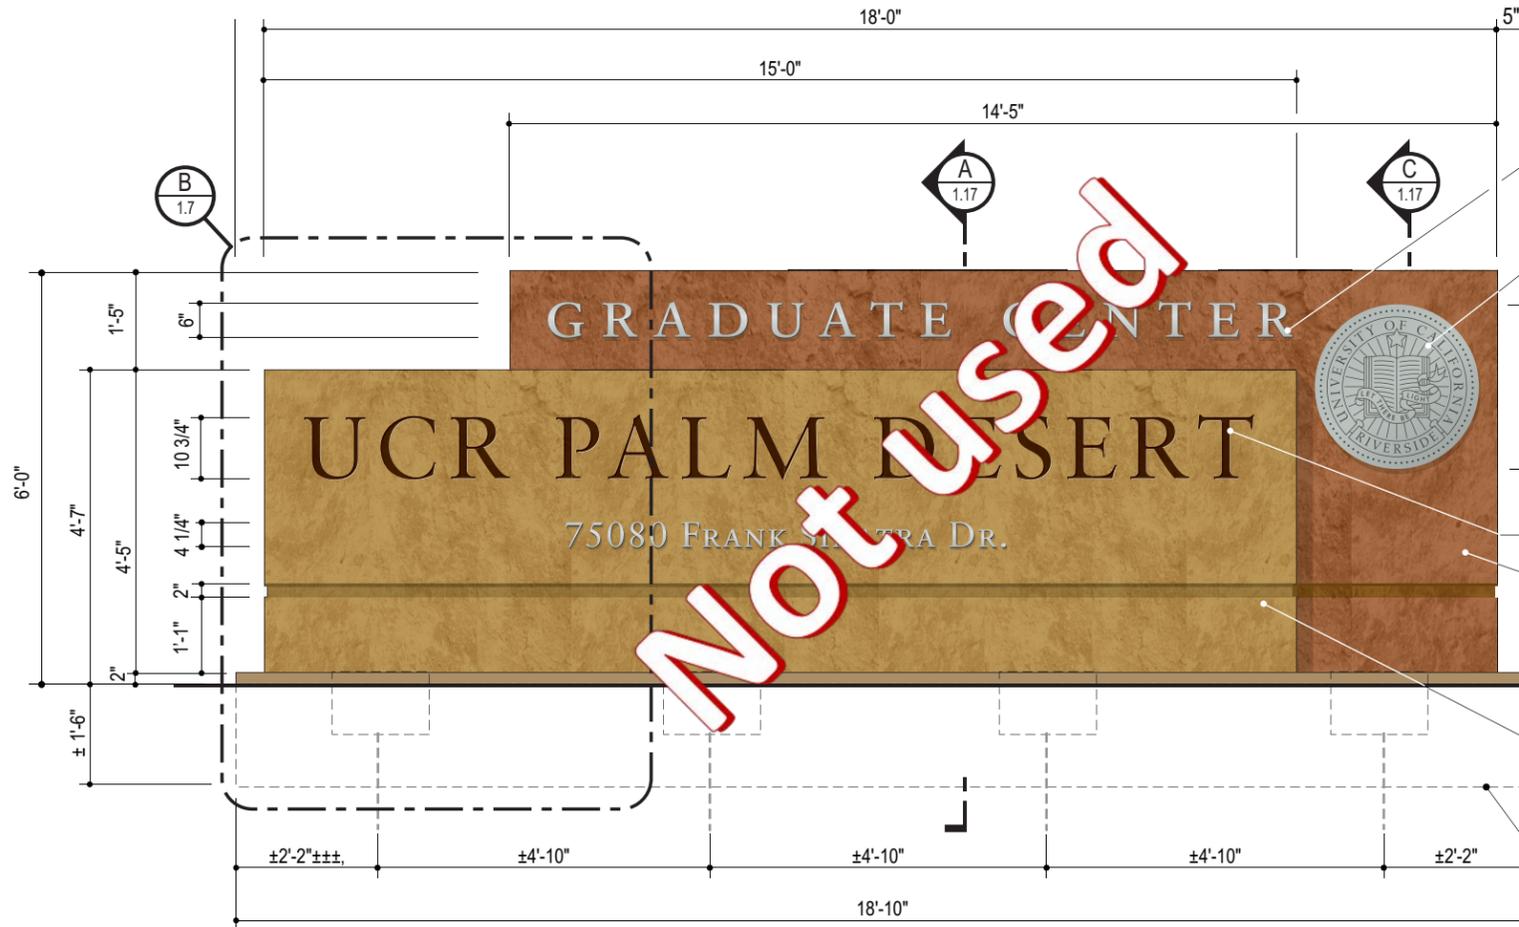

Not Used

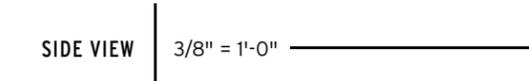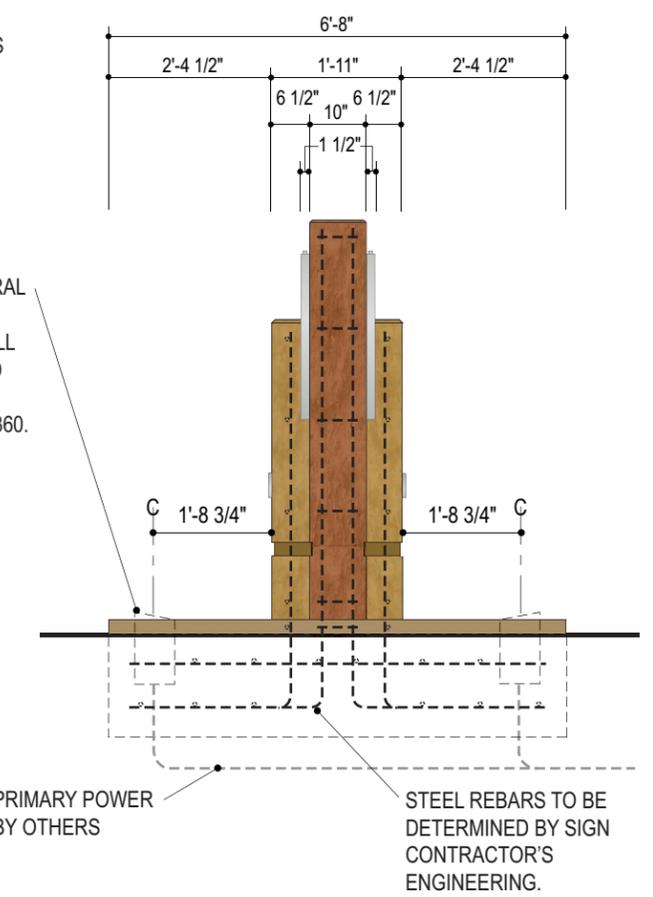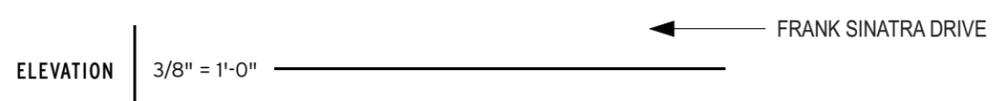


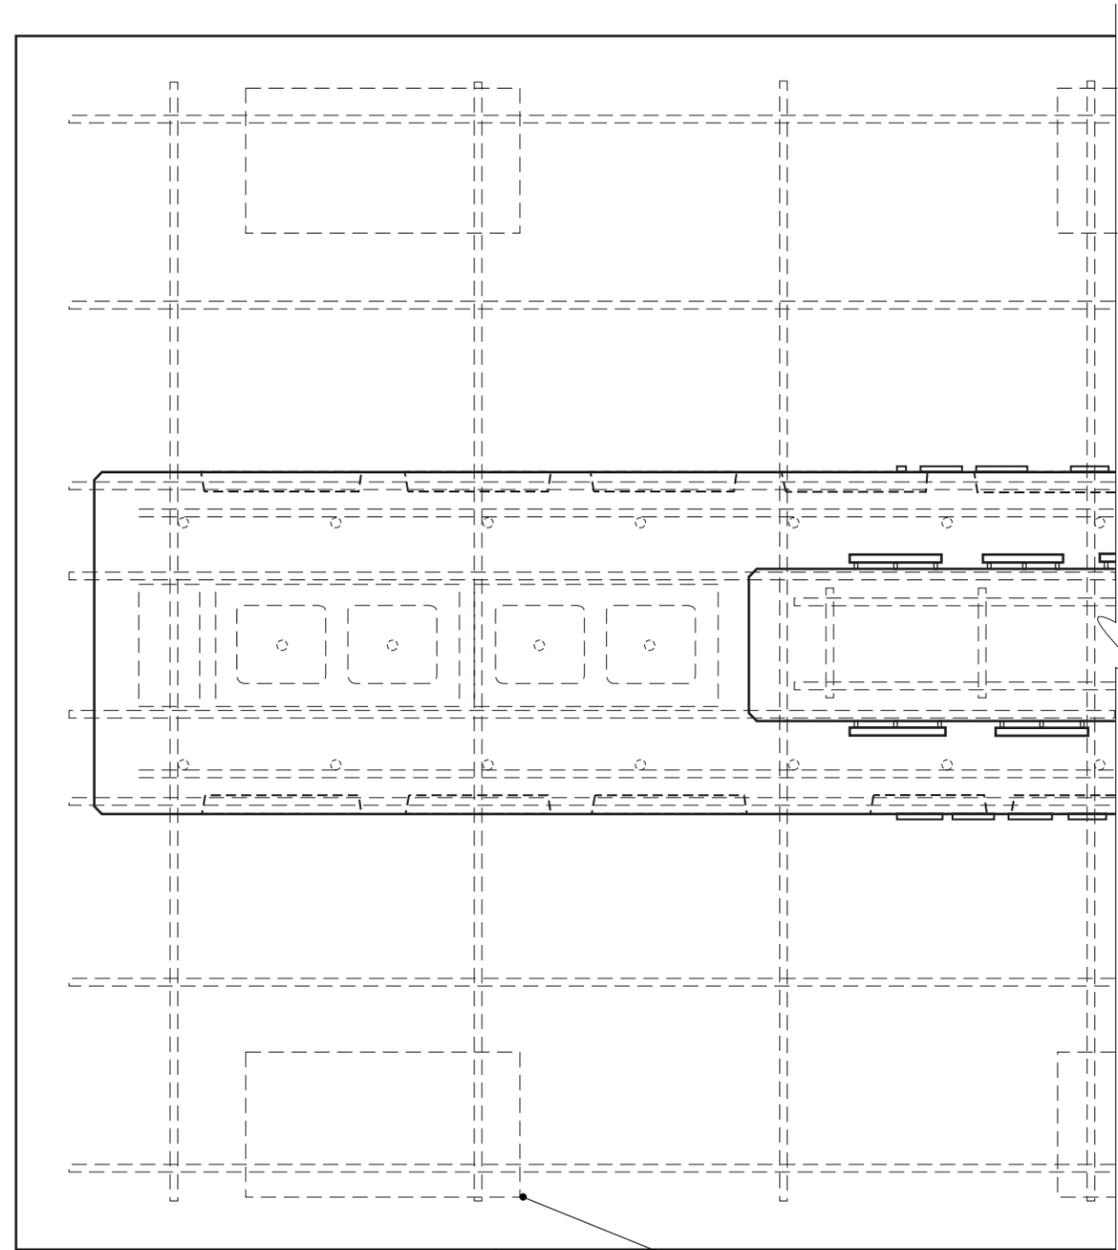

GENERAL NOTES:
 1. SIGN CONSTRUCTION DETAILS CONCEPTUAL ONLY, SIGN CONTRACTOR'S ENGINEERING TO TAKE PRECEDENCE OVER ANY DRAWING DETAILS.
 2. STONE AND OR COLOR MATCHES CAN BE PURCHASED THROUGH CONTRACTOR'S TILE MART, 1063 E. LAS TUNAS DR., SAN GABRIEL, CALIF. 91776 - TEL. (626) 287-6483 - ATTN. ALBERT MALOOF

ARIDA FLUORESCENT OUTDOOR ARCHITECTURAL LIGHTING OR EQUIVALENT. SIGN CONTRACTOR TO MINIMIZE FIXTURES ABOVE GRADE AND STILL SECURE EVEN ILLUMINATION. RECOMMENDED LIGHTING CONSULTANT, MARGIE CHAVEZ, PRUDENTIAL LIGHTING PRODUCTS, (213) 746-0360.

CONCRETE FOOTING AND REBARS AS PER SIGN CONTRACTOR'S ENGINEERING WITH INTEGRAL COLORED CONCRETE MOW PAD. PRIMARY POWER BY OTHERS.

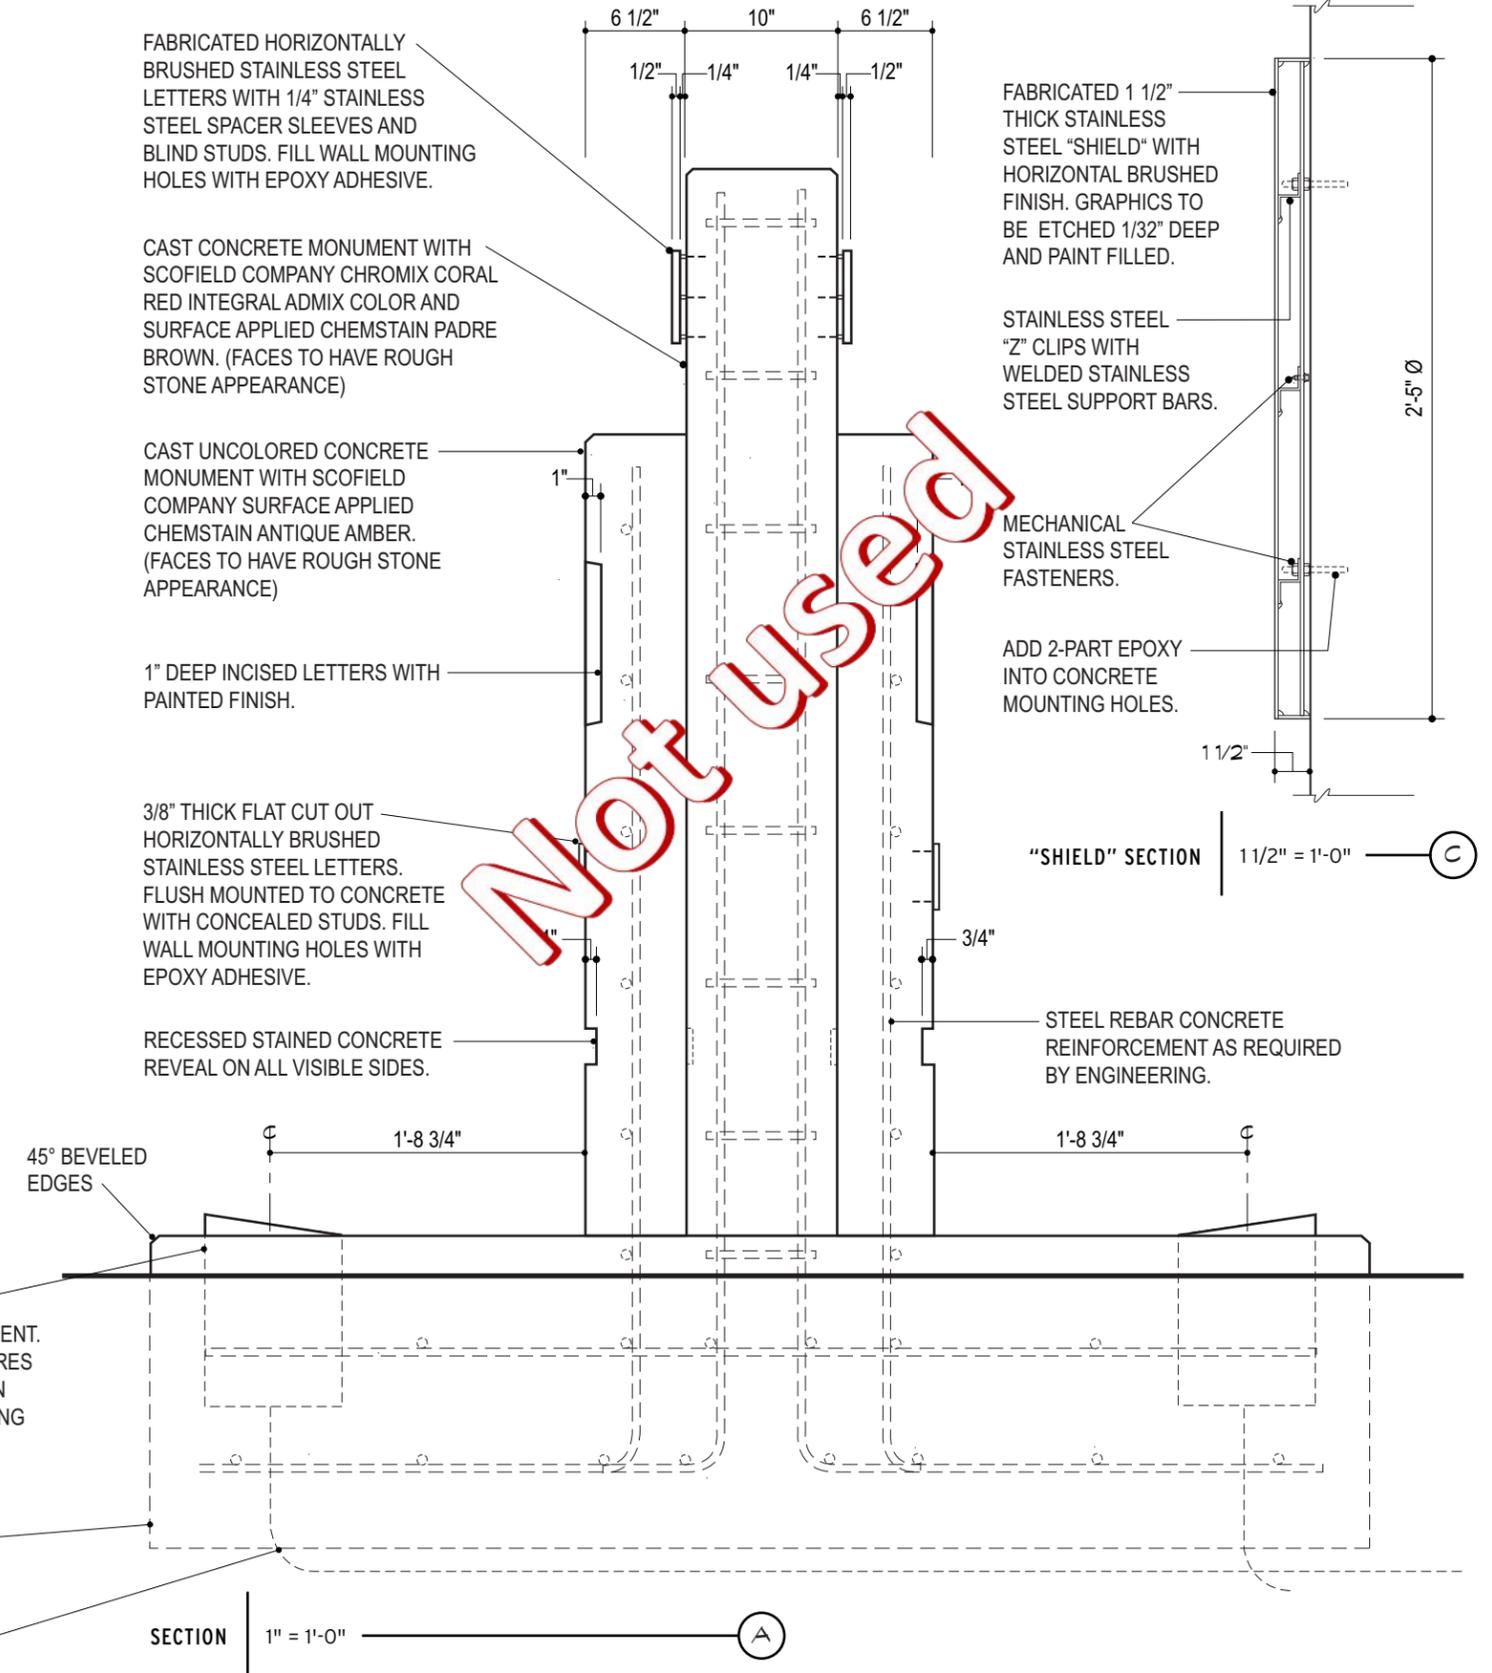

FABRICATED HORIZONTALLY BRUSHED STAINLESS STEEL LETTERS WITH 1/4" STAINLESS STEEL SPACER SLEEVES AND BLIND STUDS. FILL WALL MOUNTING HOLES WITH EPOXY ADHESIVE.

CAST CONCRETE MONUMENT WITH SCOFIELD COMPANY CHROMIX CORAL RED INTEGRAL ADMIX COLOR AND SURFACE APPLIED CHEMSTAIN PADRE BROWN. (FACES TO HAVE ROUGH STONE APPEARANCE)

CAST UNCOLORED CONCRETE MONUMENT WITH SCOFIELD COMPANY SURFACE APPLIED CHEMSTAIN ANTIQUE AMBER. (FACES TO HAVE ROUGH STONE APPEARANCE)

1" DEEP INCISED LETTERS WITH PAINTED FINISH.

3/8" THICK FLAT CUT OUT HORIZONTALLY BRUSHED STAINLESS STEEL LETTERS. FLUSH MOUNTED TO CONCRETE WITH CONCEALED STUDS. FILL WALL MOUNTING HOLES WITH EPOXY ADHESIVE.

RECESSED STAINED CONCRETE REVEAL ON ALL VISIBLE SIDES.

FABRICATED 1 1/2" THICK STAINLESS STEEL "SHIELD" WITH HORIZONTAL BRUSHED FINISH. GRAPHICS TO BE ETCHED 1/32" DEEP AND PAINT FILLED.


STAINLESS STEEL "Z" CLIPS WITH WELDED STAINLESS STEEL SUPPORT BARS.

MECHANICAL STAINLESS STEEL FASTENERS.

ADD 2-PART EPOXY INTO CONCRETE MOUNTING HOLES.

STEEL REBAR CONCRETE REINFORCEMENT AS REQUIRED BY ENGINEERING.

NOT USED

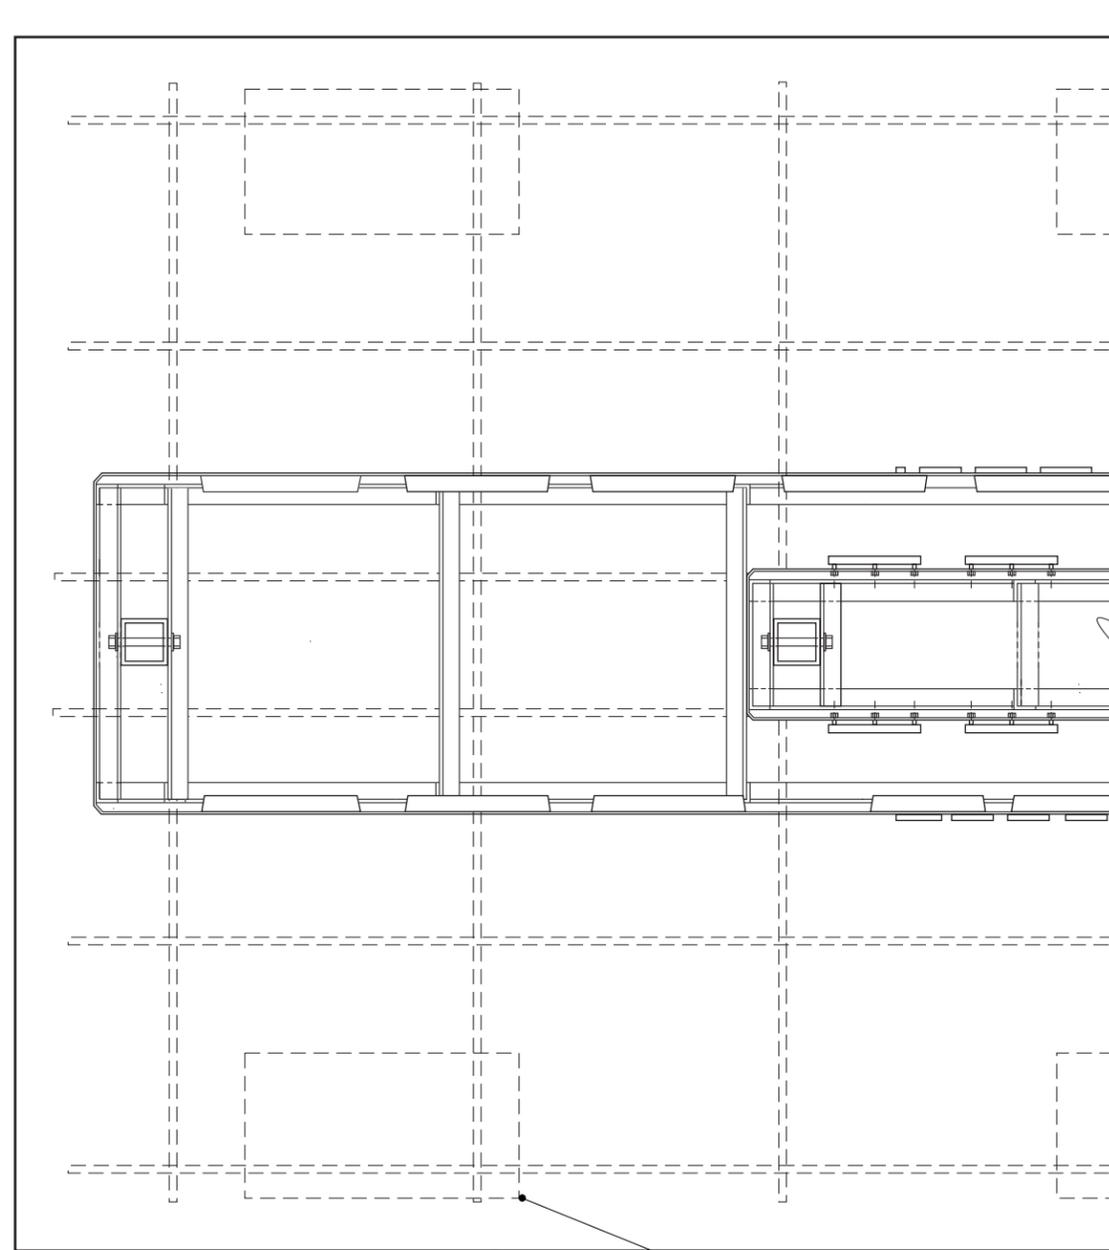

PARTIAL PLAN DETAIL

1" = 1'-0"



GENERAL NOTES:

1. SIGN CONSTRUCTION DETAILS CONCEPTUAL ONLY, SIGN CONTRACTOR'S ENGINEERING TO TAKE PRECEDENCE OVER ANY DRAWING DETAILS.
2. STONE AND OR COLOR MATCHES CAN BE PURCHASED THROUGH CONTRACTOR'S TILE MART, 1063 E. LAS TUNAS DR., SAN GABRIEL, CALIF. 91776 - TEL. (626) 287-6483 - ATTN. ALBERT MALOOF

ARIDA FLUORESCENT OUTDOOR ARCHITECTURAL LIGHTING OR EQUIVALENT. SIGN CONTRACTOR TO MINIMIZE FIXTURES ABOVE GRADE AND STILL SECURE EVEN ILLUMINATION. RECOMMENDED LIGHTING CONSULTANT, MARGIE CHAVEZ, PRUDENTIAL LIGHTING PRODUCTS, (213) 746-0360.

CONCRETE FOOTING AND REBARS AS PER SIGN CONTRACTOR'S ENGINEERING WITH INTEGRAL COLORED CONCRETE MOW PAD. PRIMARY POWER BY OTHERS.

45° BEVELED EDGES

SECTION

1" = 1'-0"

Not Used

FABRICATED HORIZONTALLY BRUSHED STAINLESS STEEL LETTERS WITH 1/4" STAINLESS STEEL SPACER SLEEVES AND BLIND STUDS. FILL WALL MOUNTING HOLES WITH EPOXY ADHESIVE.

FABRICATED .090 ALUMINUM CABINET WITH TEXCOTE FINISH TO MATCH SCOFIELD COMPANY RED INTEGRAL ADMIX COLOR AND SURFACE APPLIED CHEMSTAIN PADRE BROWN. (FACES TO HAVE ROUGH STONE APPEARANCE)


FABRICATED .090 ALUMINUM CABINET WITH TEXCOTE FINISH TO MATCH SCOFIELD COMPANY SURFACE APPLIED CHEMSTAIN ANTIQUE AMBER. (FACES TO HAVE ROUGH STONE APPEARANCE)

WELDED 2" x 2" x 1/4" ALUMINUM ANGLE FRAMING STRUCTURE WITH PRIMED FINISH.

1" DEEP INCISED LETTERS WITH PAINTED FINISH. REFER TO SHEET 1.6 FOR COLORS.

3/8" THICK FLAT CUT OUT HORIZONTALLY BRUSHED STAINLESS STEEL LETTERS. FLUSH MOUNTED TO CONCRETE WITH CONCEALED STUDS. FILL WALL MOUNTING HOLES WITH EPOXY ADHESIVE.

RECESSED ALUMINUM REVEAL. REVEAL WRAPPED AROUND ALL VISIBLE SIDES AND PAINTED.

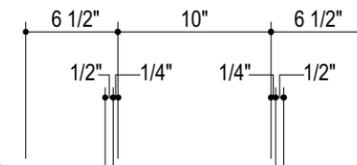

FABRICATED 1 1/2" THICK STAINLESS STEEL "SHIELD" WITH HORIZONTAL BRUSHED FINISH. GRAPHICS TO BE ETCHED 1/32" DEEP AND PAINT FILLED.

STAINLESS STEEL "Z" CLIPS WITH WELDED STAINLESS STEEL SUPPORT BARS.

MECHANICAL STAINLESS STEEL FASTENERS.

ADD 2-PART EPOXY INTO CONCRETE MOUNTING HOLES.




"SHIELD" SECTION

1 1/2" = 1'-0"



(4)-3" SQUARE HEAVY WALL ALUMINUM TUBING WITH WELDED 1/2" THICK ALUMINUM PLATED ON BURIED END. COAT BURIED TUBING WITH ALKALI - RESISTANT BITUMINOUS PAINT. VERIFY WITH SIGN CONTRACTOR'S ENGINEERING.

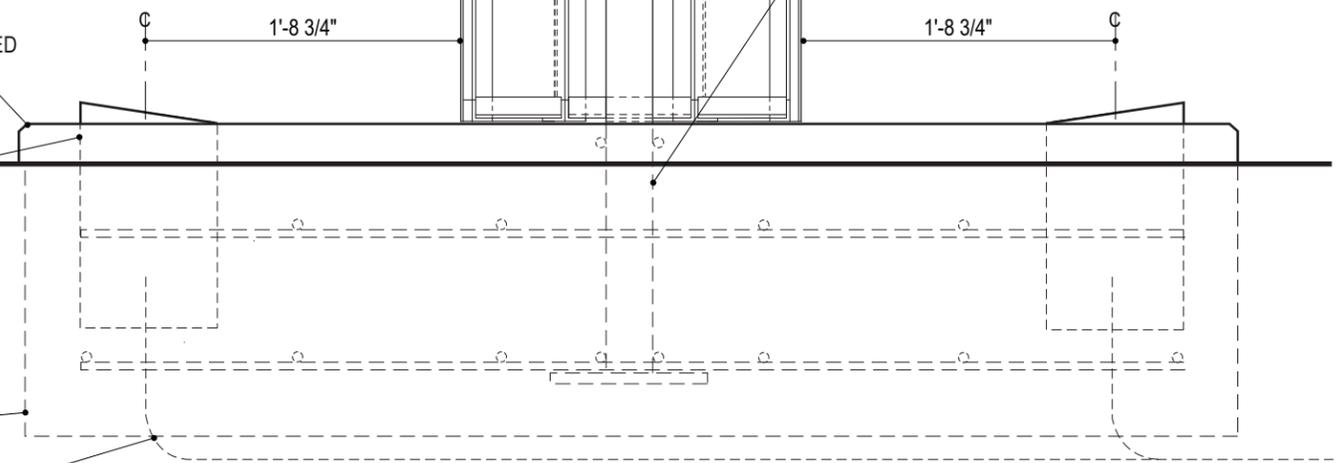

HUNT DESIGN
25 N. MENTOR AVE.
PASADENA, CA 91106

PAGE: 1 of 2
PROJECT: UC RIVERSIDE
SUBJECT: RIVERSIDE, CA
SIGN STRUCTURAL CALCS.
BY: DVM DATE: 10-1-07
P.O.# DWGS. FROM PERRY SHIMOJI

FOR COLUMN & FOOTING DESIGN

AREA -- SIGN TYPE W20.0
A= 4.83' * 4.29' = 20.7 S.F.

WIND CBC-'01 80 MPH, EXP. C

CBC-1613 $p=Cq*Ce*Qs*I$ $I=1.0$
 $Qs = 16.4$ $Cq = 1.4$
 25.94 LBS/S.F. @ 20' $Ce = 1.13$
 24.34 LBS/S.F. < 15' $Ce = 1.06$
 S.F. LBS FT. FT. LBS
 AREA !PRESS! X-DIST ! MOM-XX

| | | | |
|------|-----|------|------|
| 20.7 | 504 | 2.42 | 1219 |
| 0.0 | 0 | 0.00 | 0 |
| 0.0 | 0 | 0.00 | 0 |
| 0.0 | 0 | 0.00 | 0 |

TOTAL 504 2.42 1219 (AVE.)

DOUBLE COLUMN
MOM. 'K 0.61

ALUM $Fb = 12$ K/SQ. IN.
 $S = M/Fb$ WIND 1/3 INCR.
 $S = 0.75 * M$ (INCL 1.33 WIND)
 $S = 0.46$ IN³


$S = (bd^3 - b1*d1^3)/(6*d)$
 $d = 2$ $d1 = 1.75$
 $b = 2$ $b1 = 1.75$
 USING 2"x2"x 1/8" ALUM. TUBE
 $S = 0.55$ IN³ > 0.46
 O.K.

COAT ALUM. SURFACES EMBEDDED IN CONC. WITH ONE HEAVY COAT OF ALKALI-RESISTANT BITUMINOUS (BITUMASTIC) PAINT TO 2" MIN. ABOVE GRADE
 8"x8"x 3/8" ALUM. PLATE - W/ LDRP
 WT. OF SIGN = 220 LBS +/-
 AXIAL STRESS IS NEGLIGIBLE

SEE PAGE 2 FOR FOOTING DETAILS



JOB NO. HUNT-142

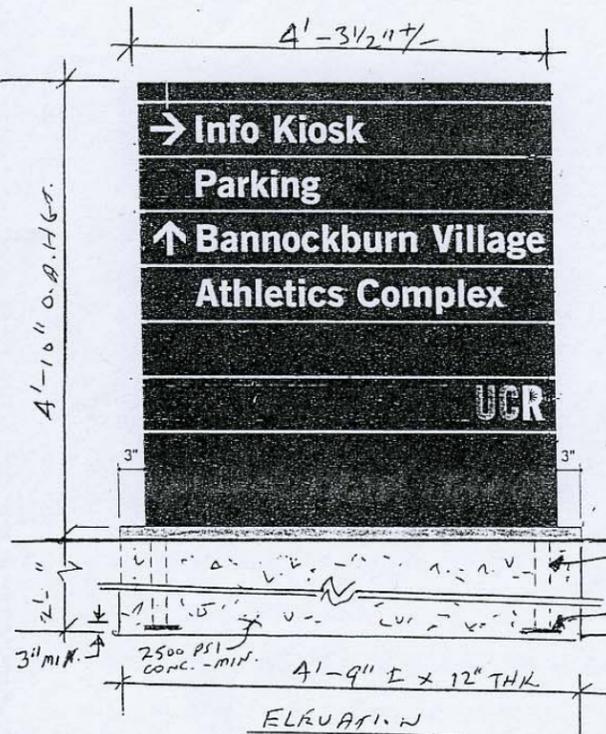

HUNT DESIGN
25 N. MENTOR AVE.
PASADENA, CA 91106

PAGE: 2 of 2
PROJECT: UC RIVERSIDE
SUBJECT: RIVERSIDE, CA
SIGN STRUCTURAL CALCS.
BY: DVM DATE: 10-1-07
P.O.# DWGS. FROM PERRY SHIMOJI


SINGLE FOOTING - STRAIGHT

DESIGN OF EMBEDDED POLE FOOTINGS


| DESCRIPTION | >> | 57" WIDE | | |
|-------------------------|------|----------|-------|-------|
| | >> | 12" THK | | |
| ALLOW PASSIVE | psf | 200 | 200 | 200 |
| MAX PASSIVE | psf | 1,500 | 1,500 | 1,500 |
| LOAD DURATION FACTOR | | 1.33 | 1.33 | 1.33 |
| POINT LOAD | lbs | 504 | 0 | 0 |
| LOAD HT. | ft | 2.42 | 0.00 | 0.00 |
| DIST. LOAD | #/ft | 0 | 0 | 0 |
| START HT. | ft | 0.00 | 0.00 | 0.00 |
| END HT. | ft | 0.00 | 0.00 | 0.00 |
| WIDTH/DIAMETER | in | 57" | 0 | 0 |
| CIRCULAR ? | y/n | N | N | N |
| RESTRAINED ? | y/n | N | N | N |
| SUMMARY | | | | |
| Moments @ Surface: | | | | |
| Point Load | ft-# | 1,220 | 0 | 0 |
| Uniform Load | ft-# | 0 | 0 | 0 |
| ... Total Moment | ft-# | 1,220 | 0 | 0 |
| Total Lateral Load | # | 504 | 0 | 0 |
| NON-RESTRAINED RESULTS | | | | |
| Min. Req'd Embedment | | 2'-3" | | |
| $A(1+(1+4.36h/A)^.5)/2$ | ft | 2.11 | 0.00 | 0.00 |
| $A=2.34P/(S 1 b)$ | | | | |
| Press @ 1/3 Embed.: | | | | |
| Actual | psf | 188 | 0 | 0 |
| Allowable | psf | 187 | 0 | 0 |
| RESTRAINED | | | | |
| Min. Req'd Embedment | | 0.00 | 0.00 | 0.00 |
| $(4.25 P h/S3 b)^.5$ | ft | | | |
| Pressure @ Bottom | | | | |
| Actual | psf | 0 | 0 | 0 |
| Allowable | psf | 0 | 0 | 0 |
| Surface Restraint Force | lbs | 0 | 0 | 0 |

PER CBC TABLE 18-1-A
POLE 2X ALLOWABLE




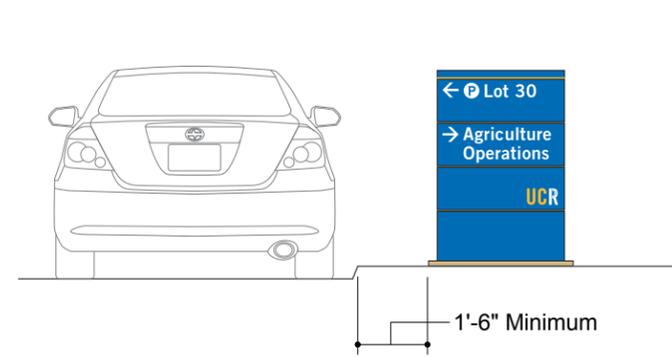


LOCATION ELEVATION | 1/4" = 1'-0"


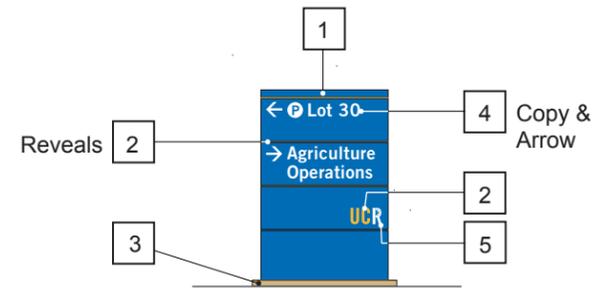


Note: All sign surfaces to be sprayed with semi gloss anti graffiti clear coating.

COLORS | 1/4" = 1'-0"

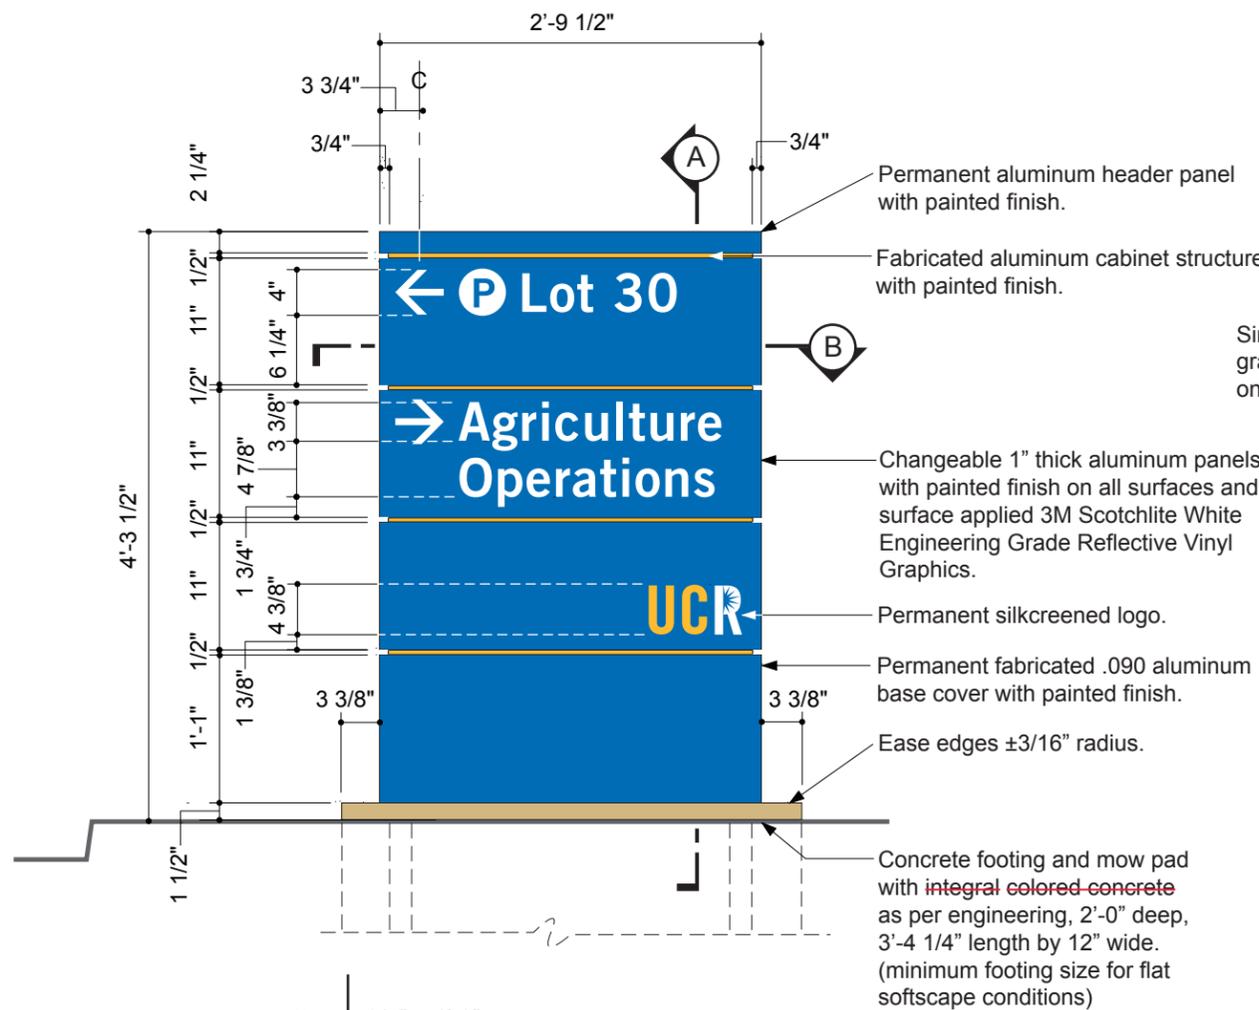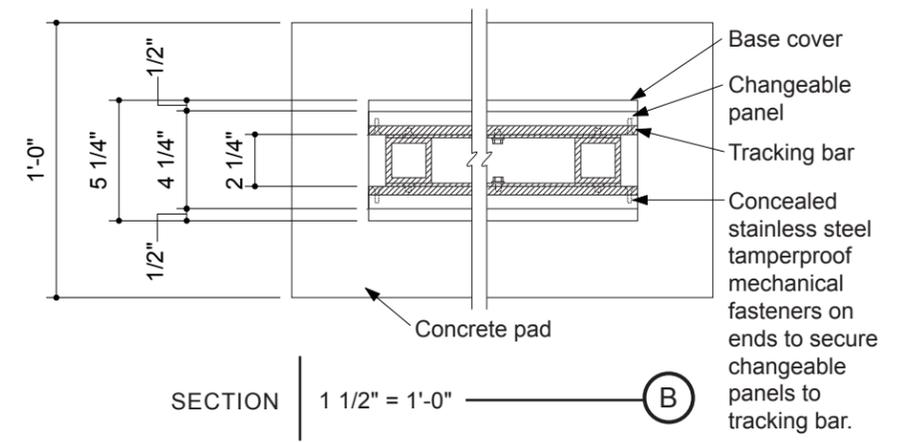

Single face sign with graphics to be applied on (1) - one side only.

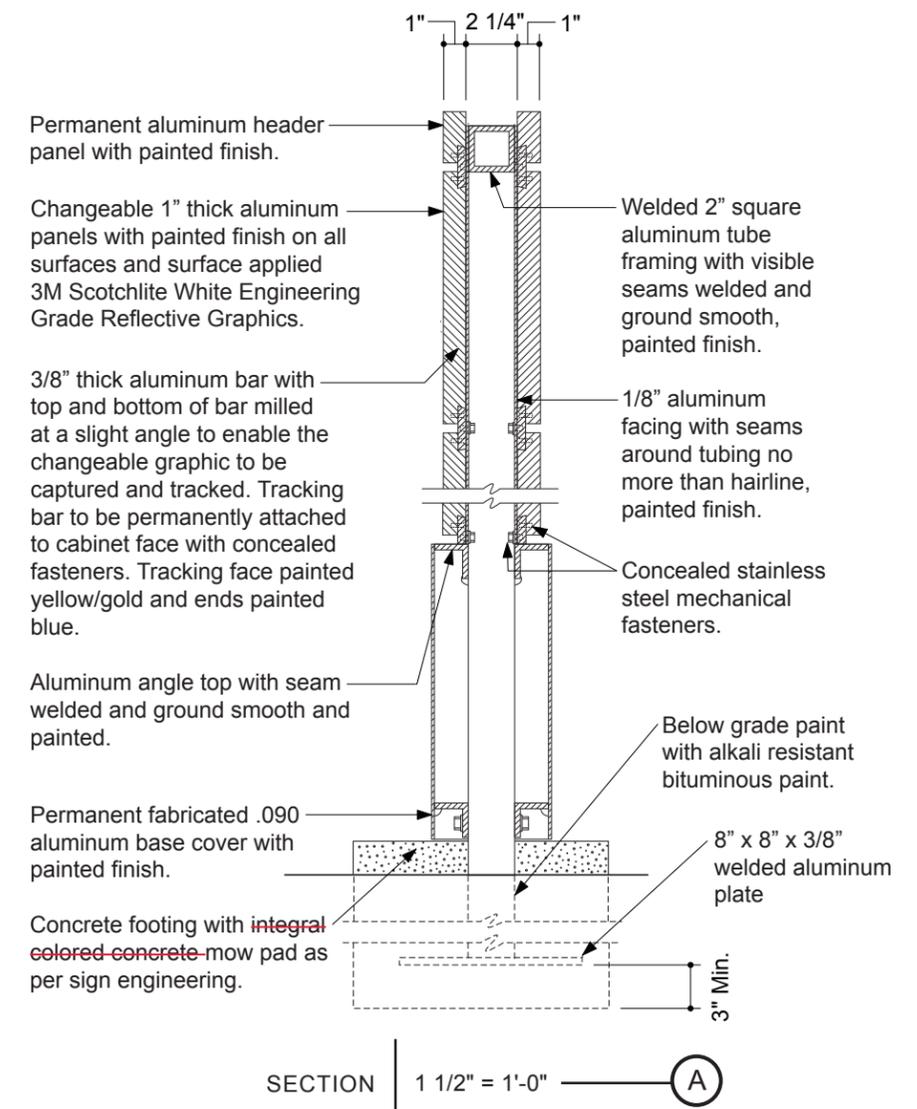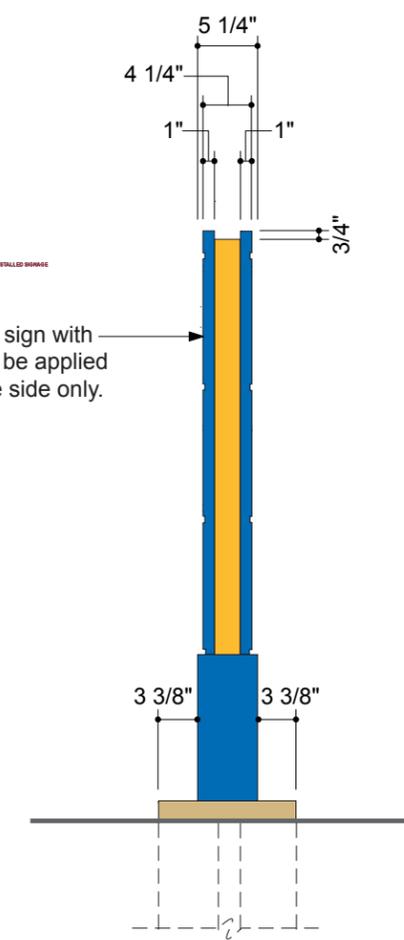

MODIFIED | MATCH EXISTING INSTALLED SIGNAGE

HUNT DESIGN
25 N. MENTOR AVE.
PASADENA, CA 91106

PAGE: 1 of 2
PROJECT: UC RIVERSIDE
SUBJECT: RIVERSIDE, CA
SIGN STRUCTURAL CALCS.
BY: DVM DATE: 10-1-07
P.O.# DWGS. FROM PERRY SHIMOJI

FOR COLUMN & FOOTING DESIGN

AREA -- SIGN TYPE W21.0
A= 4.29' * 2.79' = 12.0 S.F.

WIND CBC-'01 80 MPH, EXP. C
CBC-1613 $p=Cq*Ce*Qs*I$ I=1.0
 $Qs = 16.4$ $Cq = 1.4$
25.94 LBS/S.F. @ 20' $Ce = 1.13$
24.34 LBS/S.F. < 15' $Ce = 1.06$
S.F. LBS FT. FT. LBS
AREA | PRESS | X-DIST | MOM-XX

| | | | |
|------|-----|------|-----|
| 12.0 | 292 | 2.15 | 628 |
| 0.0 | 0 | 0.00 | 0 |
| 0.0 | 0 | 0.00 | 0 |
| 0.0 | 0 | 0.00 | 0 |



TOTAL 292 2.15 628
(AVE.)
DOUBLE COLUMN
MOM.'K 0.31

ALUM $F_b = 12$ K/SQ. IN.
 $S = M/F_b$ WIND 1/3 INCR.
 $S = 0.75 * M$ (INCL 1.33 WIND)
 $S = 0.24$ IN³
 $S = (bd^3 - b1*d1^3)/(6*d)$
 $d = 2$ $d1 = 1.75$
 $b = 2$ $b1 = 1.75$
USING 2"x2"x 1/8" ALUM. TUBE
 $S = 0.55$ IN³ > 0.24

8" x 8" x 3/8" ALUM PLATE - WRAPPED
COAT ALUM. SURFACES EMBEDDED IN CONC. WITH ONE HEAVY COAT OF ALKALI-RESISTANT BITUMINOUS (BITUMASTIC) PAINT TO 2" MIN. ABOVE GRADE

WT. OF SIGN = 130 LBS +/-
AXIAL STRESS IS NEGLIGIBLE

SEE PAGE 2 FOR FOOTING DETAILS

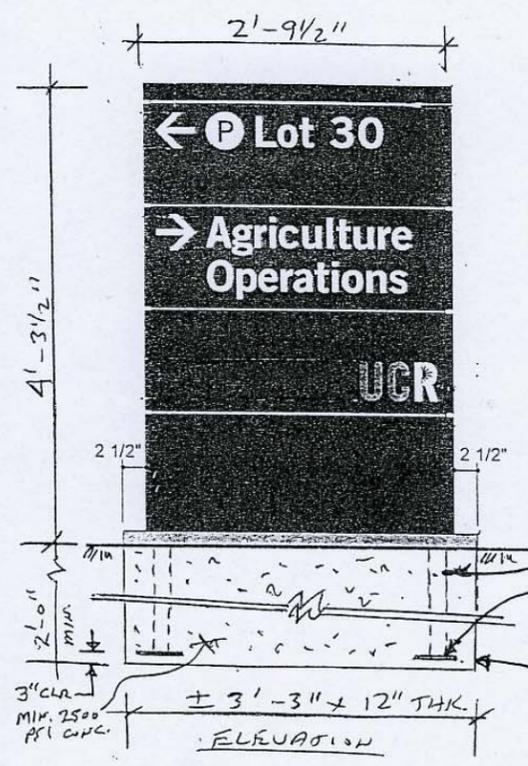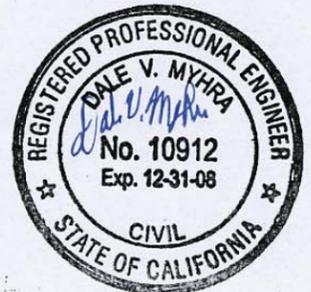

JOB NO. HUNT-143

HUNT DESIGN
25 N. MENTOR AVE.
PASADENA, CA 91106

PAGE: 2 of 2
PROJECT: UC RIVERSIDE
SUBJECT: RIVERSIDE, CA
SIGN STRUCTURAL CALCS.
BY: DVM DATE: 10-1-07
P.O.# DWGS. FROM PERRY SHIMOJI

SINGLE FOOTING - SORRIGED

DESIGN OF EMBEDDED POLE FOOTINGS

| DESCRIPTION | >> | 39" WIDE x 12" THK. | | |
|----------------------|------|------------------------|-------|-------|
| ALLOW PASSIVE | psf | 200 | 200 | 200 |
| MAX PASSIVE | psf | 1,500 | 1,500 | 1,500 |
| LOAD DURATION FACTOR | | 1.33 | 1.33 | 1.33 |
| POINT LOAD | lbs | 292 | 0 | 0 |
| LOAD HT. | ft | 2.15 | 0.00 | 0.00 |
| DIST. LOAD | #/ft | 0 | 0 | 0 |
| START HT. | ft | 0.00 | 0.00 | 0.00 |
| END HT. | ft | 0.00 | 0.00 | 0.00 |
| WIDTH/DIAMETER | in | 39" | 0 | 0 |
| CIRCULAR ? | y/n | N | N | N |
| RESTRAINED ? | y/n | N | N | N |

PER CBC TABLE 18-1-A
POLE 2x ALLOWABLE

SUMMARY

| Moments @ Surface: | | | |
|--------------------|------|-----|---|
| Point Load | ft-# | 628 | 0 |
| Uniform Load | ft-# | 0 | 0 |
| ... Total Moment | ft-# | 628 | 0 |
| Total Lateral Load | # | 292 | 0 |

NON-RESTRAINED RESULTS

| Min. Req'd Embedment | | | |
|-------------------------|----|-------|------|
| $A(1+(1+4.36h/A)^.5)/2$ | ft | 2'-0" | |
| $A=2.34P/(S 1 b)$ | ft | 1.93' | 0.00 |

Press @ 1/3 Embed.:

| | | | | |
|-----------|-----|-----|---|---|
| Actual | psf | 171 | 0 | 0 |
| Allowable | psf | 171 | 0 | 0 |








RESTRAINED RESULTS

| Min. Req'd Embedment | | | |
|-----------------------|----|------|------|
| $(4.25 P h/S 3 b)^.5$ | ft | 0.00 | 0.00 |

Pressure @ Bottom

| | | | | |
|-----------|-----|---|---|---|
| Actual | psf | 0 | 0 | 0 |
| Allowable | psf | 0 | 0 | 0 |



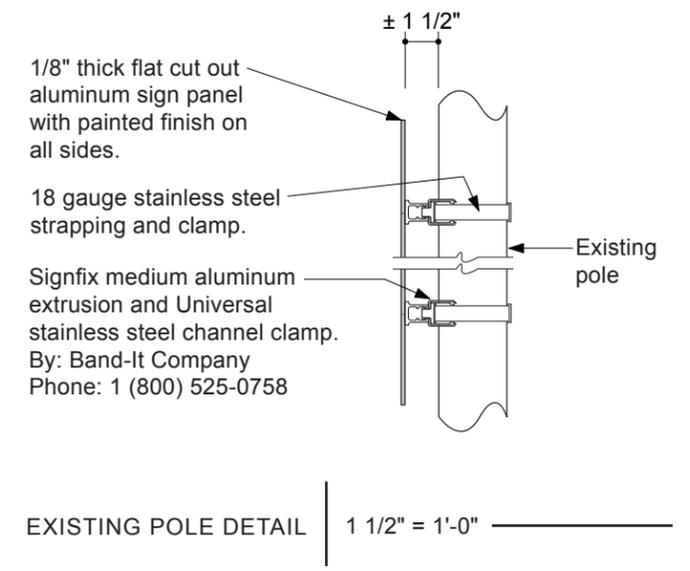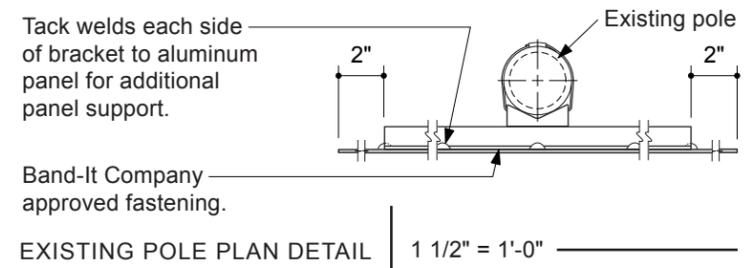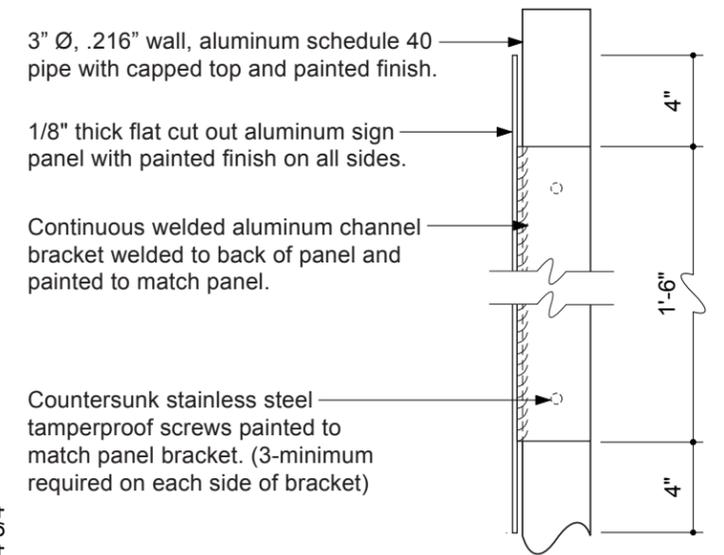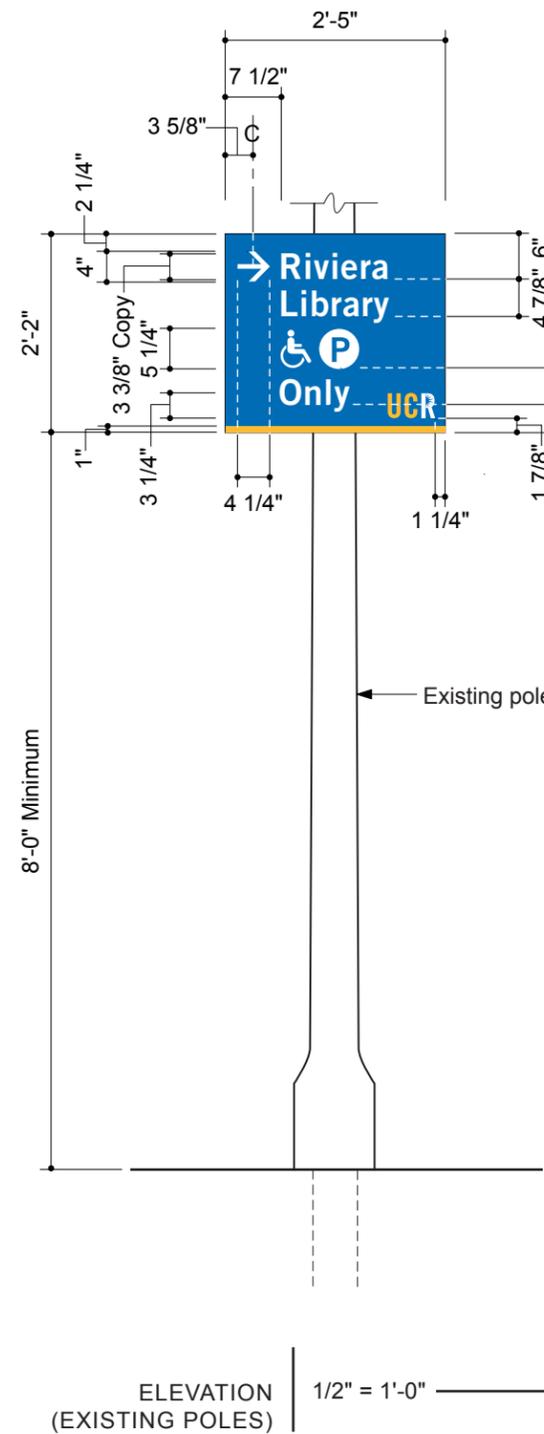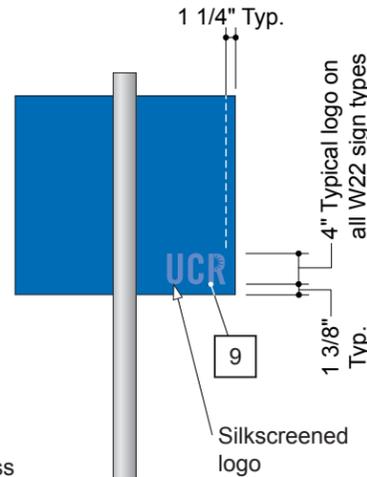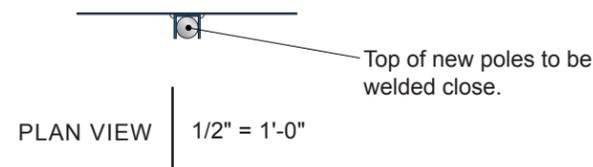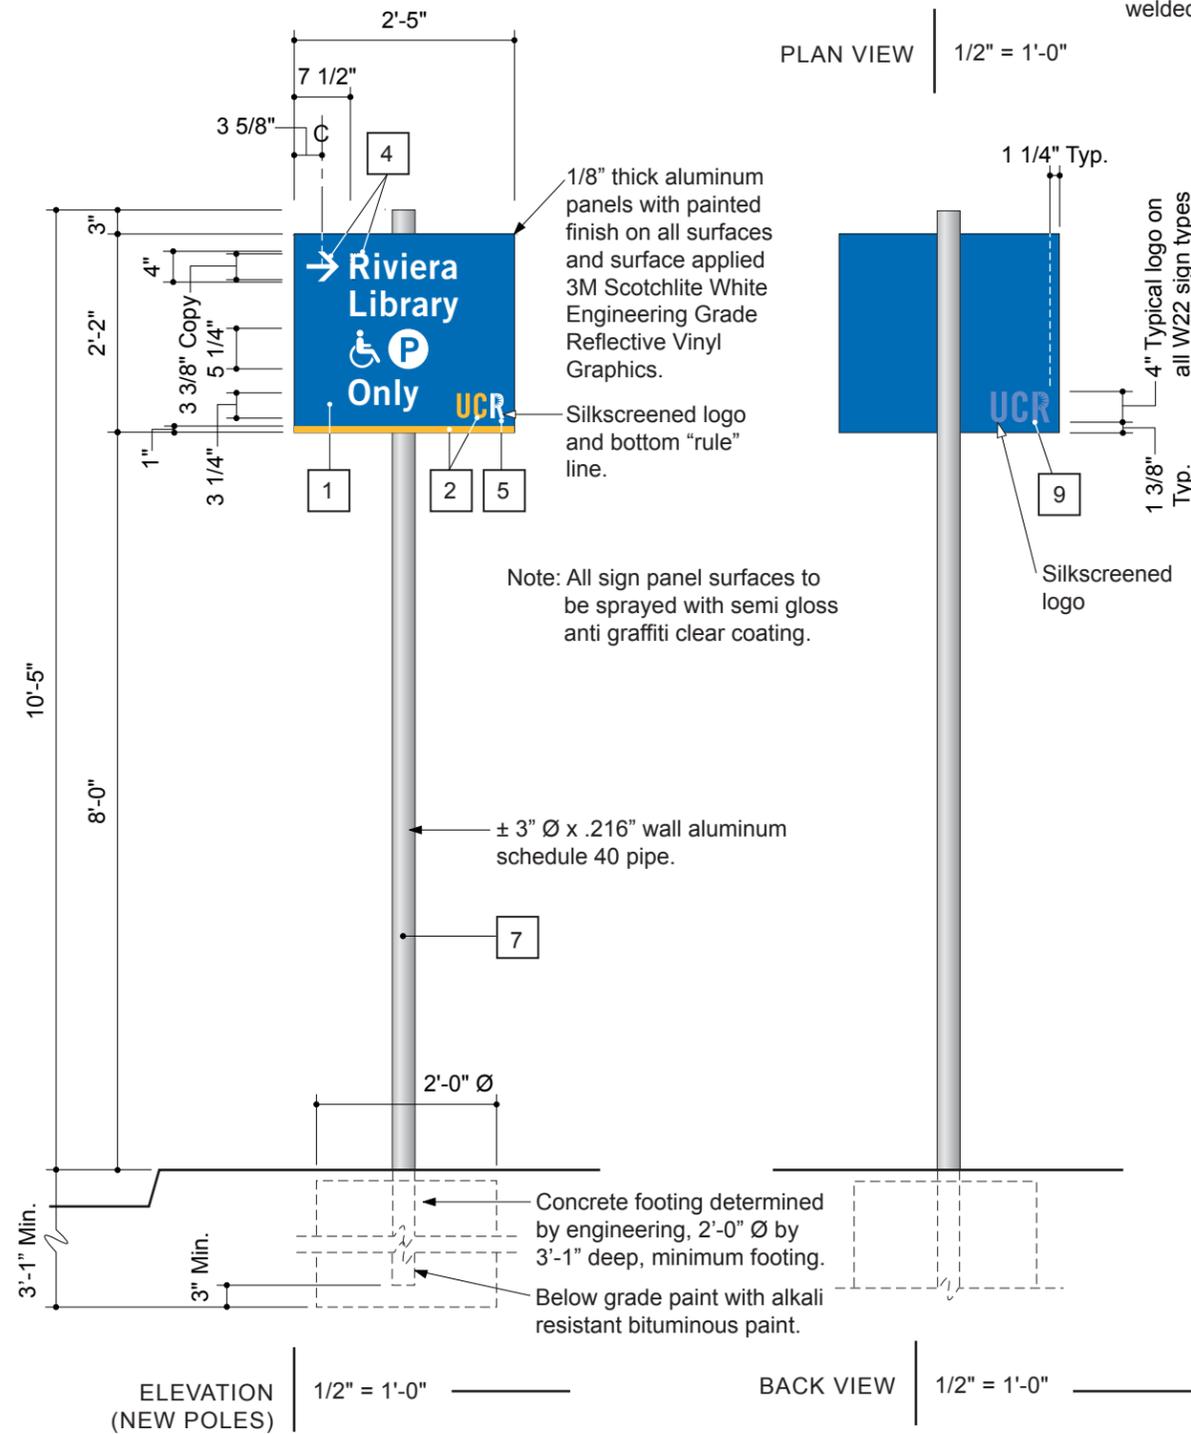


COAST SIGN, INC.
1345 S. ALLEC STREET
ANAHEIM, CA 92805

PAGE: 1 of 2
PROJECT: UC RIVERSIDE
SUBJECT: RIVERSIDE, CA
SIGN STRUCTURAL CALCS.
BY: DVM DATE: 10-3-07
P.O.# DWGS. FROM PERRY SHIMOJI

FOR COLUMN & FOOTING DESIGN

AREA -- SIGN TYPE W22.0
A= 2.25' * 2.42' = 5.4 S.F.
A= 8.17' * 0.25' = 2.0 S.F.

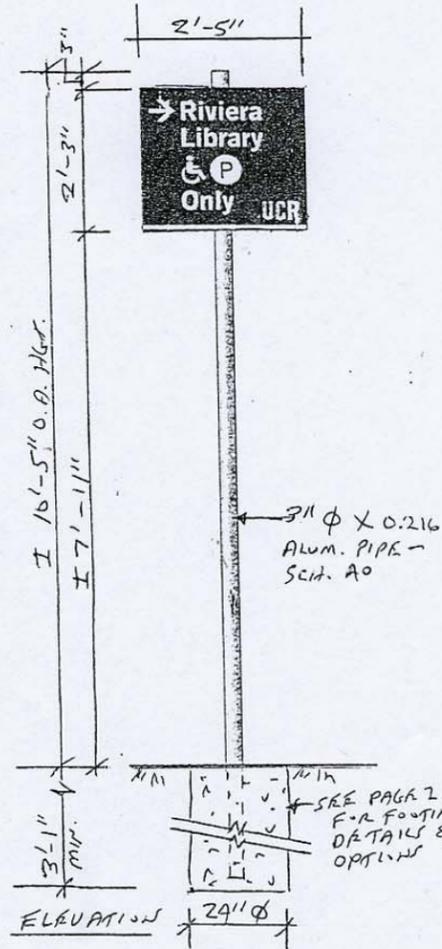

| WIND | CBC-'01 | 80 MPH, EXP. C |
|----------------------|----------------|----------------|
| CBC-1613 | $p=Cq*Ce*Qs*I$ | $I=1.0$ |
| $Qs = 16.4$ | $Cq = 1.4$ | |
| 25.94 LBS/S.F. @ 20' | $Ce = 1.13$ | |
| 24.34 LBS/S.F. < 15' | $Ce = 1.06$ | |
| S.F. | LBS | FT. |
| AREA | !PRESS! | X-DIST ! |
| | | MOM-XX |
| 5.4 | 131 | 9.05 |
| 2.0 | 49 | 4.17 |
| 0.0 | 0 | 0.00 |
| 0.0 | 0 | 0.00 |
| TOTAL | 180 | 7.73 |
| | (AVE.) | 1392 |

SINGLE COLUMN
MOM.'K 1.39

ALUM $F_y = 12$ K/SQ. IN.
 $S = M/F_b$ WIND 1/3 INCR.
 $S = 0.75 * M$ (INCL 1.33 WIND)
 $S = 1.04$ IN³
 $t = 0.216$ IN. (MIN. THK.)
 $S = .0982*(d^4-d1^4)/d$
 $d = 3.5$ $d1 = 3.068$
USE MIN. 3" DIA. x 0.216 ALUM. PIPE #40
 $S = 1.72$ IN³ > 1.04
O.K.

WT. OF SIGN = 80 LBS +/-
AXIAL STRESS IS NEGLIGIBLE

COAT ALUM. SURFACES EMBEDDED IN CONC. WITH ONE HEAVY COAT OF ALKALI-RESISTANT BITUMINOUS (BITUMASTIC PAINT -- SUCH AS HENRY'S OR EQUIVALENT).

SEE PAGE 2 FOR FOOTING DETAILS



JOB NO. HUNT-145

HUNT DESIGN
25 N. MENTOR AVE.
PASADENA, CA 91106


PAGE: 2 of 2
PROJECT: UC RIVERSIDE
SUBJECT: RIVERSIDE, CA
SIGN STRUCTURAL CALCS.
BY: DVM DATE: 10-1-07
P.O.# DWGS. FROM PERRY SHIMOJI




SINGLE COLUMN

DESIGN OF EMBEDDED POLE FOOTINGS

| DESCRIPTION | >> | 12" DIA. | 18" DIA. | 24" SQ. |
|-------------------------|------|-----------|-----------|-----------|
| CHOOSE ONE | | OPTIMUM 1 | OPTIMUM 2 | OPTIMUM 3 |
| ALLOW PASSIVE | psf | 200 | 200 | 200 |
| MAX PASSIVE | psf | 1,500 | 1,500 | 1,500 |
| LOAD DURATION FACTOR | | 1.33 | 1.33 | 1.33 |
| POINT LOAD | lbs | 180 | 180 | 180 |
| LOAD HT. | ft | 7.73 | 7.73 | 7.73 |
| DIST. LOAD | #/ft | 0 | 0 | 0 |
| START HT. | ft | 0.00 | 0.00 | 0.00 |
| END HT. | ft | 0.00 | 0.00 | 0.00 |
| WIDTH/DIAMETER | in | 12" | 18" | 24" |
| CIRCULAR ? | y/n | Y | Y | Y |
| RESTRAINED ? | y/n | N | N | N |
| SUMMARY | | | | |
| Moments @ Surface: | | | | |
| Point Load | ft-# | 1,391 | 1,391 | 1,391 |
| Uniform Load | ft-# | 0 | 0 | 0 |
| ... Total Moment | ft-# | 1,391 | 1,391 | 1,391 |
| Total Lateral Load | # | 180 | 180 | 180 |
| NON-RESTRAINED | | | | |
| Min. Req'd Embedment | | 4'-0" | 3'-5" | 3'-1" |
| $A(1+(1+4.36h/A)^.5)/2$ | | 3.88' | 3.34' | 3.01' |
| $A=2.34P/(S 1 b)$ | | DEPTH | DEPTH | DEPTH |
| Press. @ 1/3 Embed.: | | | | |
| Actual | psf | 345 | 296 | 266 |
| Allowable | psf | 344 | 296 | 267 |
| RESTRAINED | | | | |
| Min. Req'd Embedment | | 0.00 | 0.00 | 0.00 |
| $(4.25 P h/S3 b)^.5$ | | | | |
| Pressure @ Bottom | | | | |
| Actual | psf | 0 | 0 | 0 |
| Allowable | psf | 0 | 0 | 0 |
| Surface Restraint | | | | |
| Force | lbs | 0 | 0 | 0 |

PER CBC TABLE 18-
POLE 2 ALLOWABLE

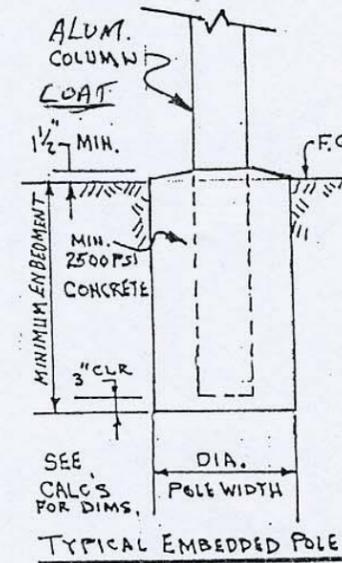

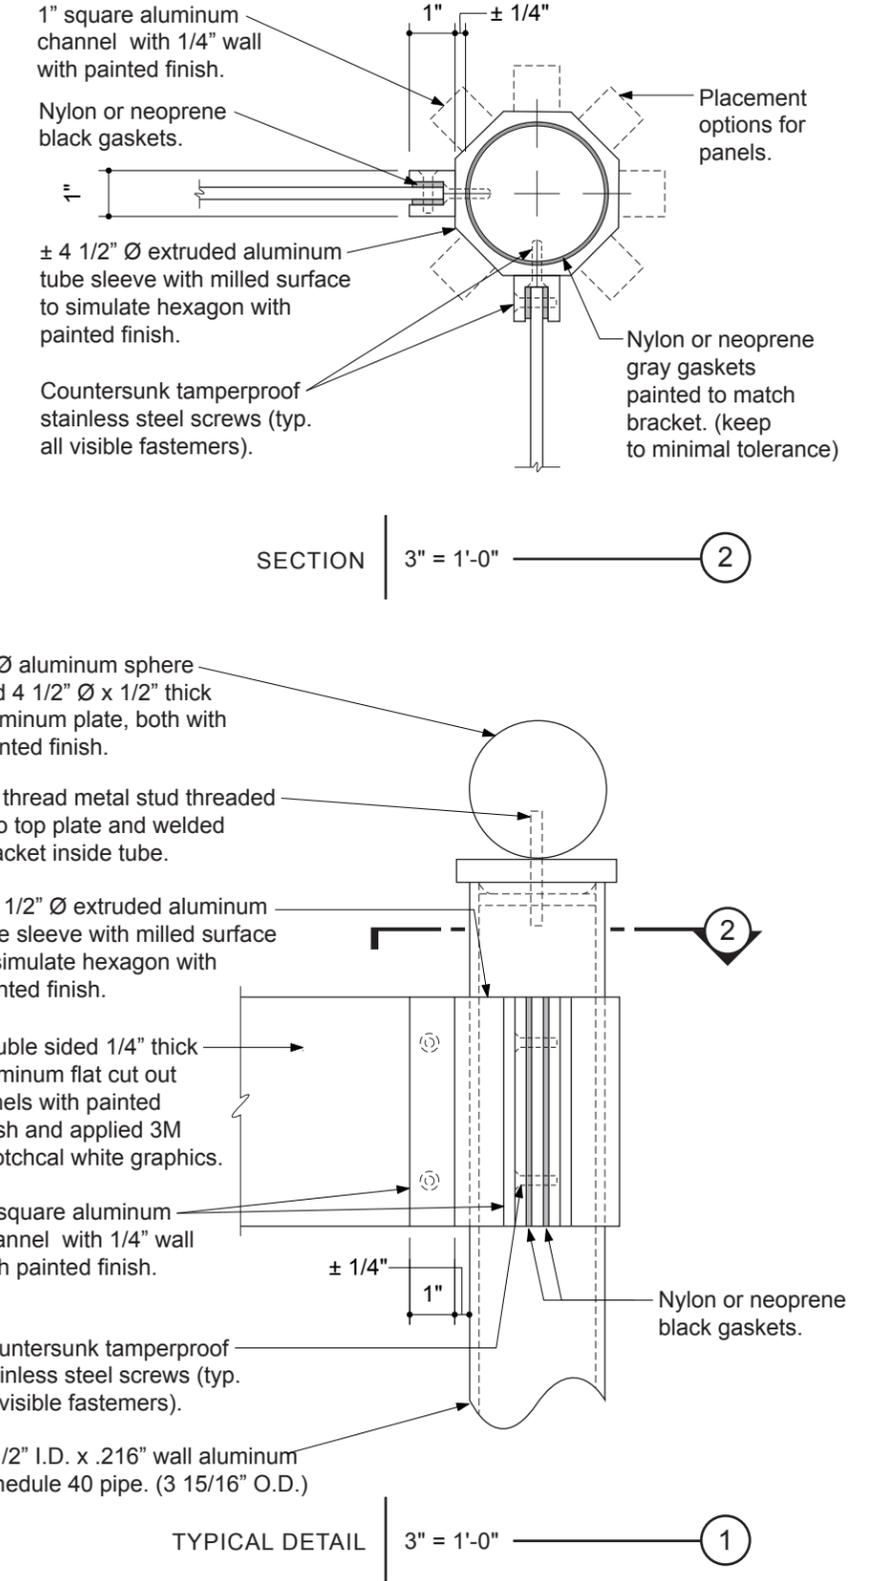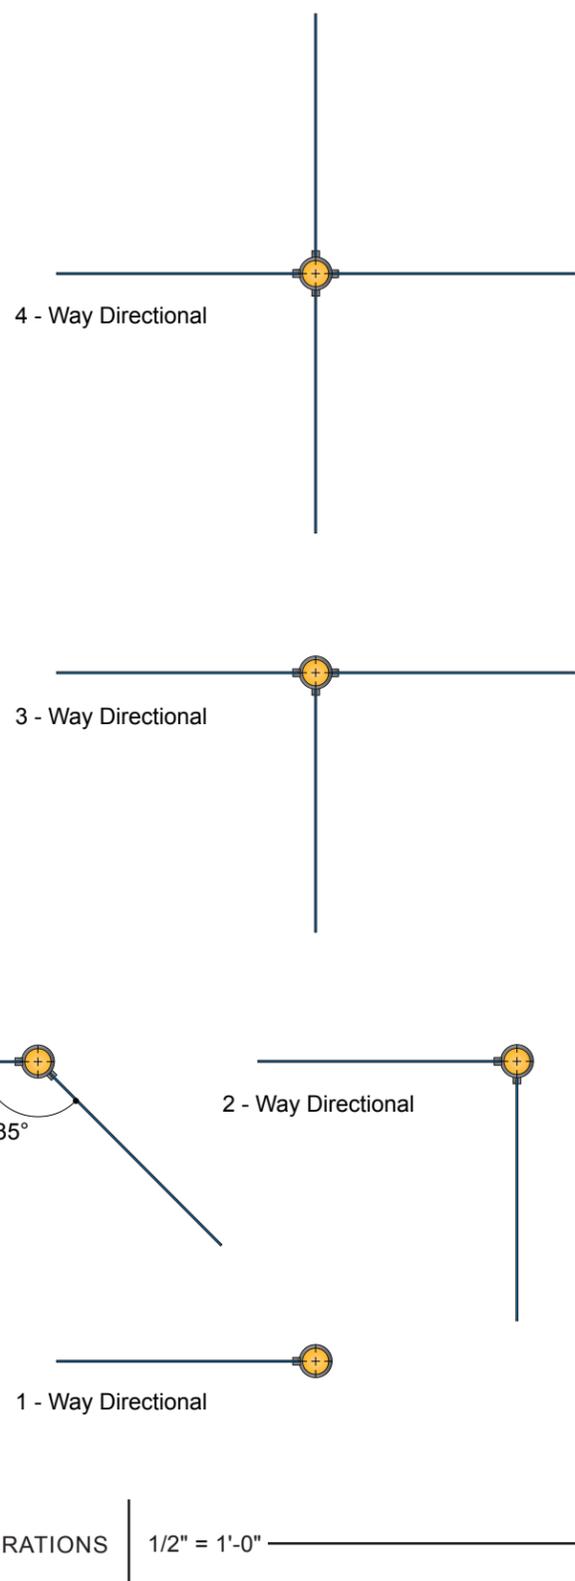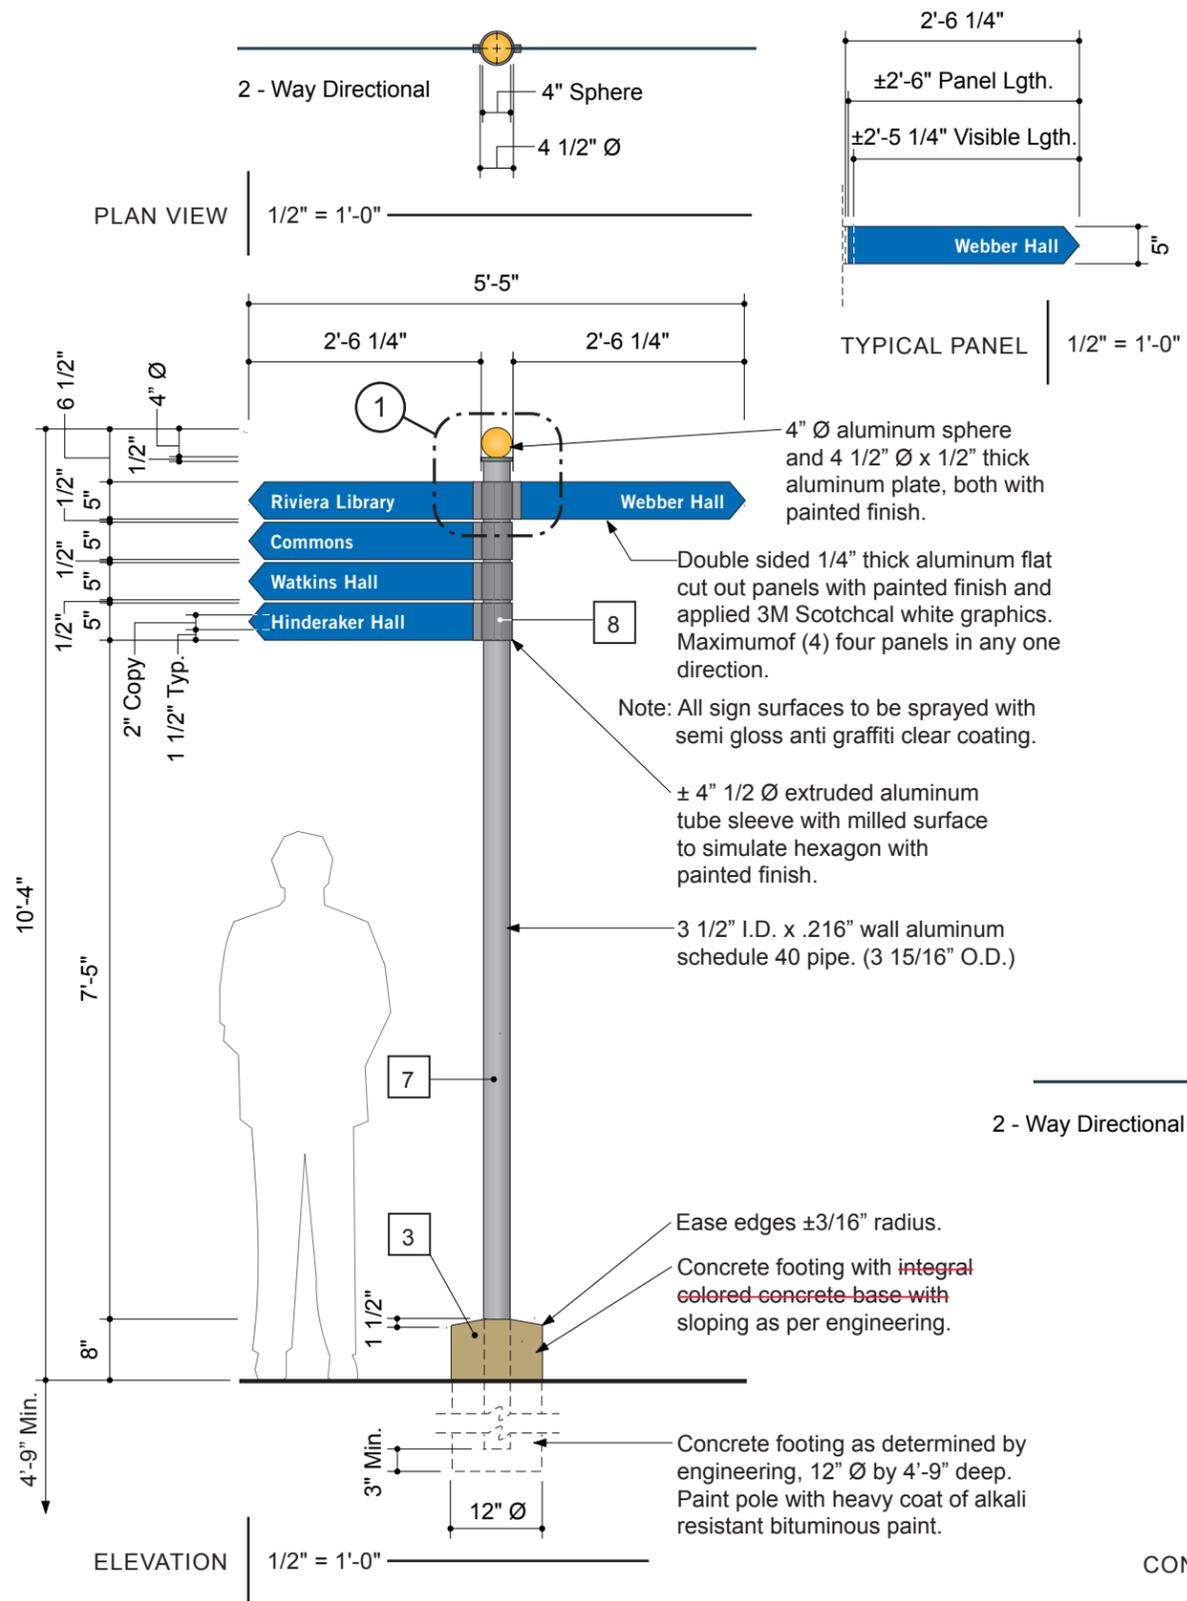


COAST SIGN, INC.
1345 S. ALLEC STREET
ANAHEIM, CA 92805

PAGE: 1 of 2
PROJECT: UC RIVERSIDE
SUBJECT: RIVERSIDE, CA
SIGN STRUCTURAL CALCS.
BY: DVM DATE: 10-3-07
P.O.# DWGS. FROM PERRY SHIMOJI

FOR COLUMN & FOOTING DESIGN

AREA -- SIGN TYPE W32.0 - DIRECTIONALS
A = 1.8' * 5.47' = 9.8 S.F. (MAX. AREA)
A = 7.86' * 0.25' = 2.0 S.F. (COL.)
A = 0.67' * 1.0' = 0.7 S.F. (BASE)

NOTE: 2-WAY DIRECTIONAL GOVERNS
FOR WIND -- OTHER CONFIGURATIONS
ARE O.K. BY INSPECTION.

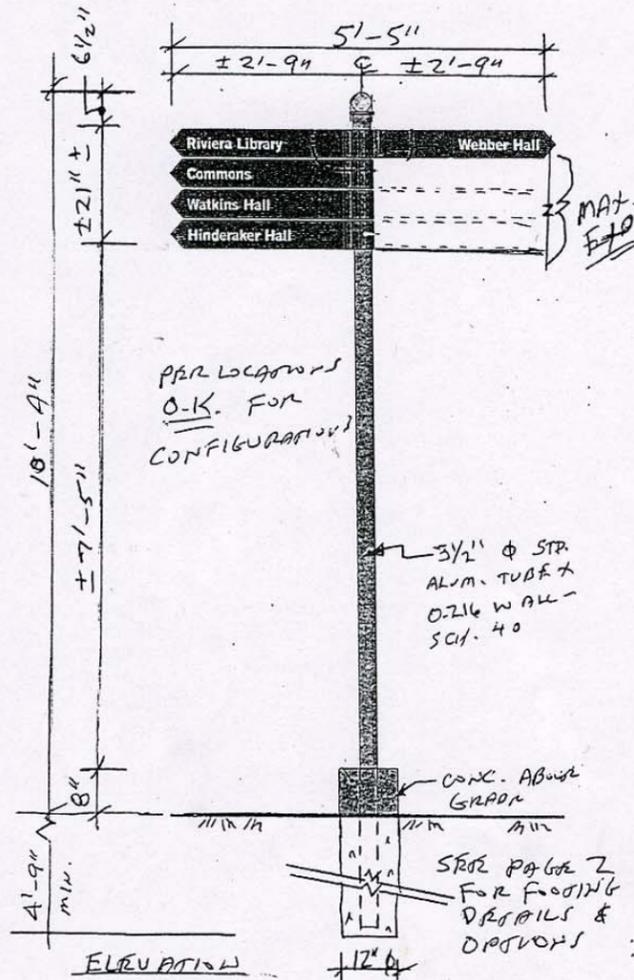

WIND CBC-'01 80 MPH EXP. C

| | | |
|----------|----------------------|-------------|
| CBC-1613 | $p=Cq*Ce*Qs*I$ | $I=1.0$ |
| $Qs =$ | 16.4 | $Cq = 1.4$ |
| | 25.94 LBS/S.F. @ 20' | $Ce = 1.13$ |
| | 24.34 LBS/S.F. < 15' | $Ce = 1.06$ |
| S.F. | LBS | FT. |
| AREA | !PRESS! | X-DIST |
| | | MOM-XX |

| | | | |
|-----|-----|------|------|
| 9.8 | 239 | 9.00 | 2147 |
| 2.0 | 49 | 4.00 | 195 |
| 0.7 | 17 | 0.34 | 6 |
| 0.0 | 0 | 0.00 | 0 |

TOTAL 304 7.72 2347 (AVE.)

SINGLE COLUMN MOM. 'K 2.35

ALUM $F_y = 12$ K/SQ. IN.
 $S = M/P_b$ WIND 1/3 INCR.
 $S = 0.75 * M$ (INCL 1.33 WIND)
 $S = 1.76$ IN³

$t = 0.216$ IN. (MIN. THK.)
 $S = .0982 * (d^4 - d_1^4) / d$
 $d = 4$ $d_1 = 3.568$

USE MIN. 3.5" DIA. x 0.216 ALUM. PIPE

$S = 2.31$ IN³ > 1.76 O.K.

WT. OF SIGN = 130 LBS +/-
AXIAL STRESS IS NEGLIGIBLE

COAT ALUM. SURFACES EMBEDDED IN CONC. WITH ONE HEAVY COAT OF ALKALI-RESISTANT BITUMINOUS (BITUMASTIC PAINT -- SUCH AS HENRY'S OR EQUIVALENT).

SEE PAGE 2 FOR FOOTING DETAILS



SOB No. HUNT-1A7


HUNT DESIGN
25 N. MENTOR AVE.
PASADENA, CA 91106



PAGE: 2 of 2
PROJECT: UC RIVERSIDE
SUBJECT: RIVERSIDE, CA
SIGN STRUCTURAL CALCS.
BY: DVM DATE: 10-1-07
P.O.# DWGS. FROM PERRY SHIMOJI

SINGLE COLUMN
DESIGN OF EMBEDDED POLE FOOTINGS


| DESCRIPTION | 10" DIA. | 12" DIA. | |
|-------------------------|----------|----------|-------|
| CHOOSE ONE | OPTIONAL | OPTIONAL | |
| ALLOW PASSIVE | 200 | 200 | 200 |
| MAX PASSIVE | 1,500 | 1,500 | 1,500 |
| LOAD DURATION FACTOR | 1.33 | 1.33 | 1.33 |
| POINT LOAD | 304 | 304 | 304 |
| LOAD HT. | 7.72 | 7.72 | 7.72 |
| DIST. LOAD | 0 | 0 | 0 |
| START HT. | 0.00 | 0.00 | 0.00 |
| END HT. | 0.00 | 0.00 | 0.00 |
| WIDTH/DIAMETER | 10" | 12" | 0 |
| CIRCULAR? | Y | Y | Y |
| RESTRAINED? | N | N | N |
| SUMMARY | | | |
| Moments @ Surface: | | | |
| Point Load | 2,347 | 2,347 | 0 |
| Uniform Load | 0 | 0 | 0 |
| ... Total Moment | 2,347 | 2,347 | 0 |
| Total Lateral Load | 304 | 304 | 0 |
| NON-RESTRAINED | | | |
| Min. Req'd Embedment | 5'-2" | 4'-9" | 0.00 |
| $A(1+(1+4.36h/A)^.5)/2$ | 5.06 | 4.72 | |
| $A=2.34P/(S 1 b)$ | | | |
| Press @ 1/3 Embed.: | | | |
| Actual | 449 | 419 | 0 |
| Allowable | 449 | 419 | 0 |
| RESTRAINED | | | |
| Min. Req'd Embedment | 0.00 | 0.00 | 0.00 |
| $(4.25 P h / S 3 b)^.5$ | | | |
| Pressure @ Bottom | | | |
| Actual | 0 | 0 | 0 |
| Allowable | 0 | 0 | 0 |
| Surface Restraint | | | |
| Force | 0 | 0 | 0 |

PER CBC TABLE 18-1-
POLE 2x ALLOWABLE

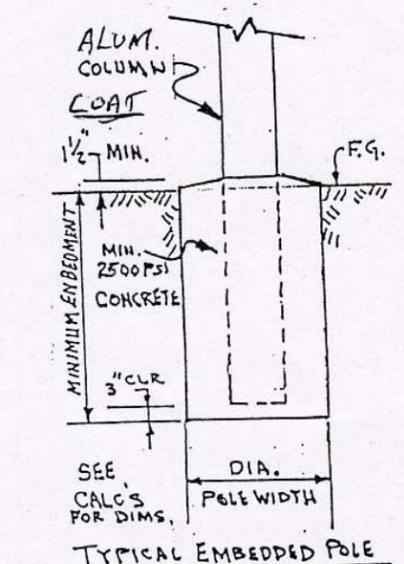

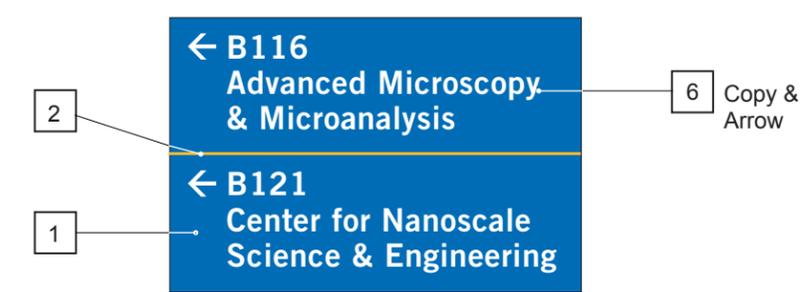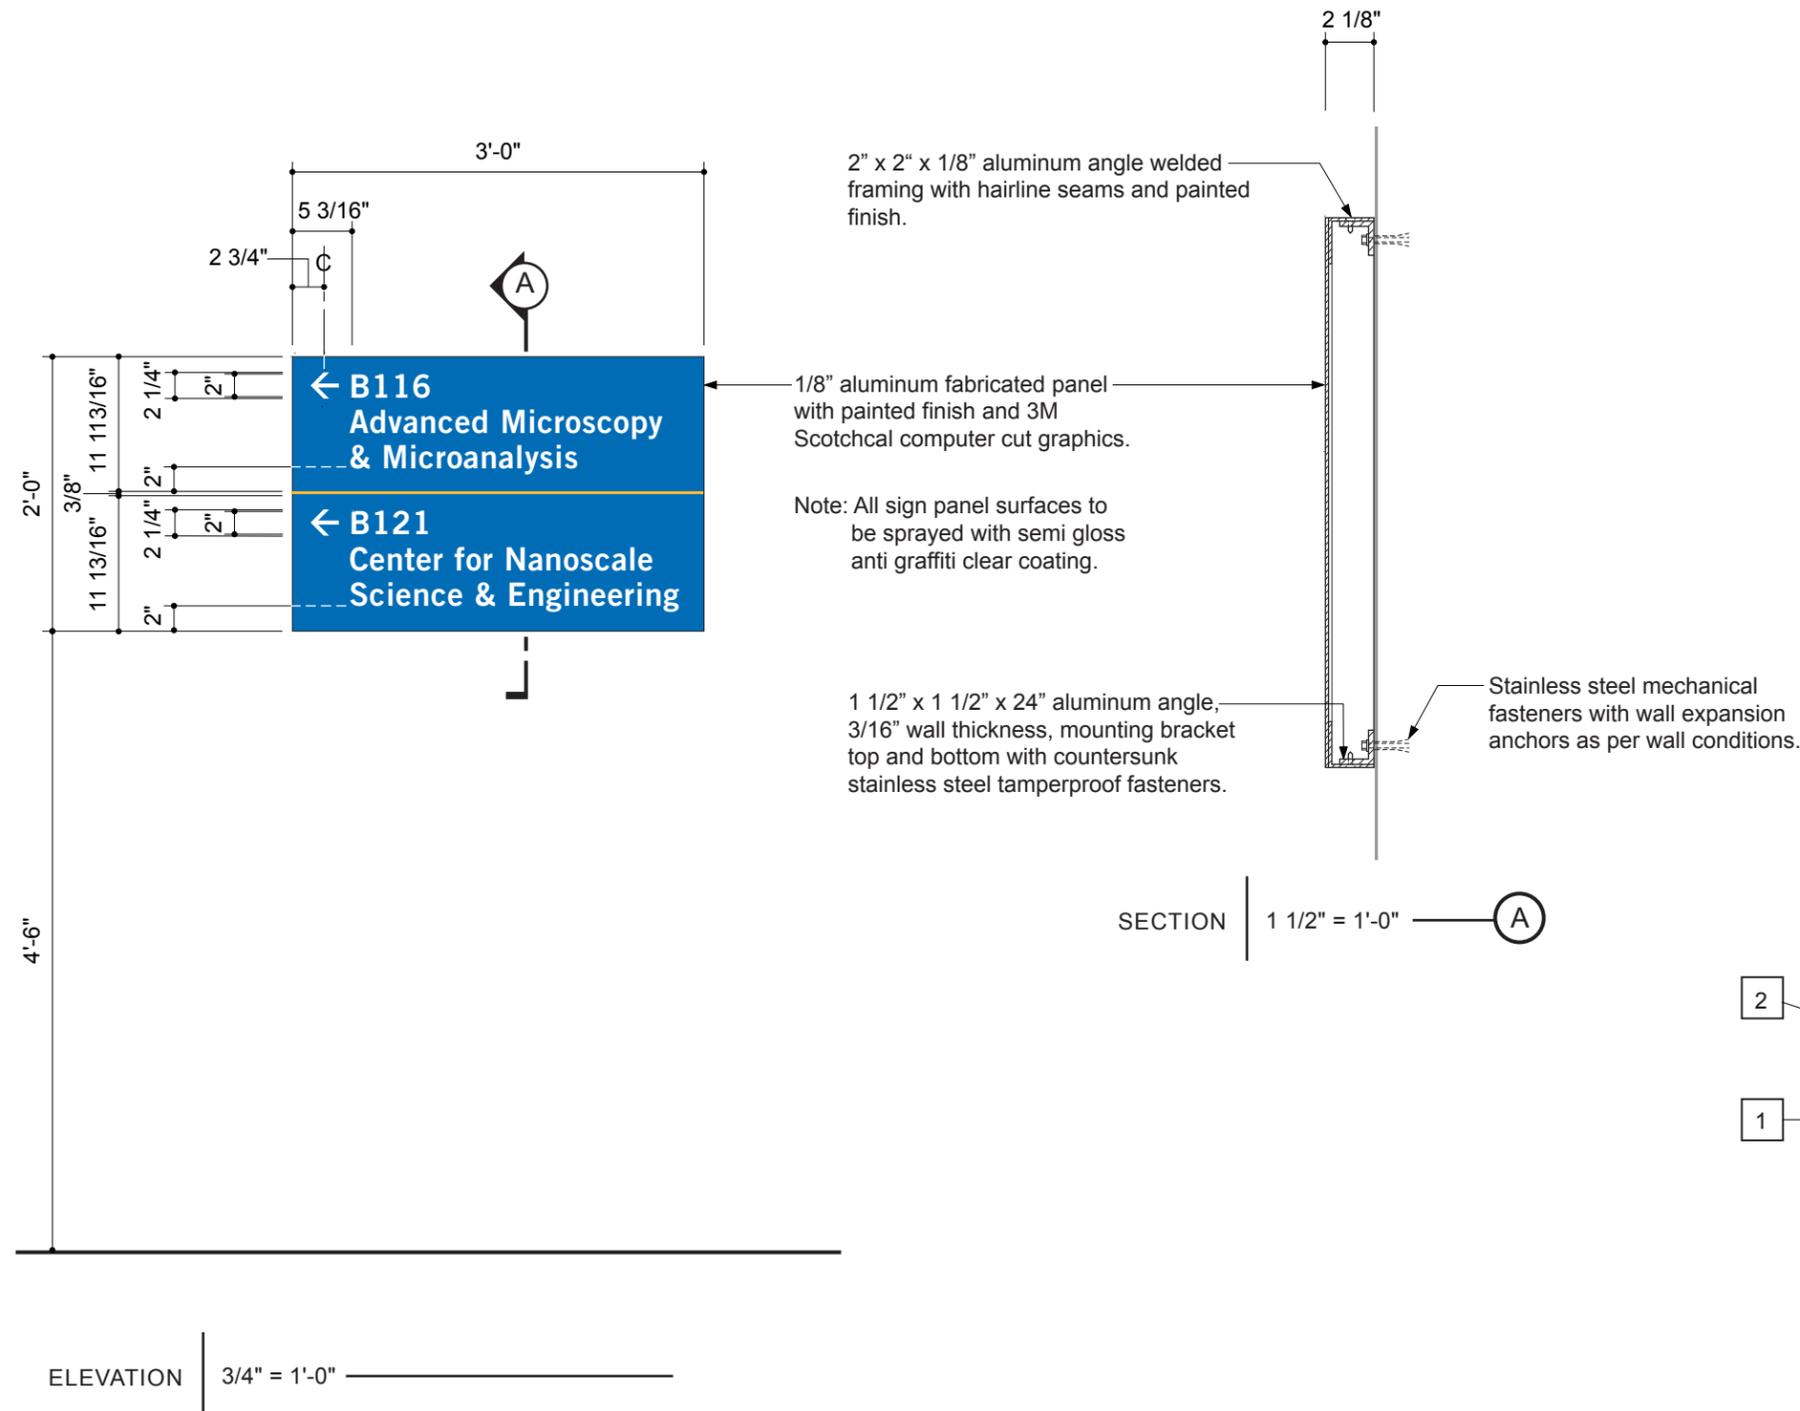


Note: All sign surfaces to be sprayed with semi gloss anti graffiti clear coating.

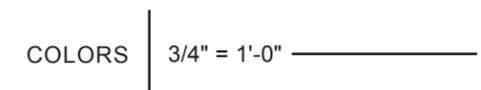




ELEVATION | 1" = 1'-0" — "ARROW" CONFIGURATIONS


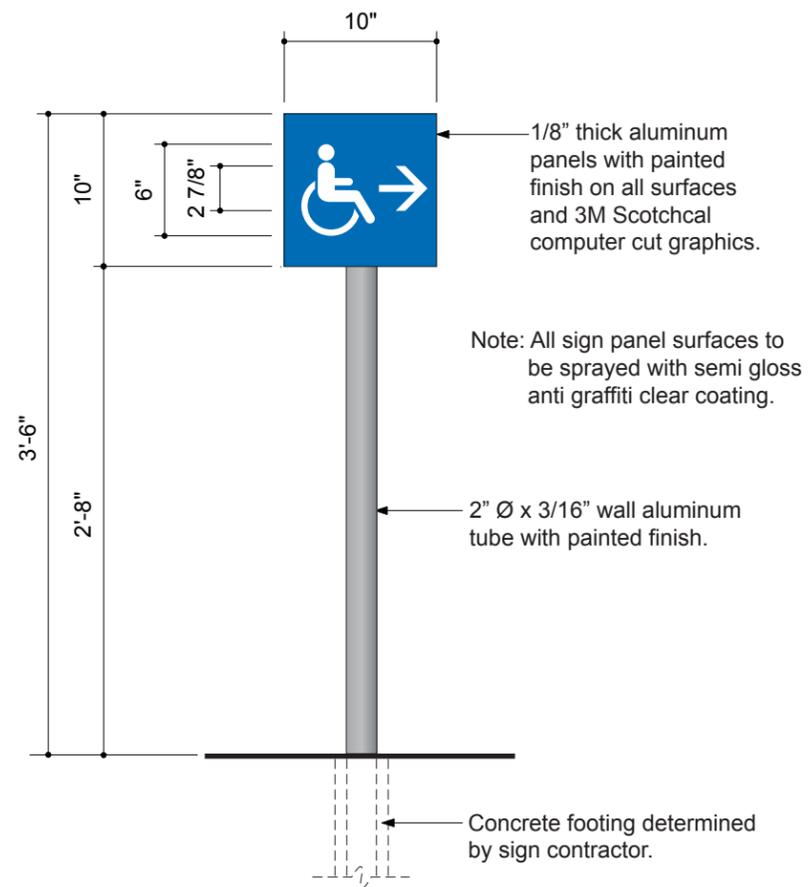


ELEVATION | 1" = 1'-0" — LAYOUT OPTION "A"

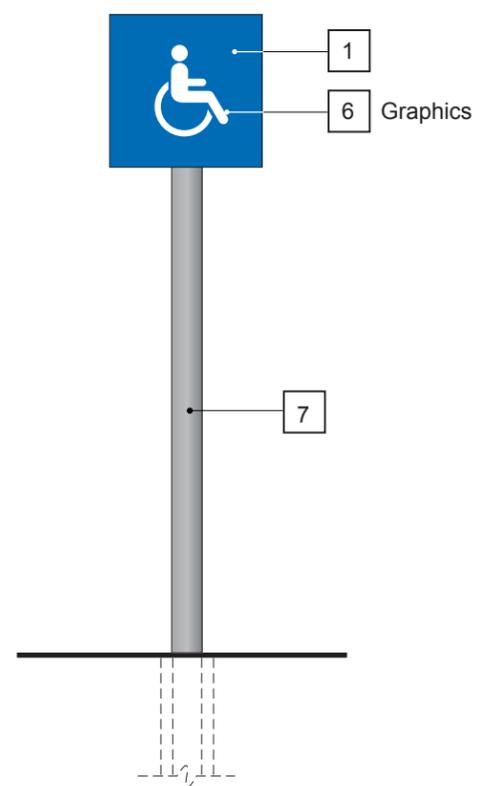


ELEVATION | 1" = 1'-0" — LAYOUT OPTION "B"


Note:
This sign cannot be used within any path of travel.
The height from the ground to the bottom of the sign is less than the minimum 80 inches ADA requirement for signs located in a path of travel.

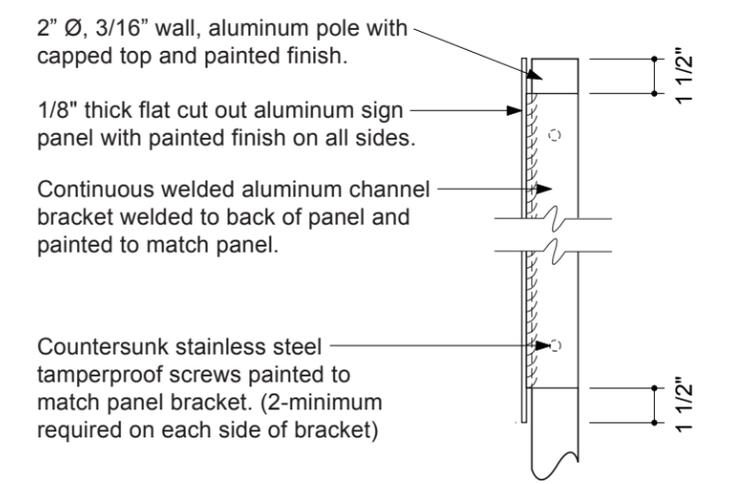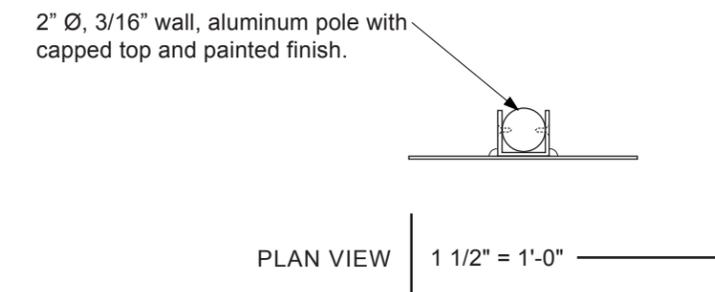

SIDE VIEW | 1 1/2" = 1'-0"

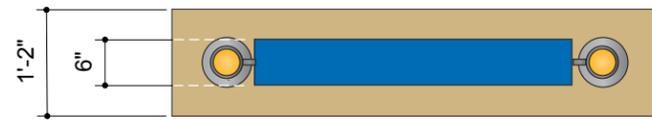


PLAN VIEW 1/2" = 1'-0"

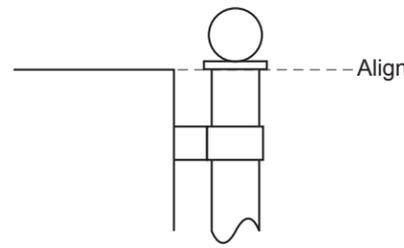


FINIAL DETAIL 1" = 1'-0"


Exterior grade transparent colored digital print with U.V. inhibitors for exterior use and adhesive backing applied to #7238 white acrylic panel.

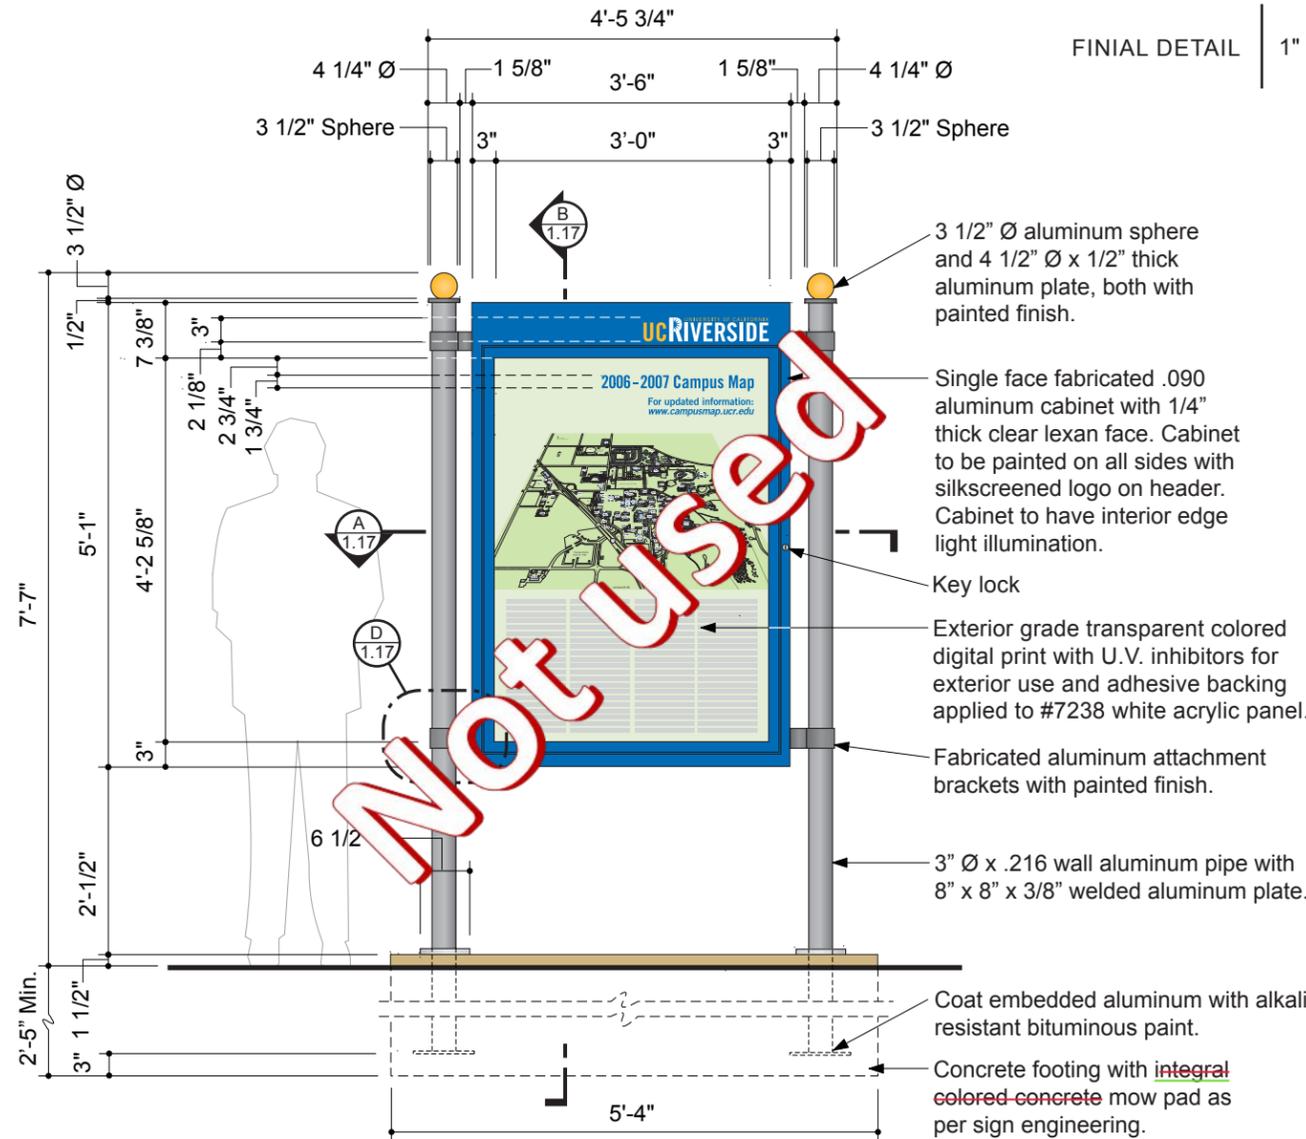

ELEVATION 1/2" = 1'-0"

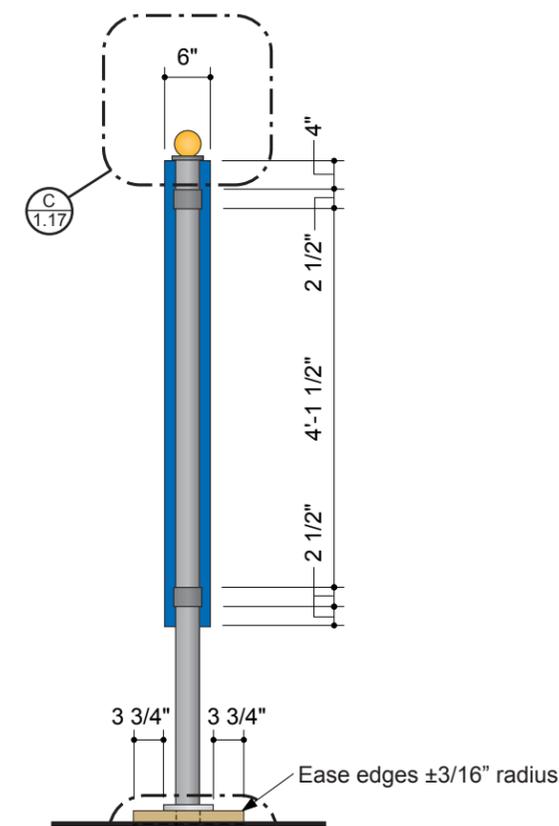


SIDE VIEW 1/2" = 1'-0"

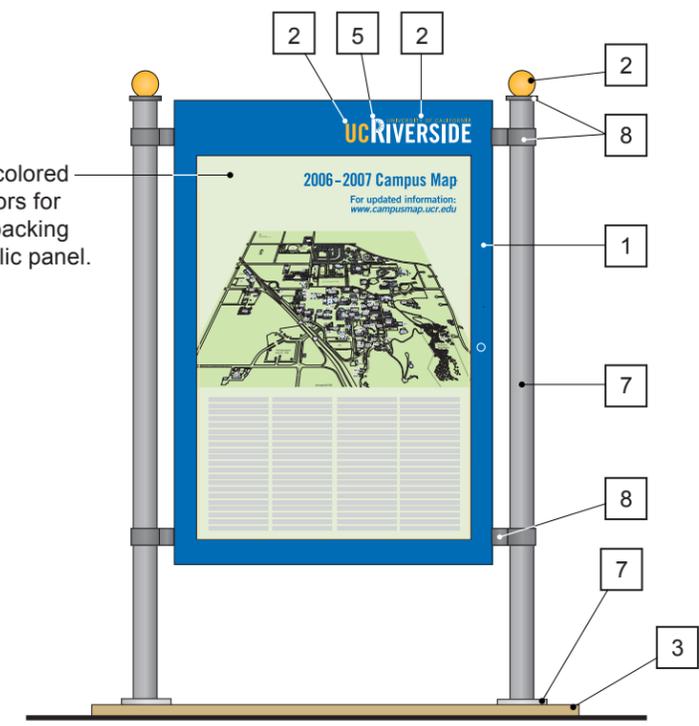

COLORS | N.T.S.



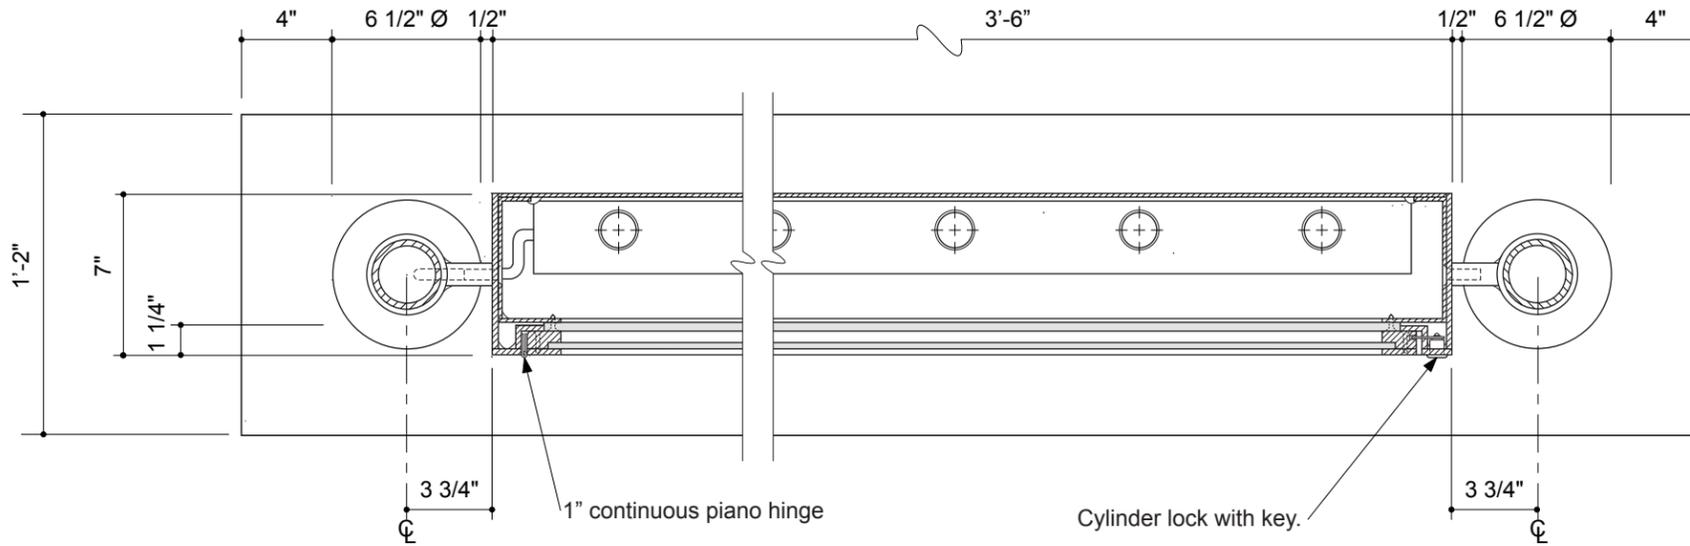

1/4" thick header panel with side returns with painted finish.

Fabricated .090 aluminum cabinet with painted finish. Seams welded, grounded and filled smooth or hairline seams. Cabinet interior to be painted.

Welded 1/4" wall aluminum angle door frame with seams welded, grounded and filled smooth or hairline seams. All visible of door framing to be painted.




Stainless steel countersunk mechanical fasteners.

1/4" thick clear lexan door face


3/8" thick #7328 white acrylic with surface applied translucent colored digital map and copy with U.V. inhibitors. Use translucent vinyl diffuser on back if necessary to achieve even illumination.





Internal back light fluorescent lamps with interior wireway. Cabinet interior not visible from outside to be painted white.


1" x 1 1/2" aluminum flat bar lexan retainer frame fastened to back of aluminum door facing with countersunk screws.

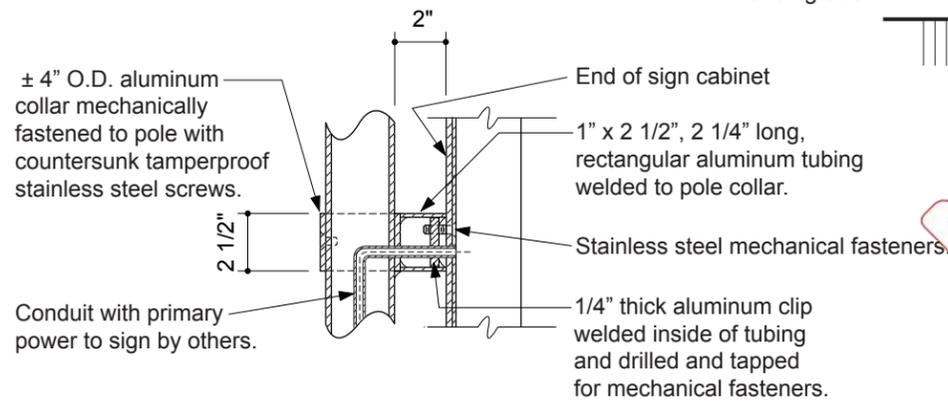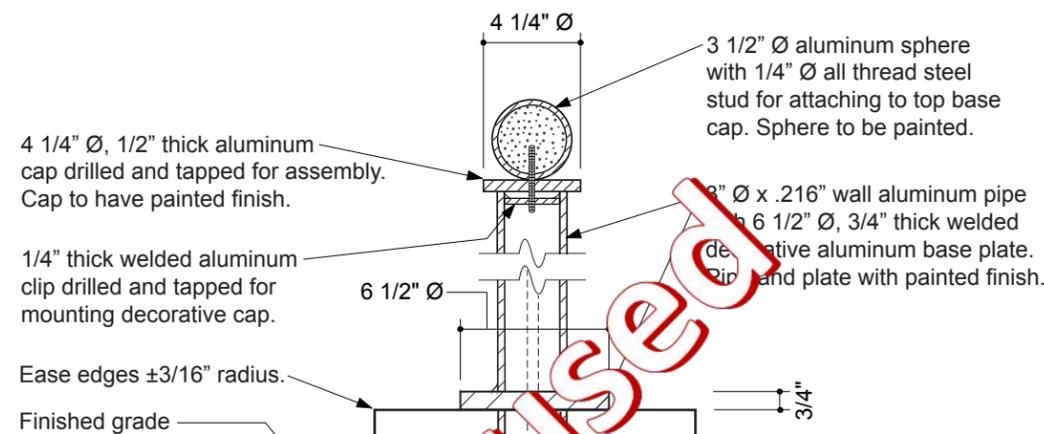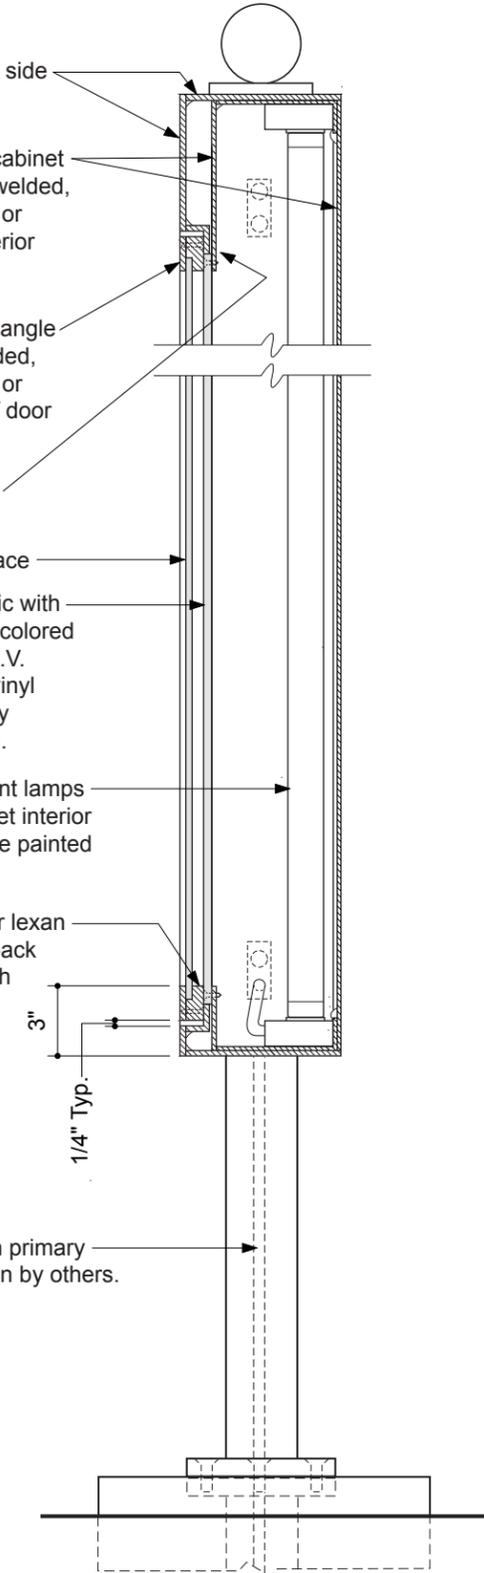




Not Used

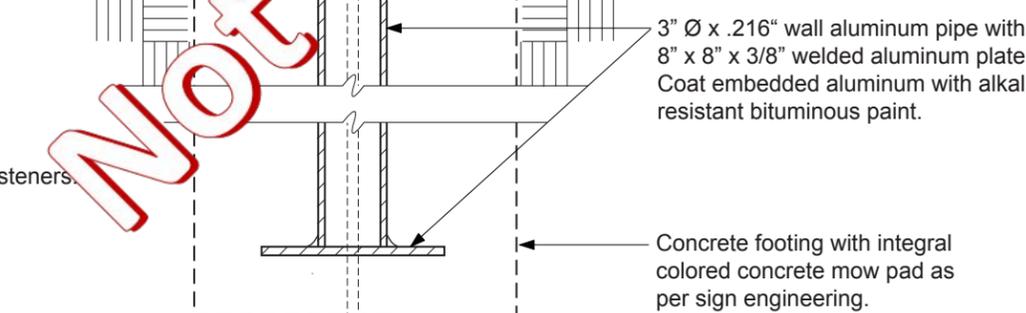

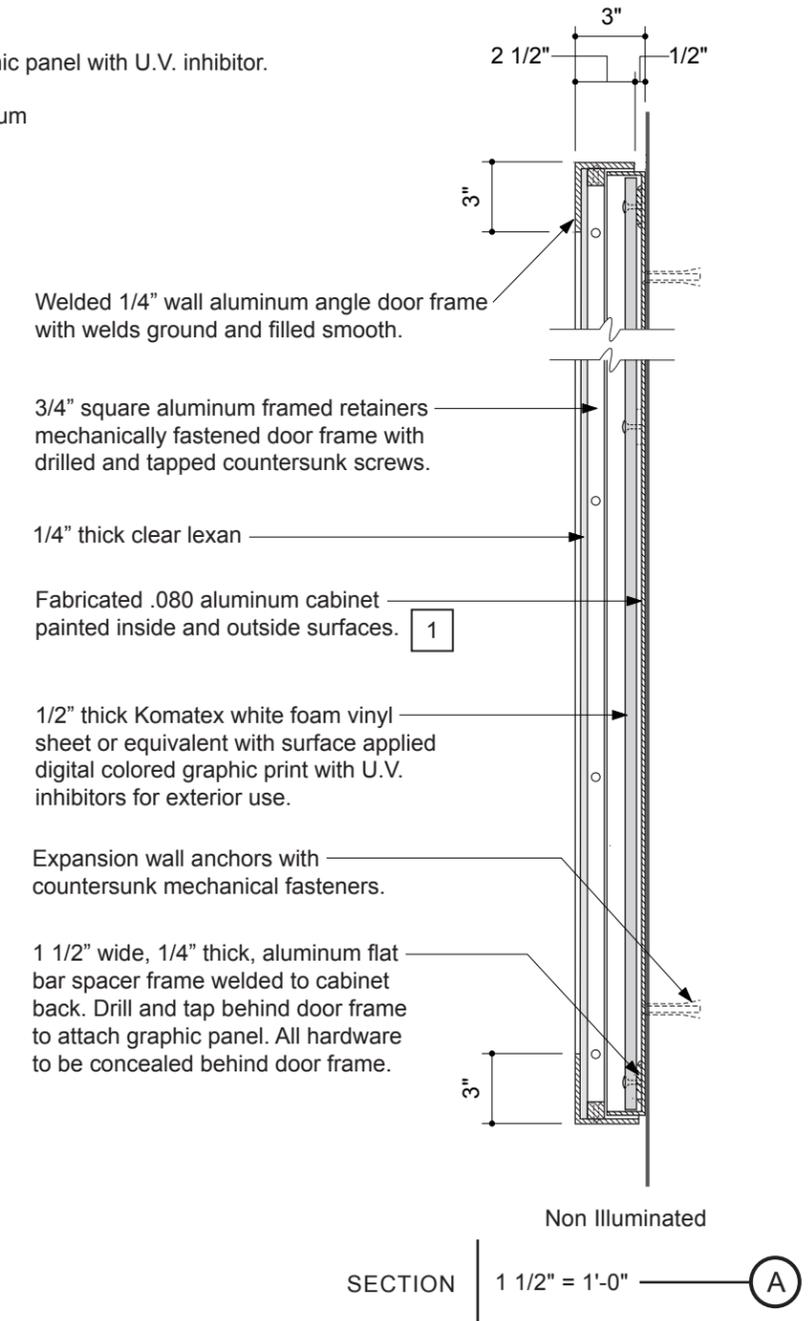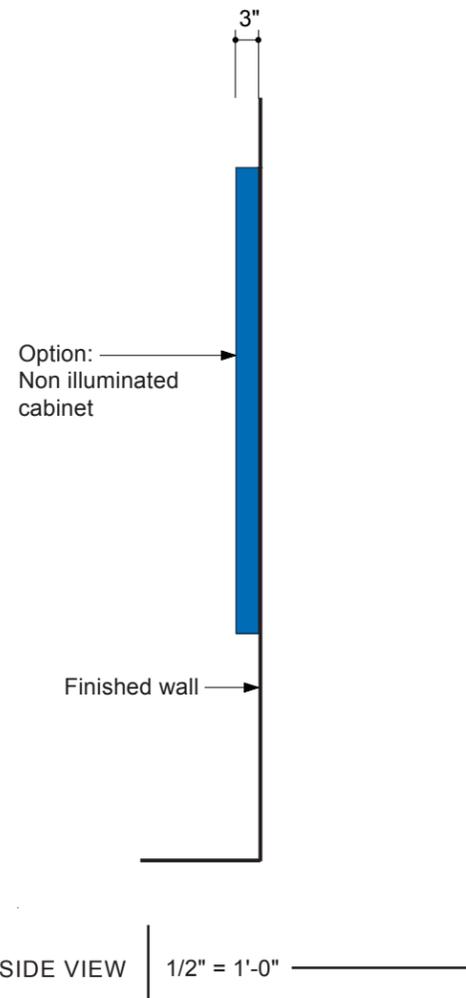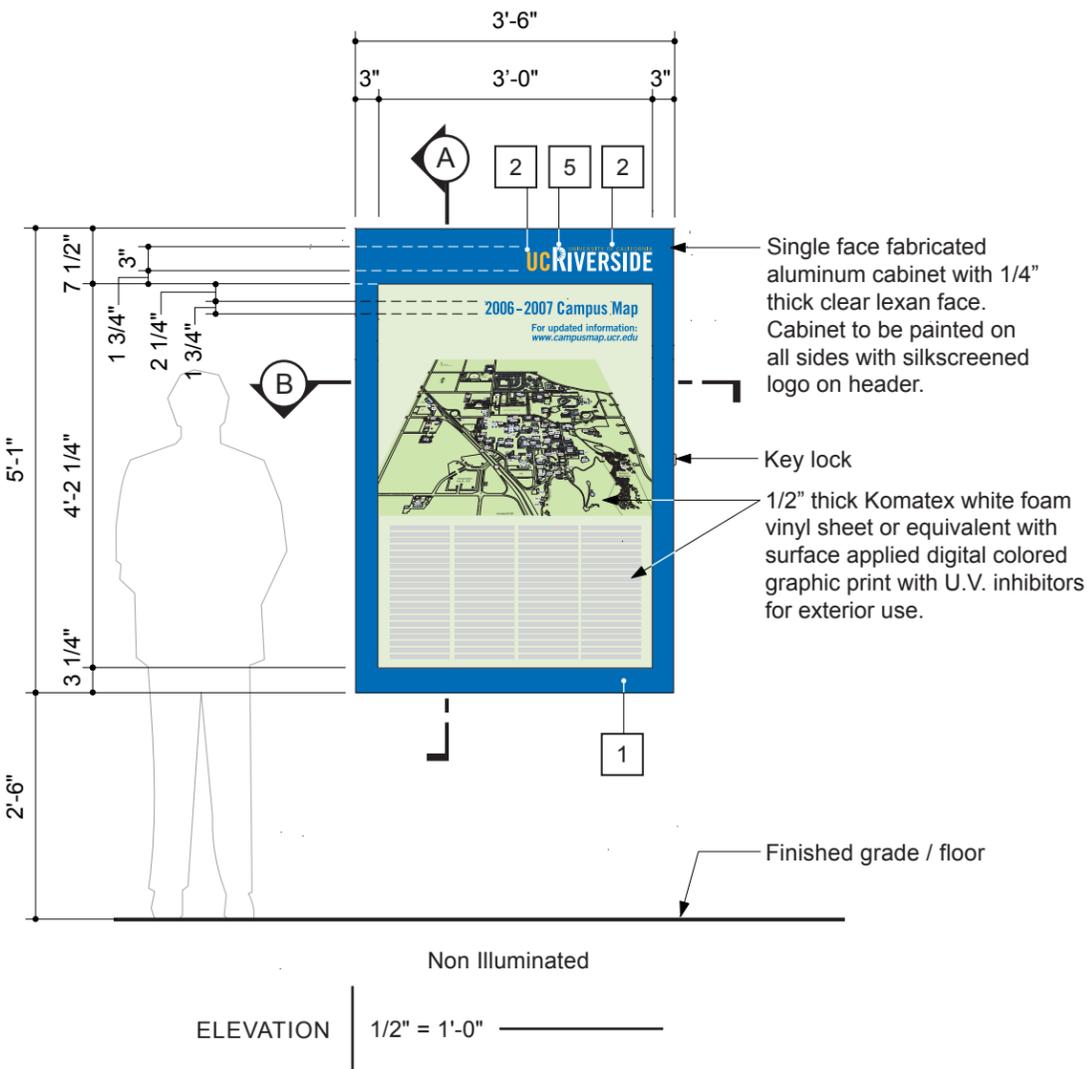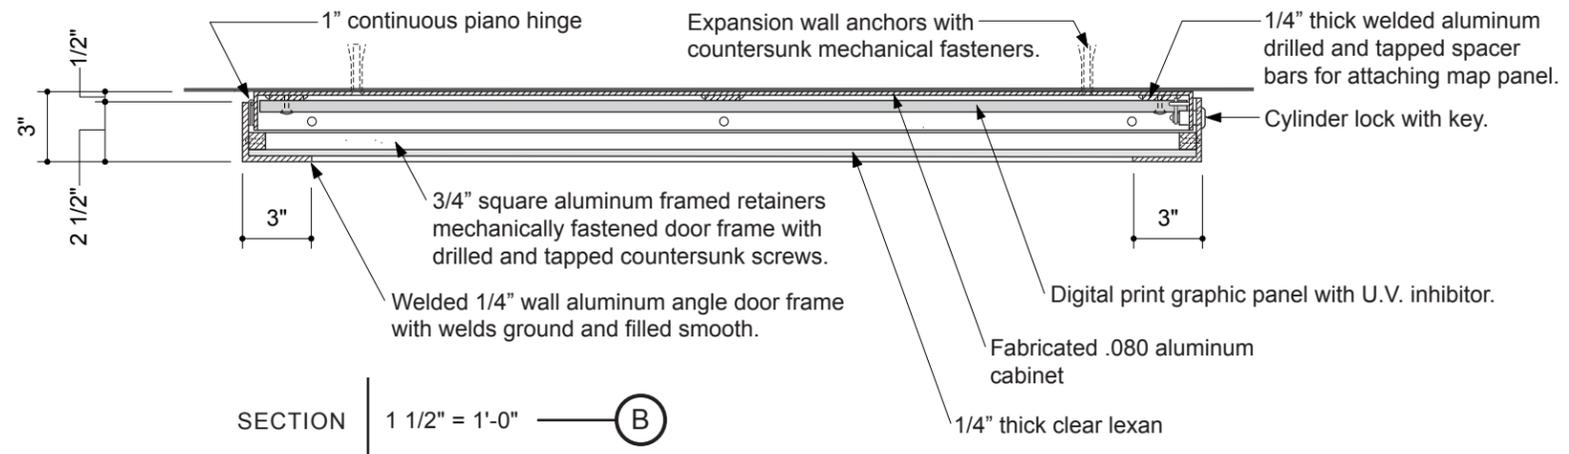

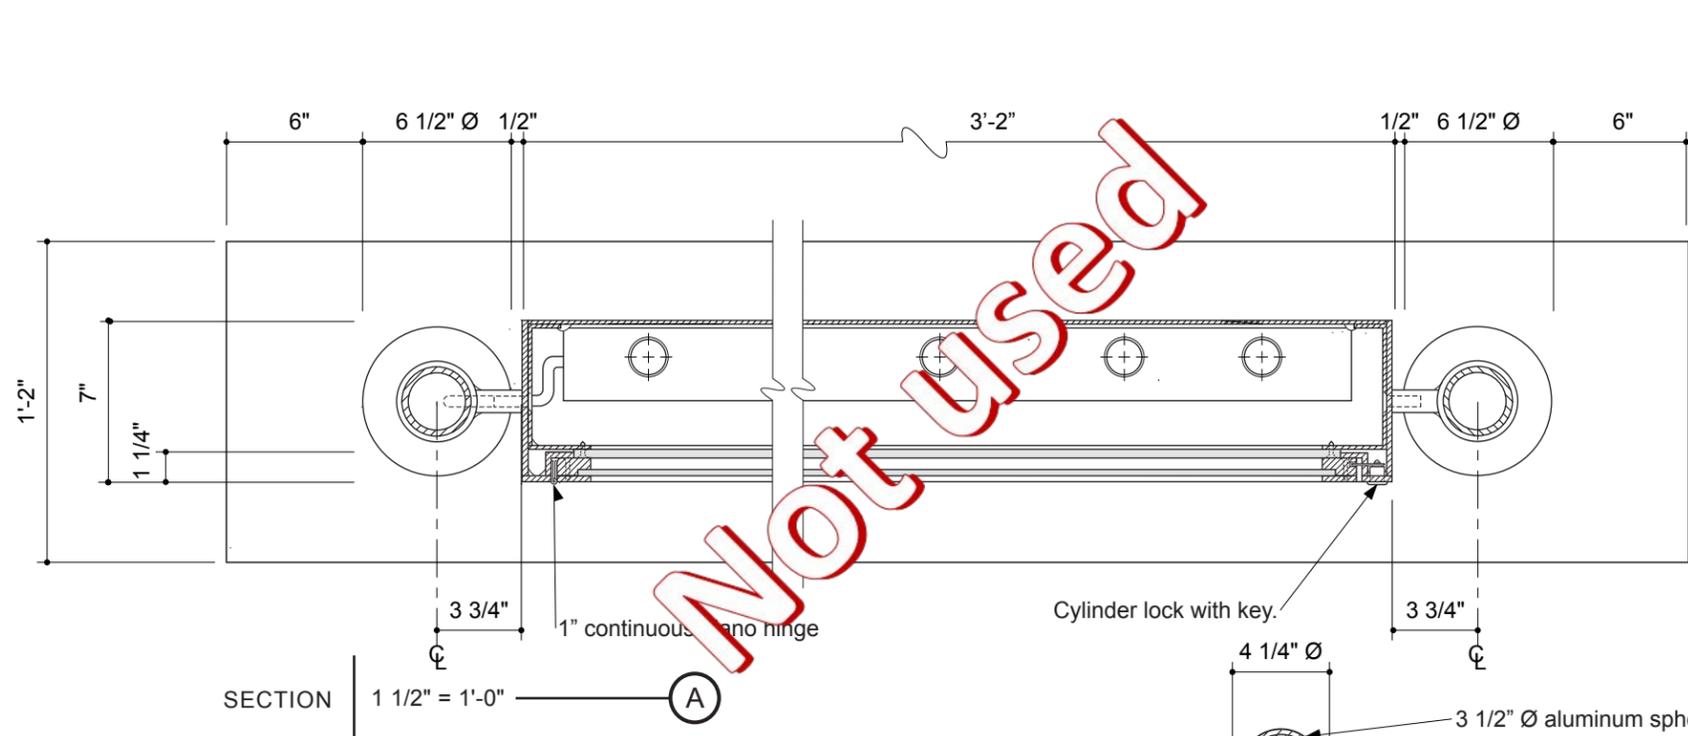

Not used

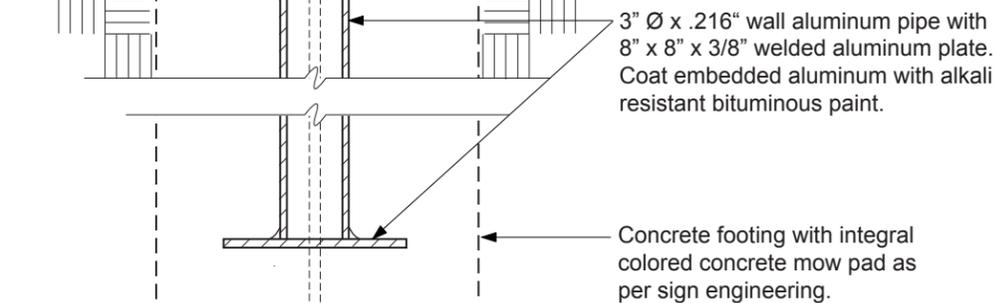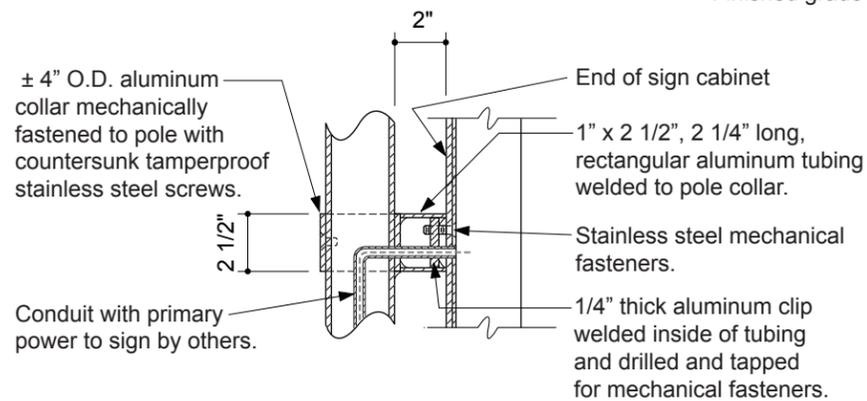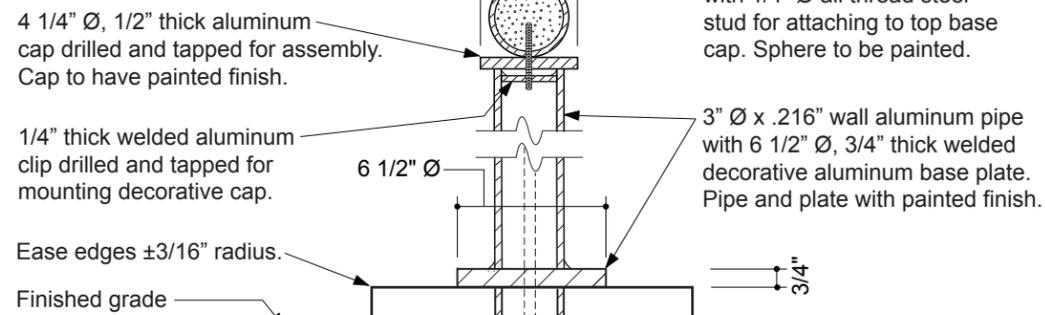

1/4" thick header panel with side returns with painted finish.

Fabricated .090 aluminum cabinet with painted finish. Seams welded, grounded and filled smooth or hairline seams. Cabinet interior to be painted.

Welded 1/4" wall aluminum angle door frame with seams welded, grounded and filled smooth or hairline seams. All visible of door framing to be painted.


Stainless steel countersunk mechanical fasteners.



1/4" thick clear lexan door face


3/8" thick #7328 white acrylic with surface applied translucent colored digital map and copy with U.V. inhibitors. Use translucent vinyl diffuser on back if necessary to achieve even illumination.

Internal back light fluorescent lamps with interior wireway. Cabinet interior not visible from outside to be painted white.

1" x 1 1/2" aluminum flat bar lexan retainer frame fastened to back of aluminum door facing with countersunk screws.

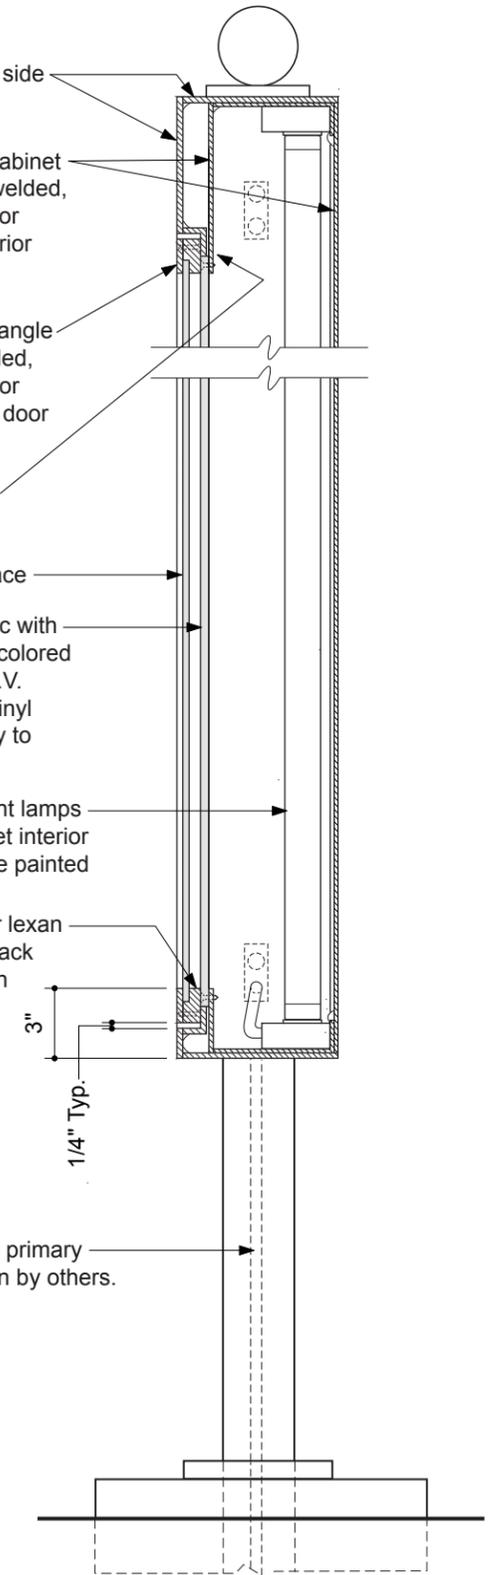

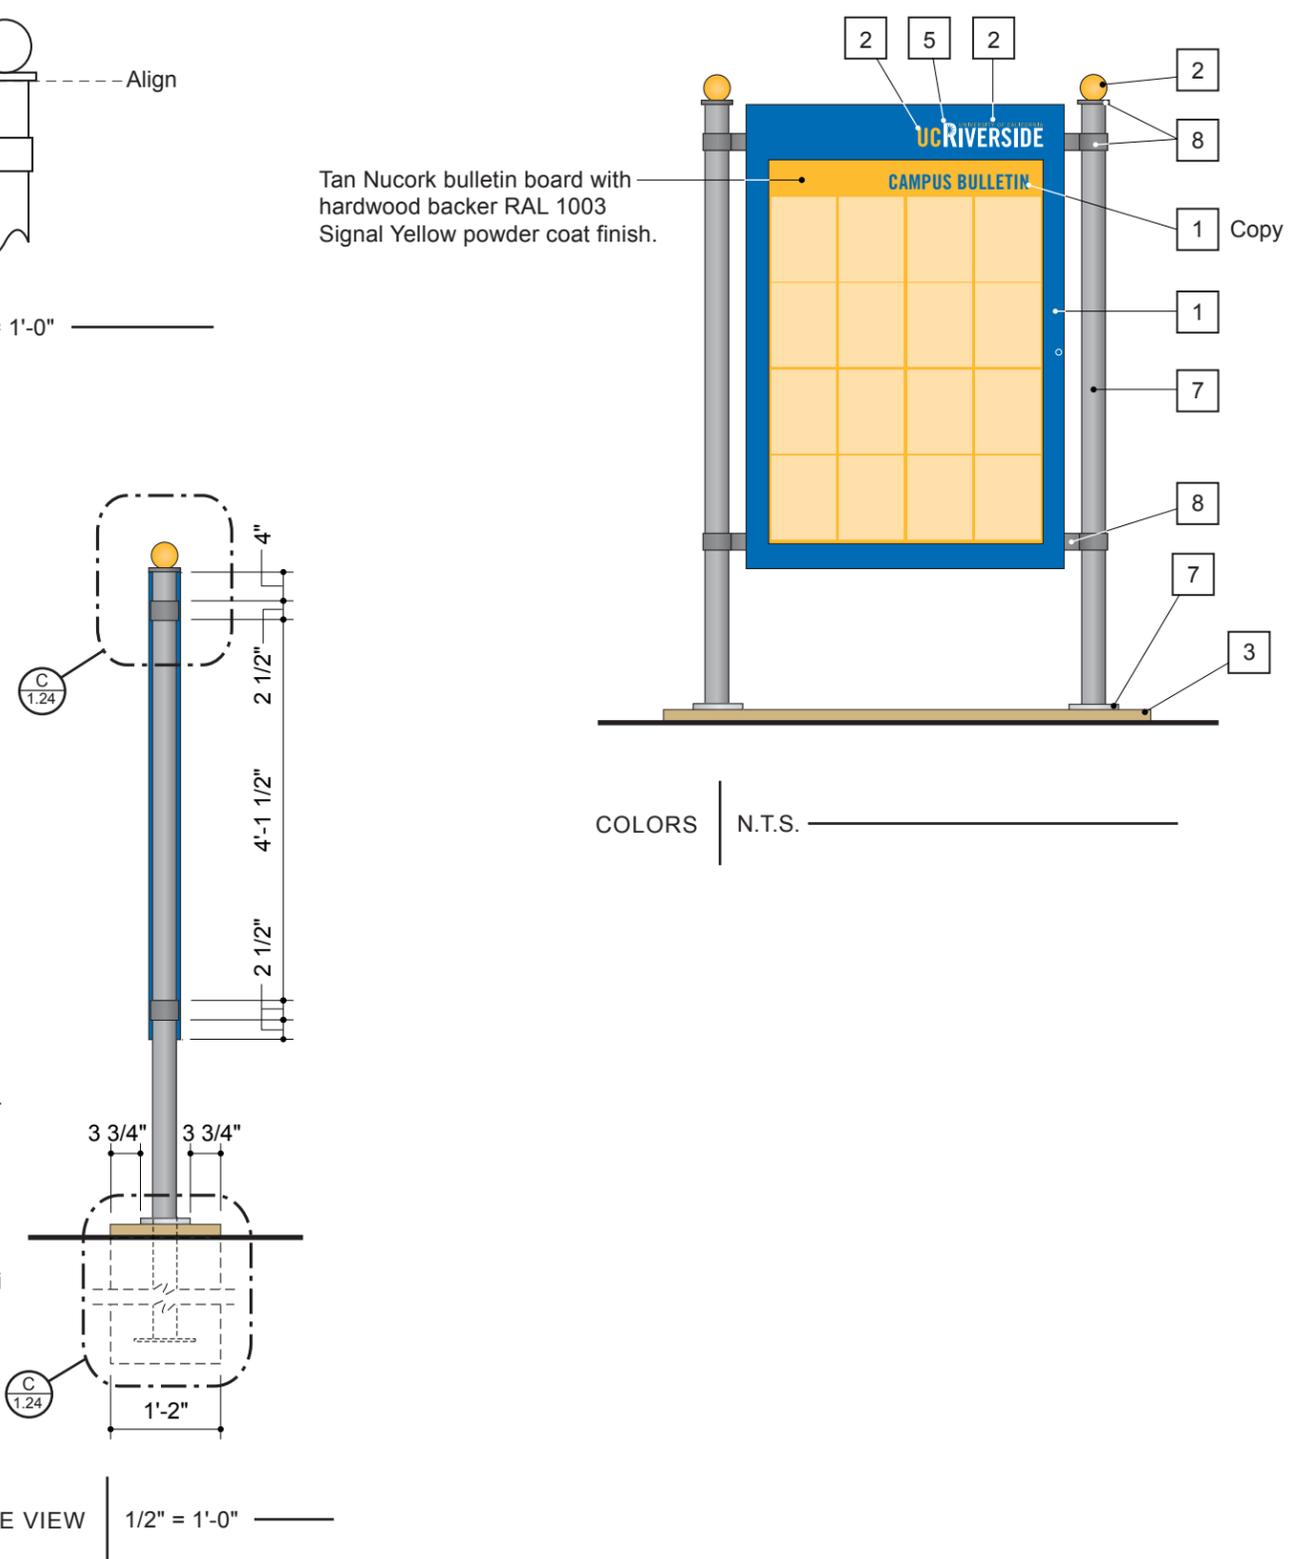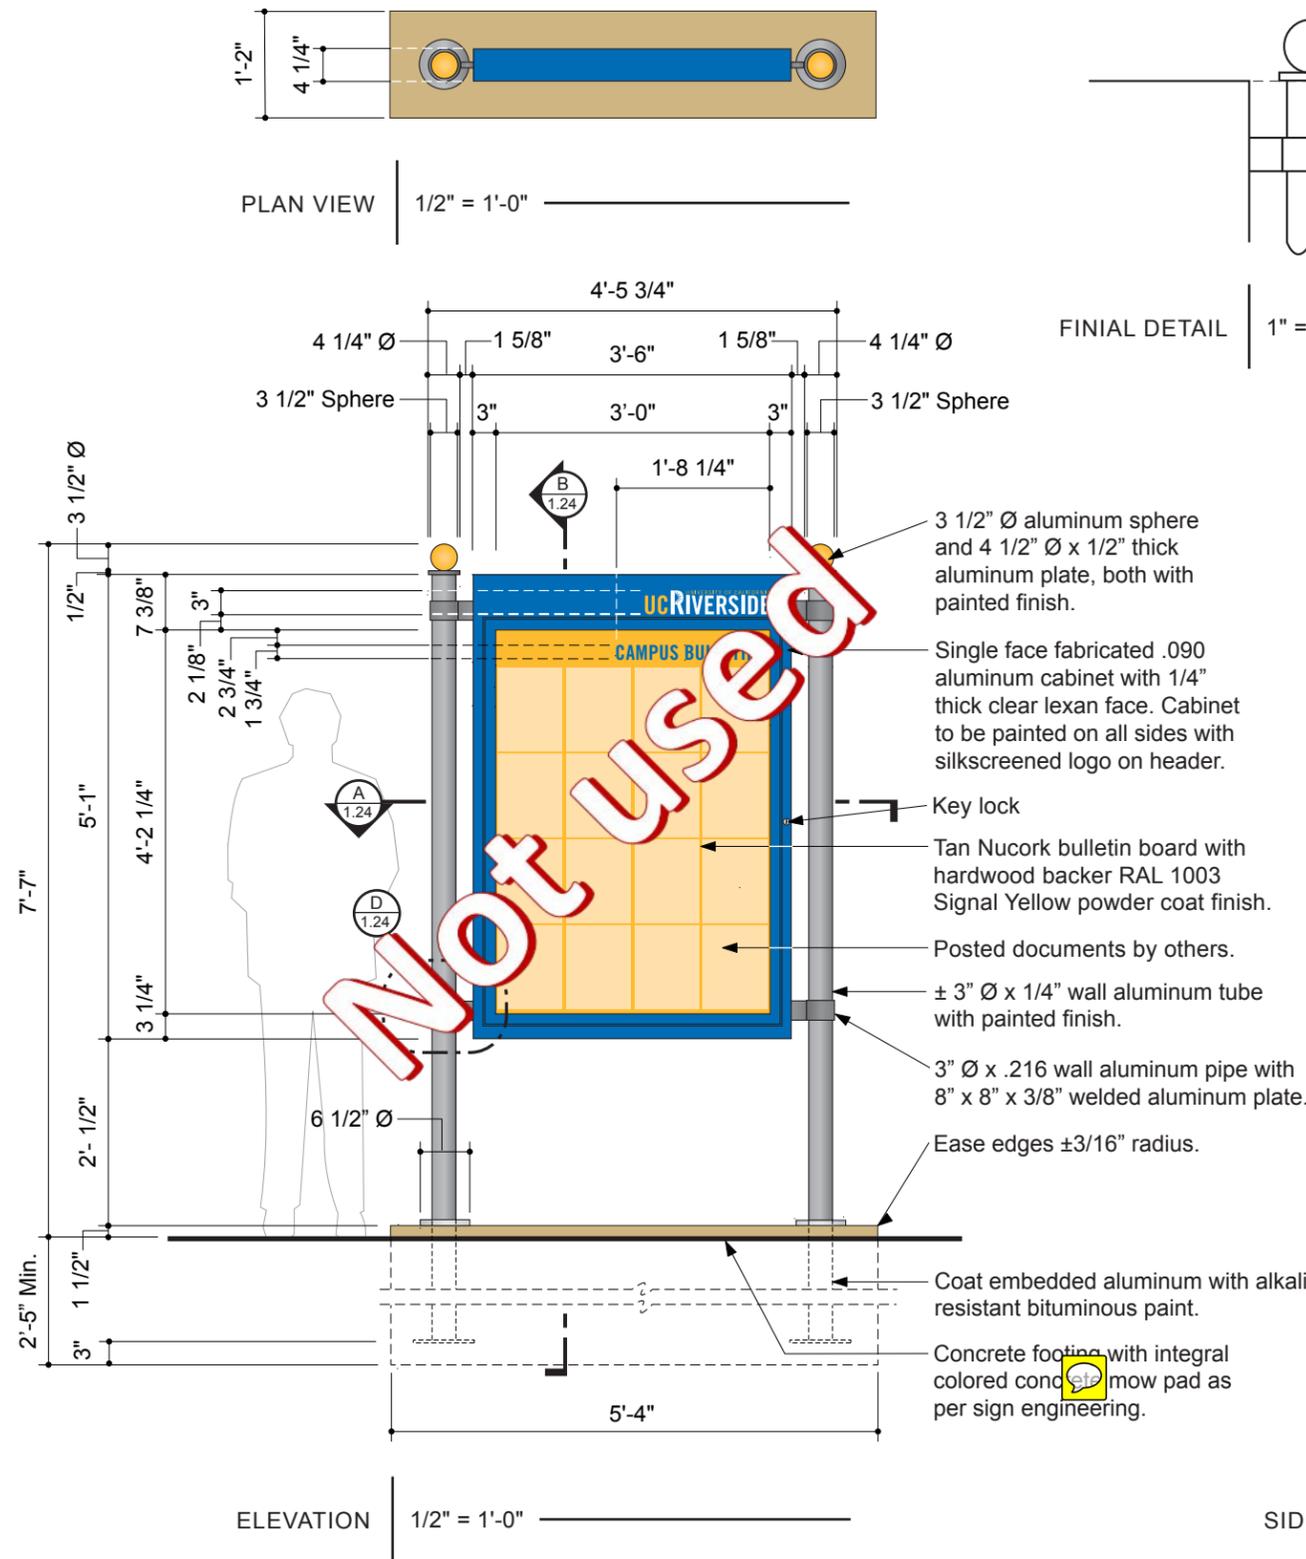

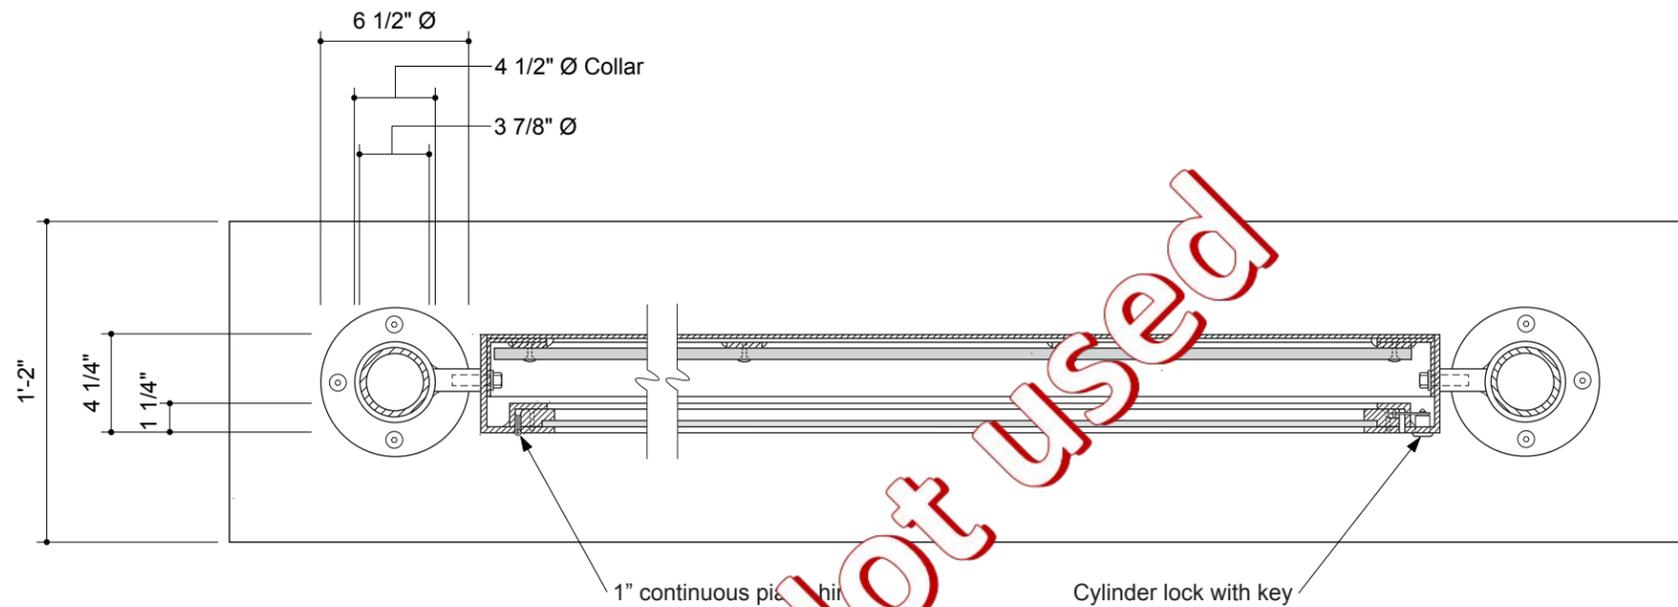

Not used

Welded 1/4" wall aluminum angle cabinet wrap with welds ground and filled smooth or hairline seams.

Welded 1/4" wall aluminum door frame face trim with welds ground and filled smooth.

3/4" x 1 1/4" aluminum flat bar retainer frame mechanically fastened to door face trim. Drilled and tapped using countersunk stainless steel screws.




1/4" thick clear lexan.

Fabricated .080 aluminum cabinet pan with all inside and outside painted surfaces.

Tan Nucork bulletin board with hardwood backer RAL 1003 Signal Yellow powder coat finish.

Welded 1 1/2", 1/4" thick, aluminum flat support framing welded to back of cabinet. Drill and tap to fasten graphic panel.

Countersunk mechanical fasteners around perimeter concealed behind door trim.

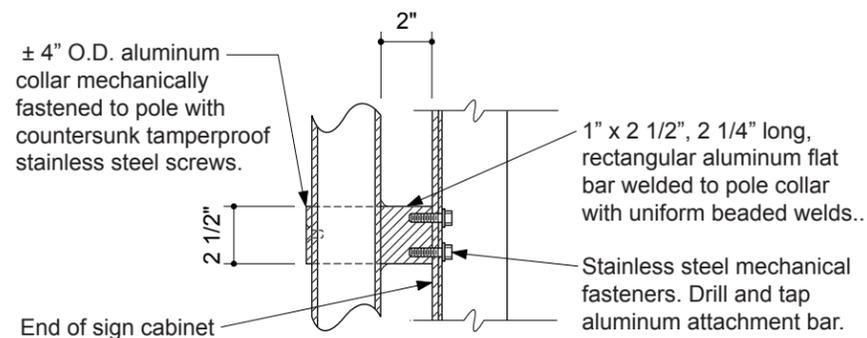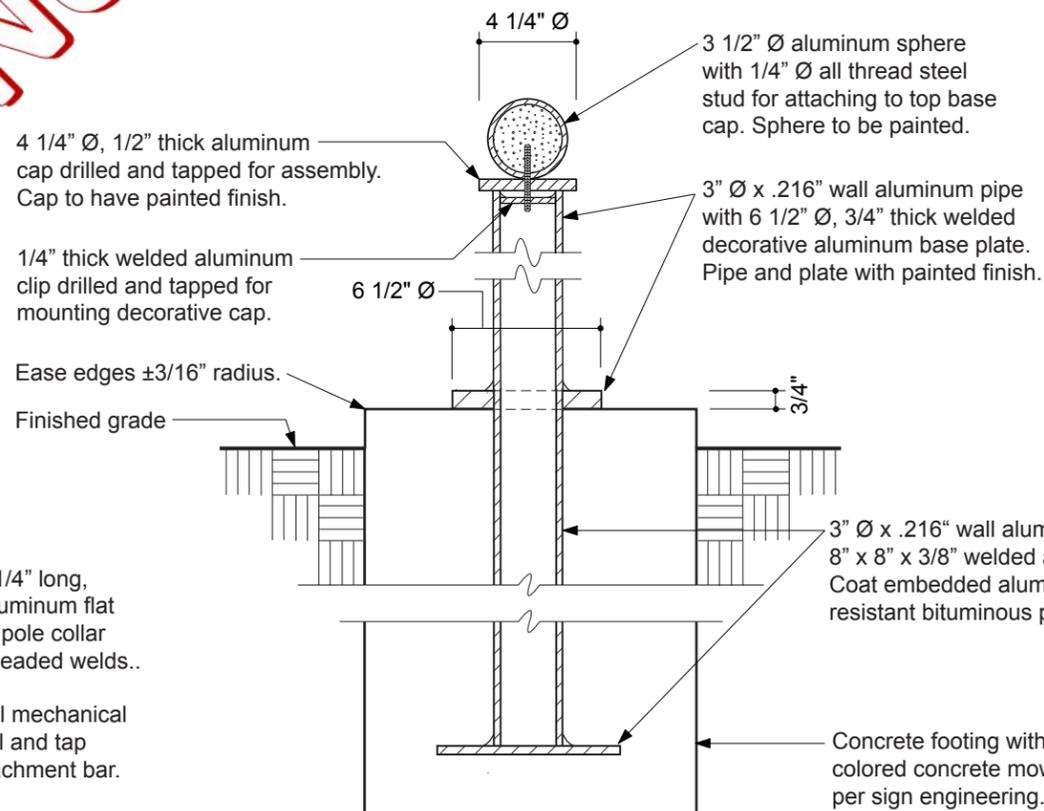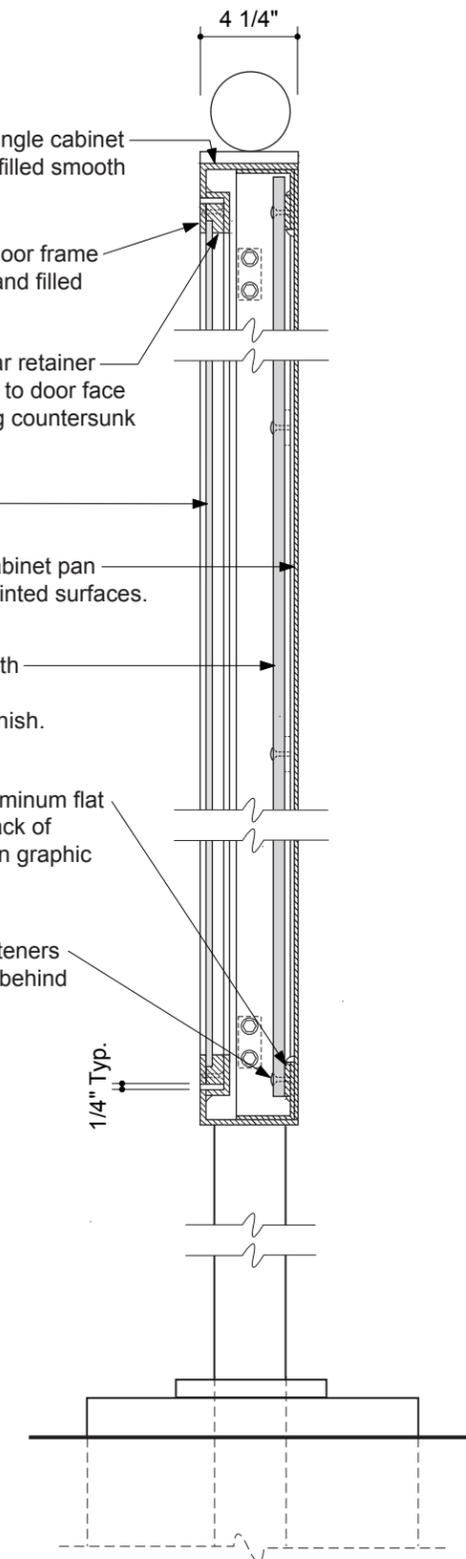


COAST SIGN, INC.
1345 S. ALLEC STREET
ANAHEIM, CA 92805

PAGE: 1 of 2
PROJECT: UC RIVERSIDE
SUBJECT: RIVERSIDE, CA
SIGN STRUCTURAL CALCS.
BY: DVM DATE: 10-3-07
P.O.# DWGS. FROM PERRY SHIMOJI

FOR COLUMN & FOOTING DESIGN

AREA -- SIGN TYPE W40.0 & W42.0
A = 3.5' * 5.25' = 18.4 S.F.
A = 6.88' * 0.25' * 2 COL. = 3.4 S.F.

NOTE: SIGN TYPE W42.0 IS SLIGHTLY
SMALLER IN SIZE THAN W40.0 -
COLUMN & FOOTING DESIGN FOR BOTH
IS O.K. BY INSPECTION

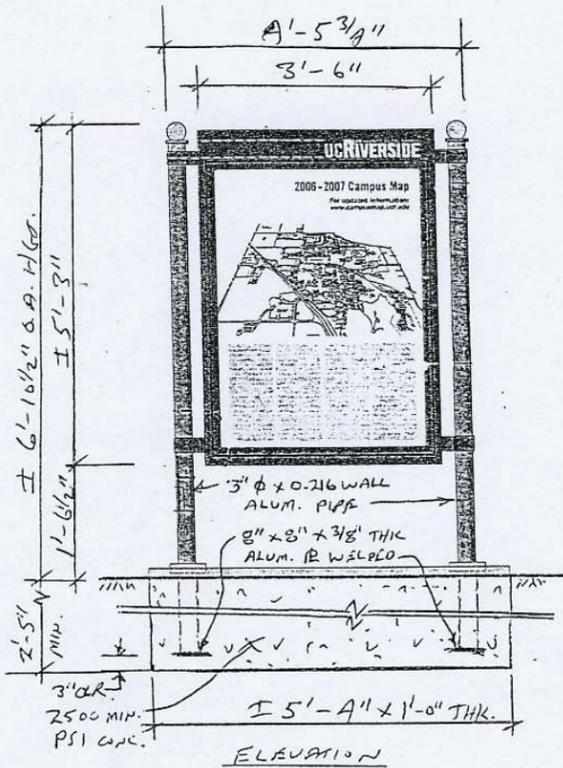

| | | |
|----------|----------------------|-----------------|
| WIND | CBC-'01 | 80 MPH, EXP. C |
| CBC-1613 | $p=Cq*Ce*Qs*I$ | $I=1.0$ |
| Qs = | 16.4 | Cq = 1.4 |
| | 25.94 LBS/S.F. @ 20' | Ce = 1.13 |
| | 24.34 LBS/S.F. < 15' | Ce = 1.06 |
| S.F. | LBS | FT. FT. LBS |
| AREA | !PRESS! | X-DIST ! MOM-XX |
| 18.4 | 448 | 4.26 1908 |
| 3.4 | 83 | 3.44 285 |
| 0.0 | 0 | 0.00 0 |
| 0.0 | 0 | 0.00 0 |

| | | | |
|---------------|------|--------|------|
| TOTAL | 531 | 4.13 | 2192 |
| | | (AVE.) | |
| DOUBLE COLUMN | | | |
| MOM. 'K | 1.10 | | |

ALUM $F_y = 12$ K/SQ. IN.
S = M/Fb WIND 1/3 INCR.
S = 0.75 * M (INCL 1.33 WIND)
S = 0.82 IN³

t = 0.216 IN. (MIN. THK.)
S = .0982*(d⁴-d1⁴)/d
d = 3.5 d1 = 3.068
USE MIN. 3" DIA. x 0.216 ALUM. PIPE #40

S = 1.72 IN³ > 0.82
O.K.

WT. OF SIGN = 220 LBS
AXIAL STRESS IS NEGLIGIBLE

COAT ALUM. SURFACES EMBEDDED IN
CONC. WITH ONE HEAVY COAT OF
ALKALI-RESISTANT BITUMINOUS
(BITUMASTIC PAINT -- SUCH AS
HENRY'S OR EQUIVALENT).

SEE PAGE 2 FOR FOOTING DETAILS



JOB NO. HUNT-146

HUNT DESIGN
25 N. MENTOR AVE.
PASADENA, CA 91106

PAGE: 2 of 2
PROJECT: UC RIVERSIDE
SUBJECT: RIVERSIDE, CA
SIGN STRUCTURAL CALCS.
BY: DVM DATE: 10-1-07
P.O.# DWGS. FROM PERRY SHIMOJI

SINGLE FOOTING - STRAIGHT
DESIGN OF EMBEDDED POLE FOOTINGS

| DESCRIPTION | >> | 64" WIDE | | |
|-------------------------|------|------------|-------|-------|
| | >> | X 12" THK. | | |
| ALLOW PASSIVE | psf | 200 | 200 | 200 |
| MAX PASSIVE | psf | 1,500 | 1,500 | 1,500 |
| LOAD DURATION FACTOR | | 1.33 | 1.33 | 1.33 |
| POINT LOAD | lbs | 531 | 0 | 0 |
| LOAD H | ft | 4.13 | 0.00 | 0.00 |
| DIST. L | #/ft | 0 | 0 | 0 |
| ST. H | ft | 0.00 | 0.00 | 0.00 |
| E | ft | 0.00 | 0.00 | 0.00 |
| DIAMETER | in | 64" | 0 | 0 |
| CIRCULAR ? | y/n | N | N | N |
| RESTRAINED ? | y/n | N | N | N |
| SUMMARY | | | | |
| Moments @ Surface: | | | | |
| Point Load | ft-# | 2,193 | 0 | 0 |
| Uniform Load | ft-# | 0 | 0 | 0 |
| ... Total Moment | ft-# | 2,193 | 0 | 0 |
| Total Lateral Load | # | 531 | 0 | 0 |
| --- NON-RESTRAINED --- | | | | |
| Min. Req'd Embedment | | | | |
| $A(1+(1+4.36h/A)^.5)/2$ | | 2'-5" | | |
| A=2.34P/(S 1 b) | ft | 2.34' | 0.00 | 0.00 |
| Press @ 1/3 Embed.: | | | | |
| Actual | psf | 207 | 0 | 0 |
| Allowable | psf | 207 | 0 | 0 |
| --- RESTRAINED --- | | | | |
| Min. Req'd Embedment | | | | |
| $(4.25 P h/S3 b)^.5$ | ft | 0.00 | 0.00 | 0.00 |
| Pressure @ Bottom | | | | |
| Actual | psf | 0 | 0 | 0 |
| Allowable | psf | 0 | 0 | 0 |
| Surface Restraint | | | | |
| Force | lbs | 0 | 0 | 0 |

PER CBC TABLE 18-1-A
POLE 2x ALLOWABLE







Product Name: Sliivr (sli-ver) Type: Floorstanding



DESCRIPTION:

Proof that true beauty is more than skin deep. The standard 19" LCD display is highlighted by the architecture of the surrounding steel enclosure. The internal peripherals are designed for quick cold swapping and easy, unobtrusive maintenance. Designed to be the perfect informational kiosk, the Sliivr is the choice for free standing directory, way-finding and in-store cataloging applications.

DIMENSIONS:

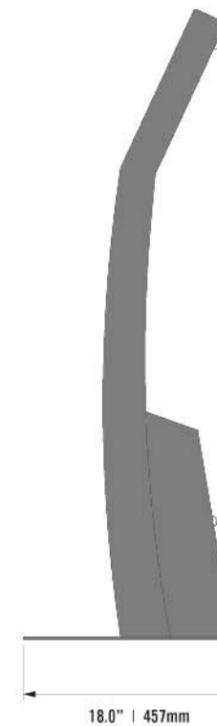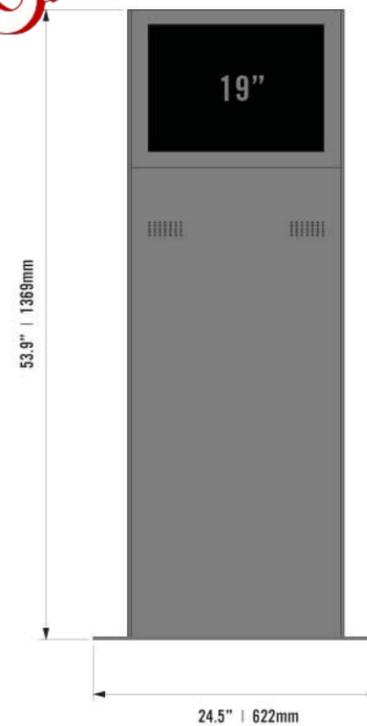

INCLUDED W/ BASE MODEL:

- 19" LCD Display
- Powder Coated Steel Side Accent Blades
- Large Access Doors with Tubular Locks/Keys
- Tempered Glass Display Overlay (Certain UI Options Only)
- Cooling Fan
- Industrial Power Strip
- 2.5 Watt Speakers / 8 Ohm Impedance

SPECIFICATIONS:

- Precision cut, 16 gauge steel enclosure
- Full Interior MIG Welds / Custom Brackets & Mounts
- Cardinal Industrial Powder Coat Finish
- Kiosk Temp Range:
- Operating: 42-90° F
- Stored: 33-100° F


OPTIONS:


- Installation / Warranty
- Custom & Off The Shelf Software
- PC & PC Upgrades
- Branding & Graphics
- Accent Blade Color Options
- Multimedia
- Custom Finishes
- User Input Devices
- Card Readers / Scanners
- Custom Component Integration
- Shipping & Delivery

WEIGHT:


Kiosk Base Weight: ** 120lbs
 ** Shipping weight and cost will vary depending on options selected

Not Used

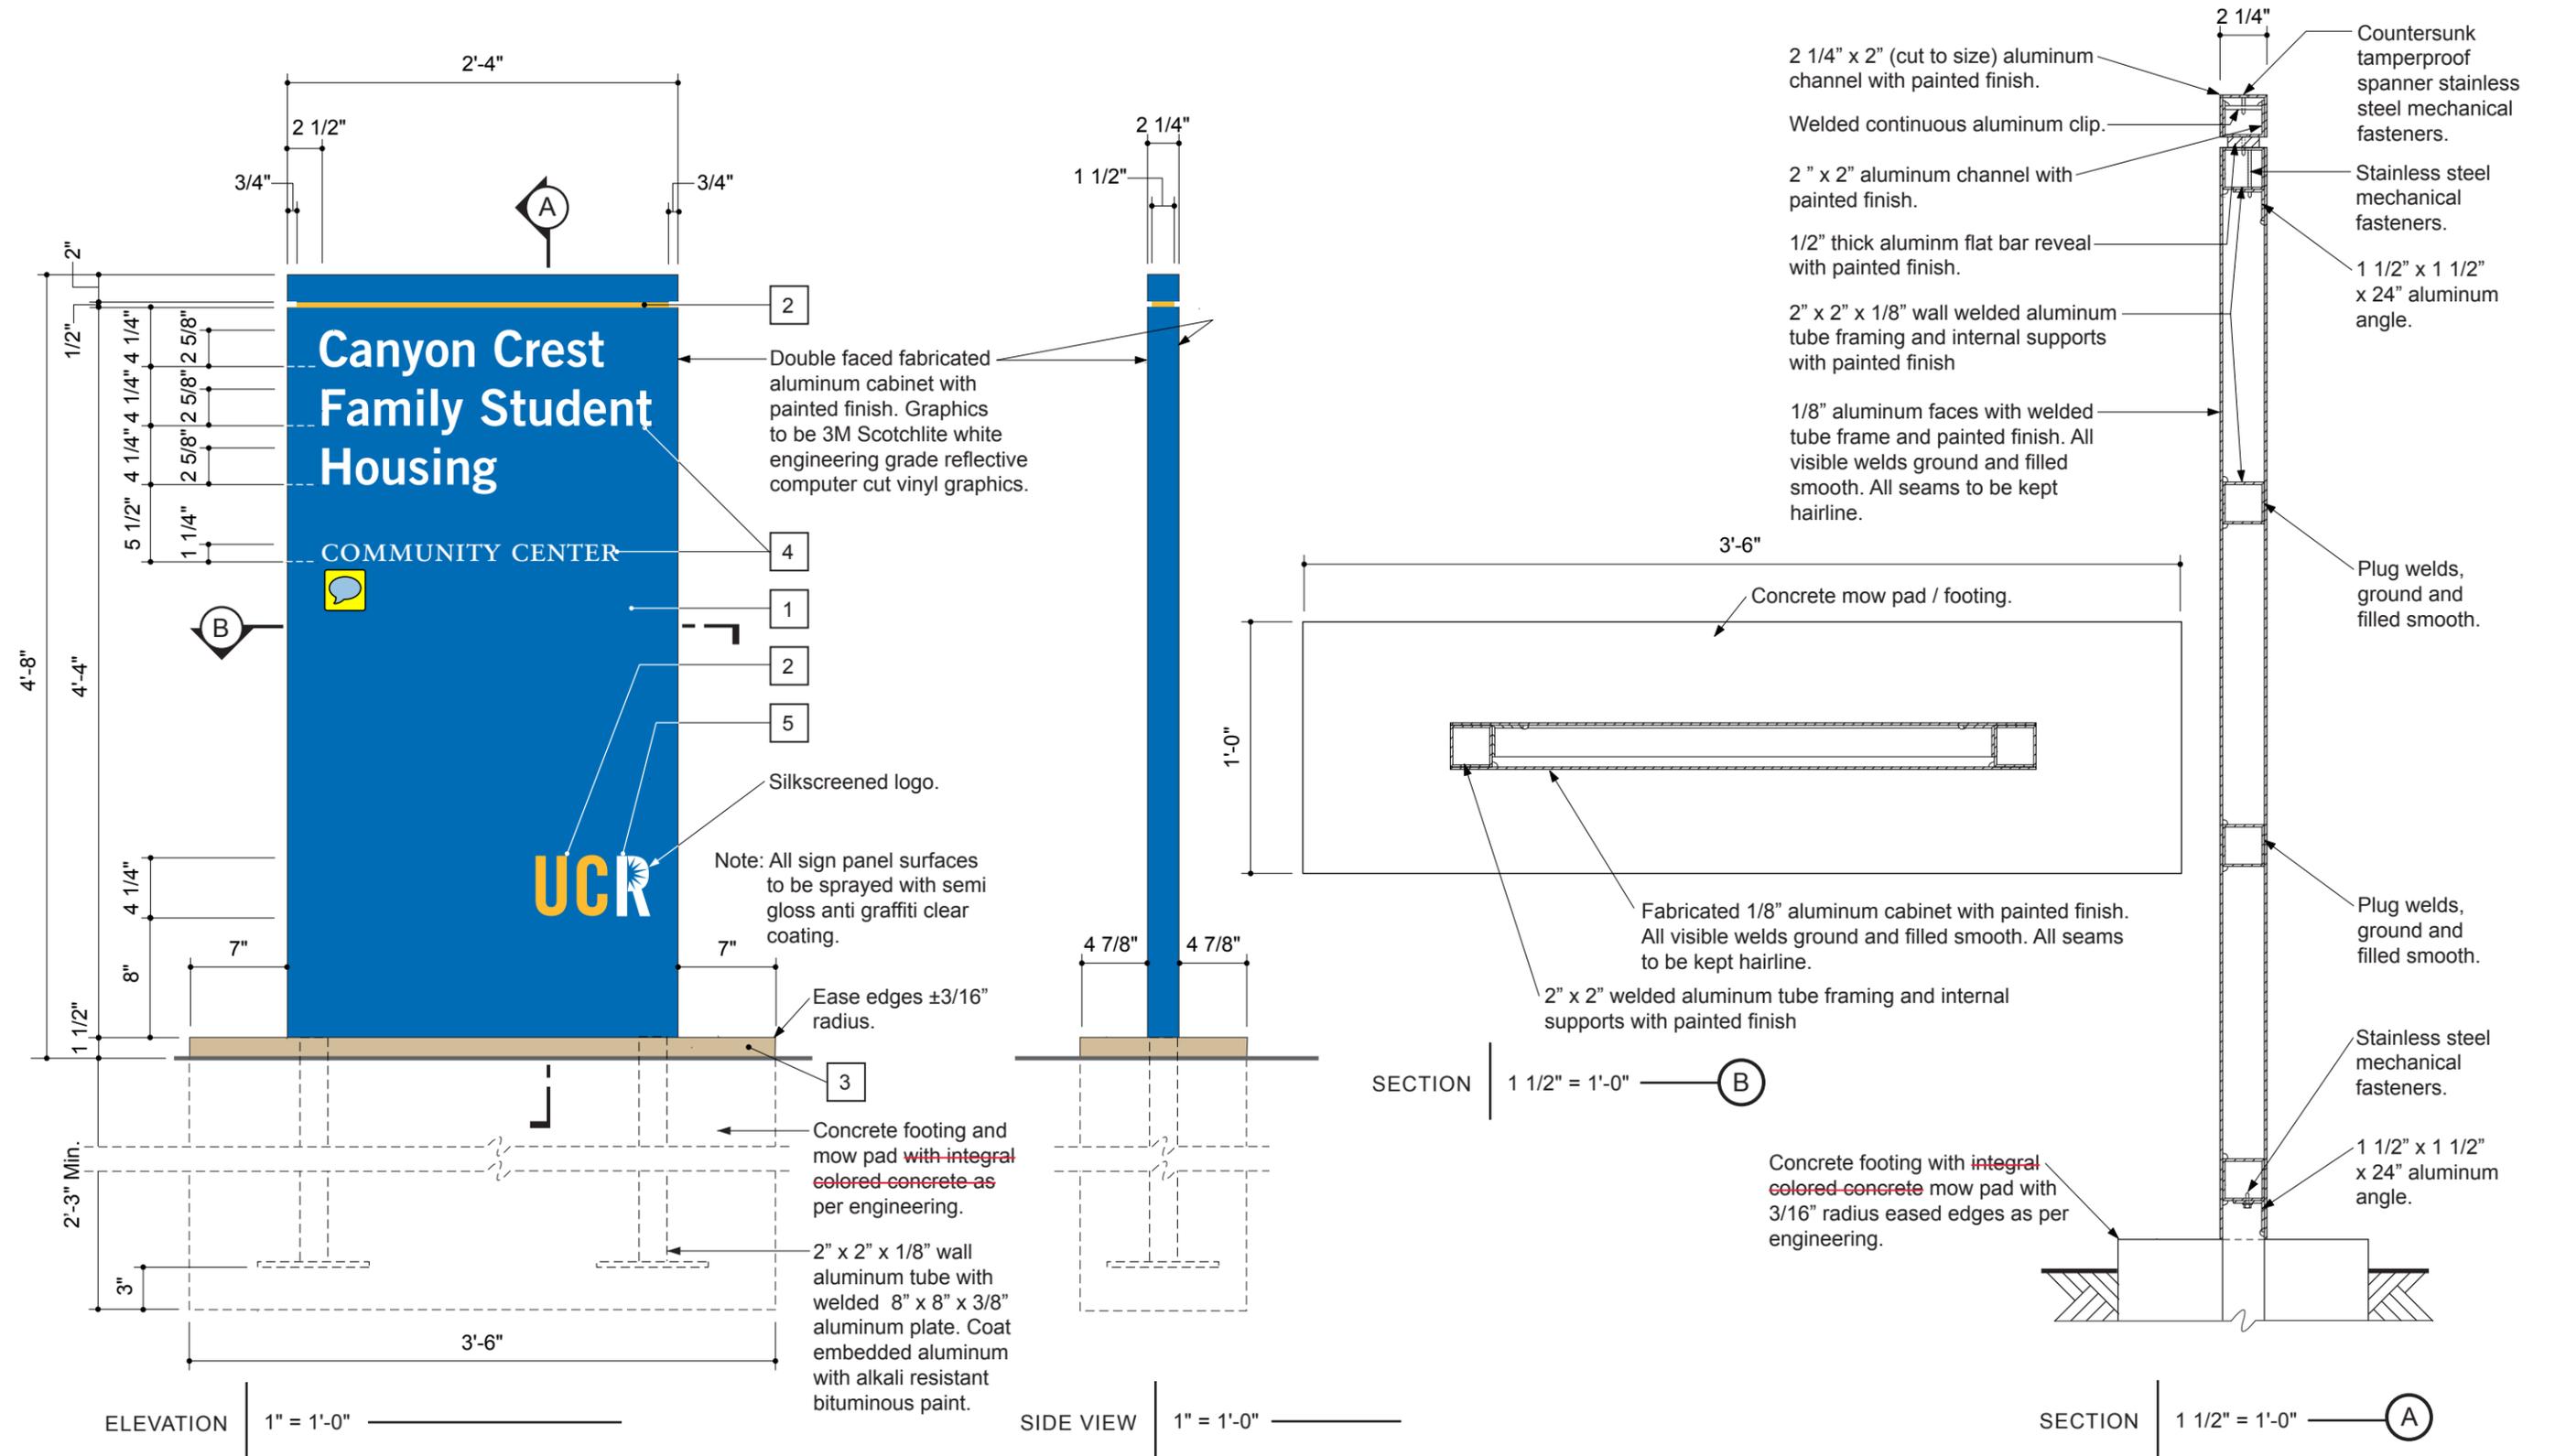


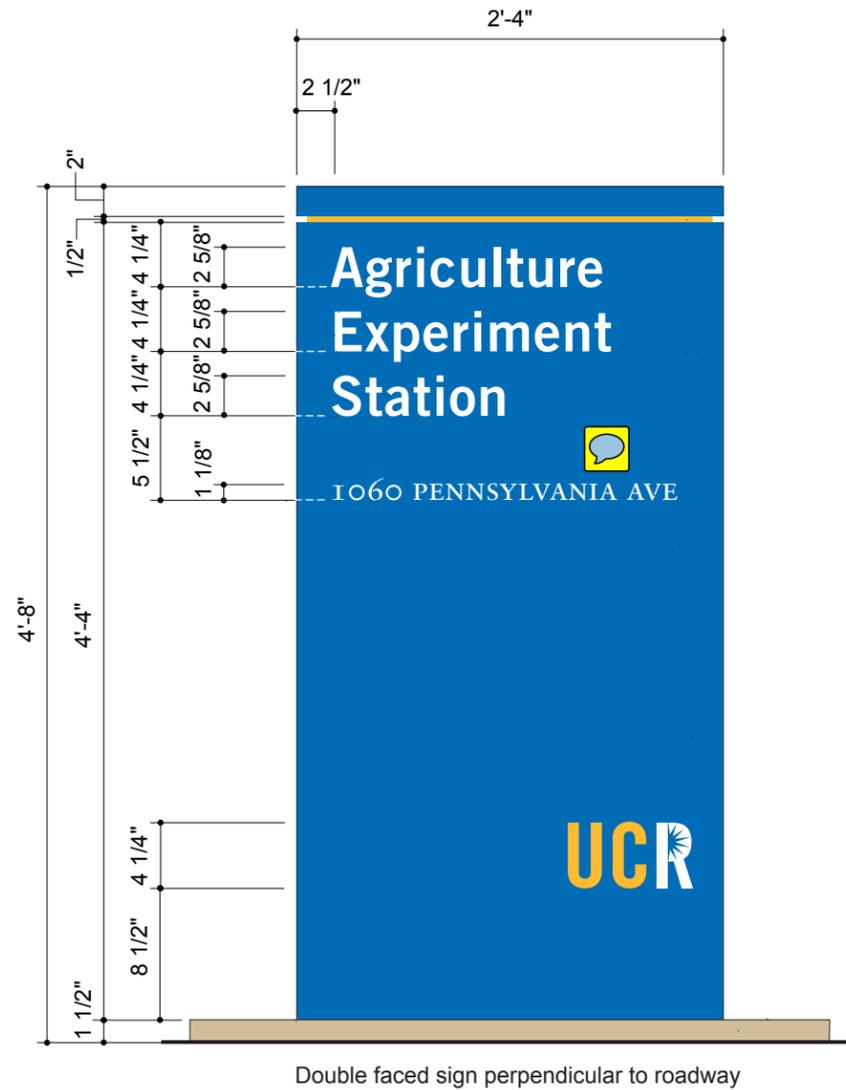

Double faced sign perpendicular to roadway

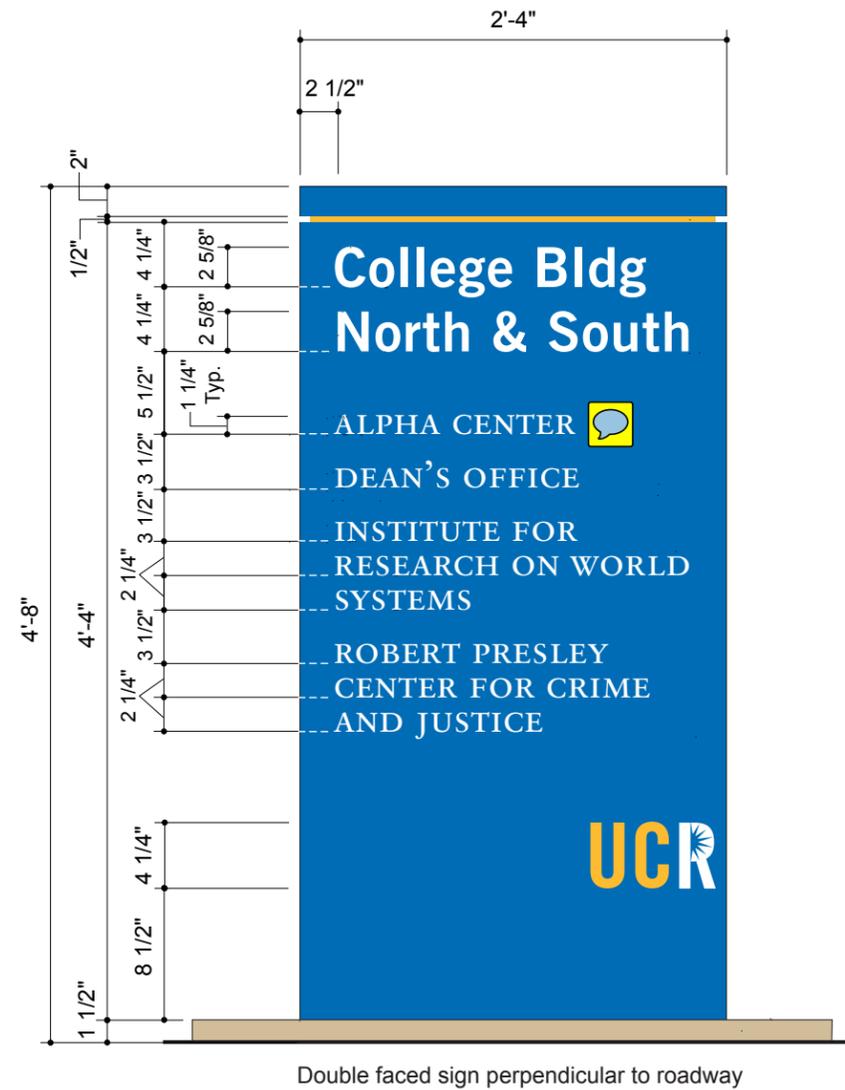

Double faced sign perpendicular to roadway


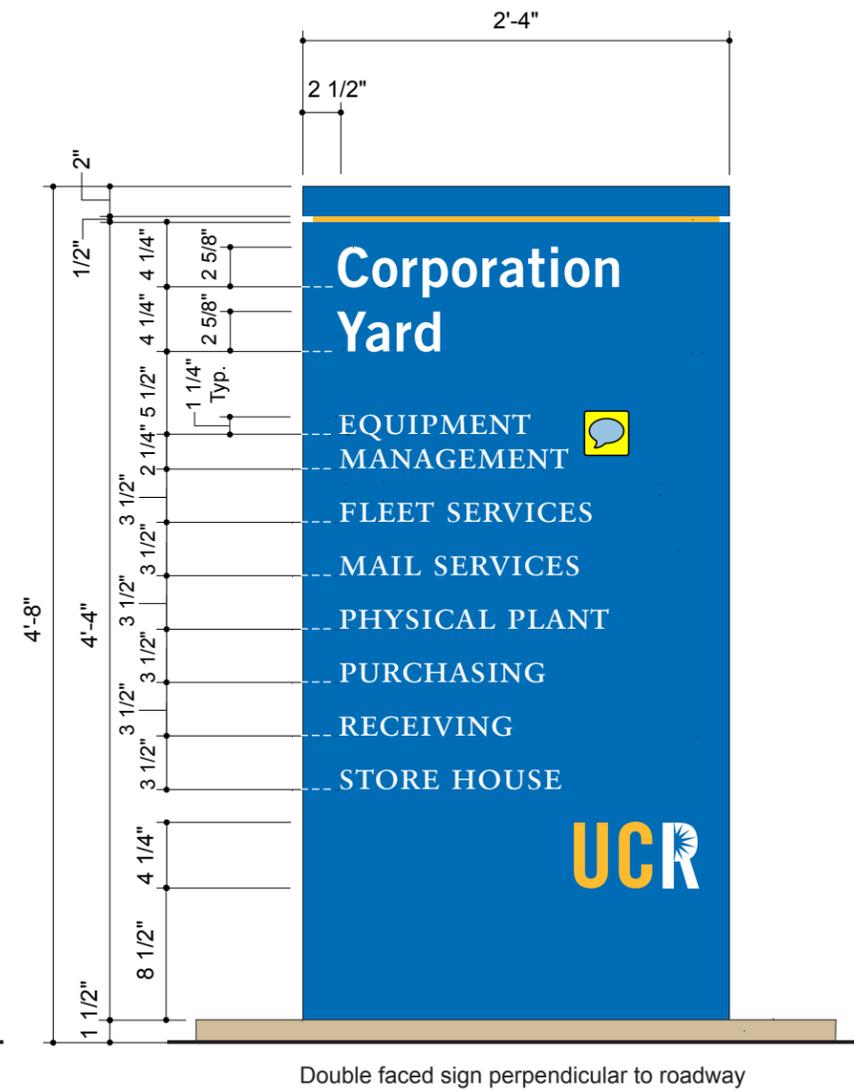


Double faced sign perpendicular to roadway

LAYOUT CONDITIONS

1" = 1'-0"

See Sheet 1.27, Sign Type W50, for Specifications

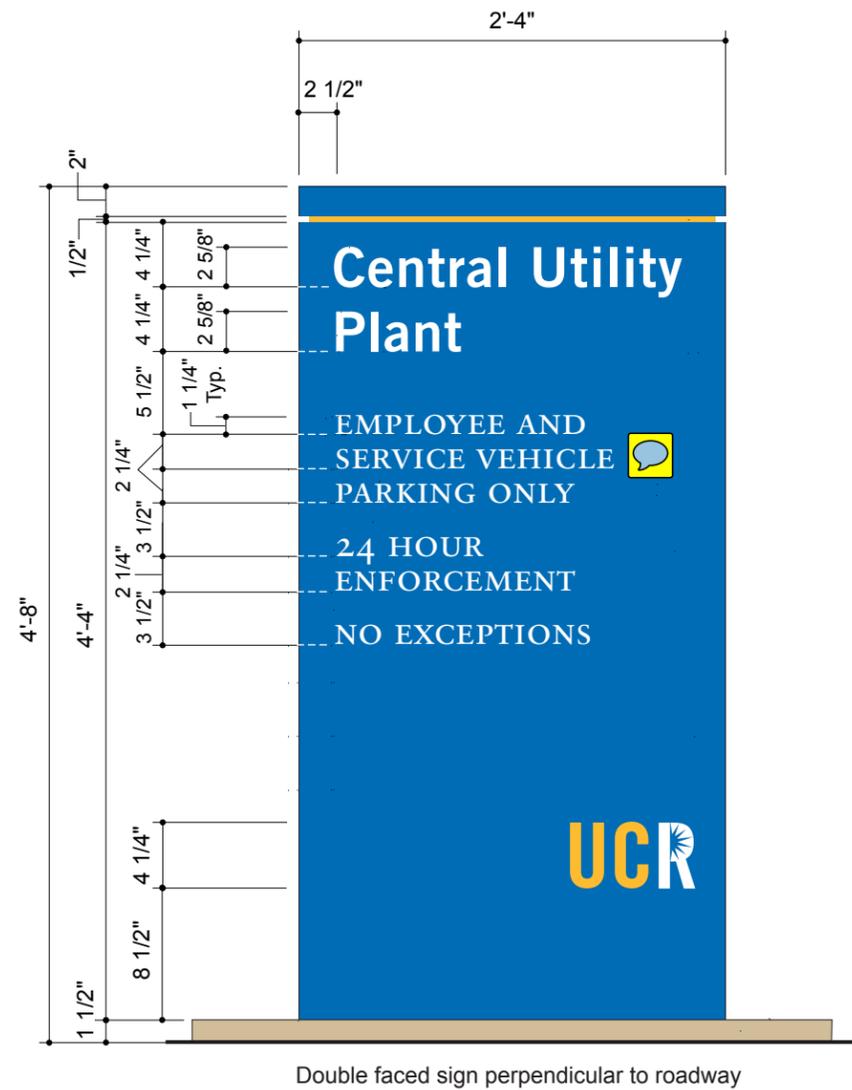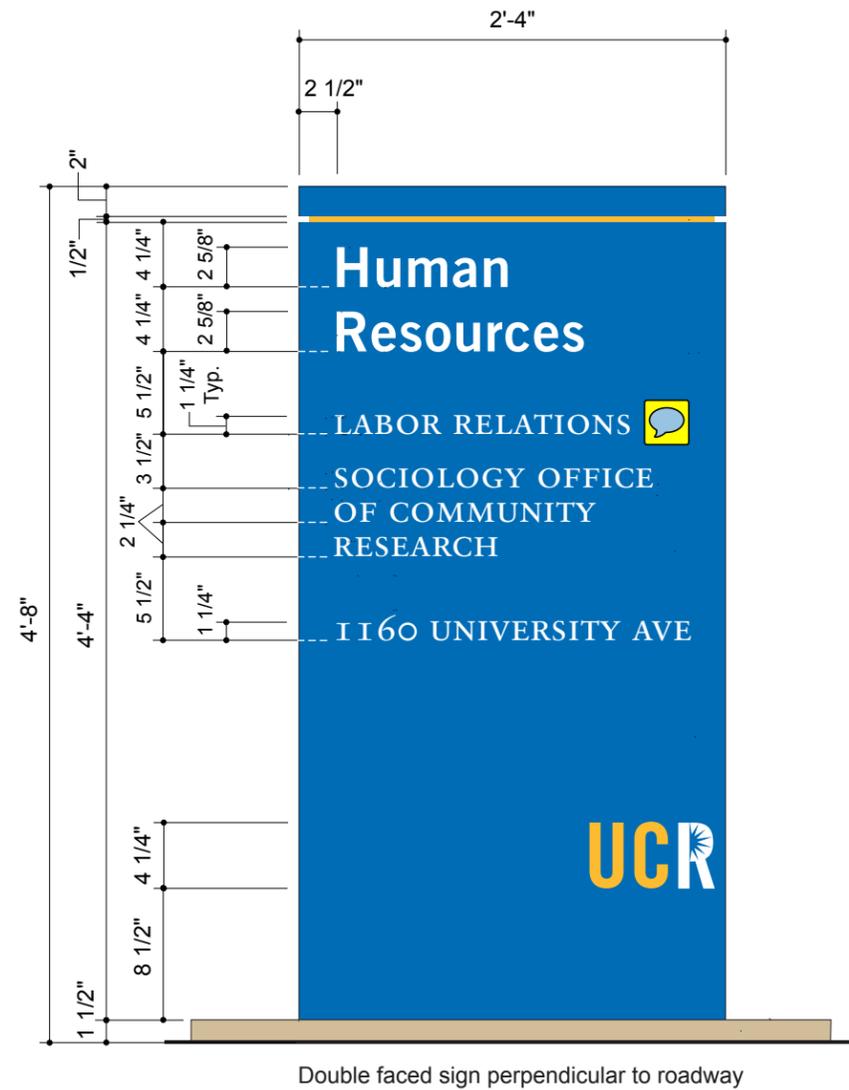

LAYOUT CONDITIONS

1" = 1'-0"

See Sheet 1.27, Sign Type W50, for Specifications


HUNT DESIGN
25 N. MENTOR AVE.
PASADENA, CA 91106

PAGE: 1 of 2
PROJECT: UC RIVERSIDE
SUBJECT: RIVERSIDE, CA
SIGN STRUCTURAL CALCS.
BY: DVM DATE: 10-1-07
P.O.# DWGS. FROM PERRY SHIMOJI

FOR COLUMN & FOOTING DESIGN

AREA -- SIGN TYPES W50.0 & W70.0
A = 5.29' * 2.96' = 15.7 S.F. (TYPE W70.0)

NOTE: SIGN TYPE W50.0 IS SLIGHTLY
SMALLER IN SIZE THAN TYPE W70.0 -
COLUMN & FOOTING DESIGN FOR BOTH
IS O.K. BY INSPECTION

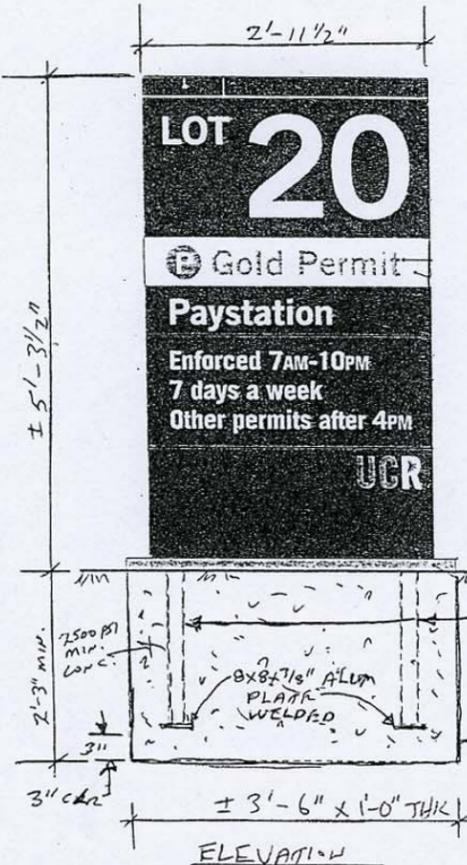

JOB NO. HUNT-144

| | | |
|----------|----------------------------------|----------------|
| WIND | CBC-'01 | 80 MPH, EXP. C |
| CBC-1613 | $p=Cq \cdot Ce \cdot Qs \cdot I$ | $I=1.0$ |
| $Qs =$ | 16.4 | $Cq = 1.4$ |
| | 25.94 LBS/S.F. @ 20' | $Ce = 1.13$ |
| | 24.34 LBS/S.F. < 15' | $Ce = 1.06$ |
| S.F. | LBS | FT. |
| AREA | !PRESS! | X-DIST |
| 15.7 | 382 | 2.65 |
| 0.0 | 0 | 0.00 |
| 0.0 | 0 | 0.00 |
| 0.0 | 0 | 0.00 |

TOTAL 382 2.65 1013
(AVE.)

DOUBLE COLUMN
MOM.'K 0.51

ALUM $F_b = 12$ K/SQ. IN.
 $S = M/F_b$ WIND 1/3 INCR.
 $S = 0.75 \cdot M$ (INCL 1.33 WIND)
 $S = 0.38$ IN³

$S = (bd^3 - b1 \cdot d1^3) / (6 \cdot d)$
 $d = 2$ $d1 = 1.75$
 $b = 2$ $b1 = 1.75$

USING 2"x2"x 1/8" ALUM. TUBE
 $S = 0.55$ IN³ > 0.38
O.K.

COAT ALUM. SURFACES EMBEDDED IN
CONC. WITH ONE HEAVY COAT OF
ALKALI-RESISTANT BITUMINOUS
(BITUMASTIC) PAINT TO 2" MIN.
ABOVE GRADE

WT. OF SIGN = 175 LBS +/-
AXIAL STRESS IS NEGLIGIBLE

SEE PAGE 2 FOR FOOTING DETAILS



HUNT DESIGN
25 N. MENTOR AVE.
PASADENA, CA 91106

PAGE: 2 of 2
PROJECT: UC RIVERSIDE
SUBJECT: RIVERSIDE, CA
SIGN STRUCTURAL CALCS.
BY: DVM DATE: 10-1-07
P.O.# DWGS. FROM PERRY SHIMOJI


SINGLE FOOTING - STRAIGHT




DESIGN OF EMBEDDED POLE FOOTINGS

| | | | | |
|-------------------------------|------|------------|-------|-------|
| DESCRIPTION | >> | 42" WIDE | | |
| | >> | + 12" THK. | | |
| ALLOW PASSIVE | psf | 200 | 200 | 200 |
| MAX PASSIVE | psf | 1,500 | 1,500 | 1,500 |
| LOAD DURATION FACTOR | | 1.33 | 1.33 | 1.33 |
| POINT LOAD | lbs | 382 | 0 | 0 |
| LOAD HT. | ft | 2.65 | 0.00 | 0.00 |
| DIST. LOAD | #/ft | 0 | 0 | 0 |
| START HT. | ft | 0.00 | 0.00 | 0.00 |
| END HT. | ft | 0.00 | 0.00 | 0.00 |
| WIDTH/DIAMETER | in | 42 | 0 | 0 |
| CIRCULAR ? | y/n | N | N | N |
| RESTRAINED ? | y/n | N | N | N |
| SUMMARY | | | | |
| Moments @ Surface: | | | | |
| Point Load | ft-# | 1,012 | 0 | 0 |
| Uniform Load | ft-# | 0 | 0 | 0 |
| ... Total Moment | ft-# | 1,012 | 0 | 0 |
| Total Lateral Load | # | 382 | 0 | 0 |
| NON-RESTRAINED | | | | |
| Min. Req'd Embedment | | 2'-3" | | |
| $A(1+(1+4.36h/A)^{.5})/2$ | ft | 2.18' | 0.00 | 0.00 |
| $A=2.34P/(S \cdot 1 \cdot b)$ | | DEPTH | | |
| Press @ 1/3 Embed.: | | | | |
| Actual | psf | 194 | 0 | 0 |
| Allowable | psf | 193 | 0 | 0 |
| RESTRAINED | | | | |
| Min. Req'd Embedment | | 0.00 | 0.00 | 0.00 |
| $(4.25 P h / S3 b)^{.5}$ | ft | | | |
| Pressure @ Bottom | | | | |
| Actual | psf | 0 | 0 | 0 |
| Allowable | psf | 0 | 0 | 0 |
| Surface Restraint | | | | |
| Force | lbs | 0 | 0 | 0 |

PER CBC TABLE 18-1-A
POLE 2X ALLOWABLE



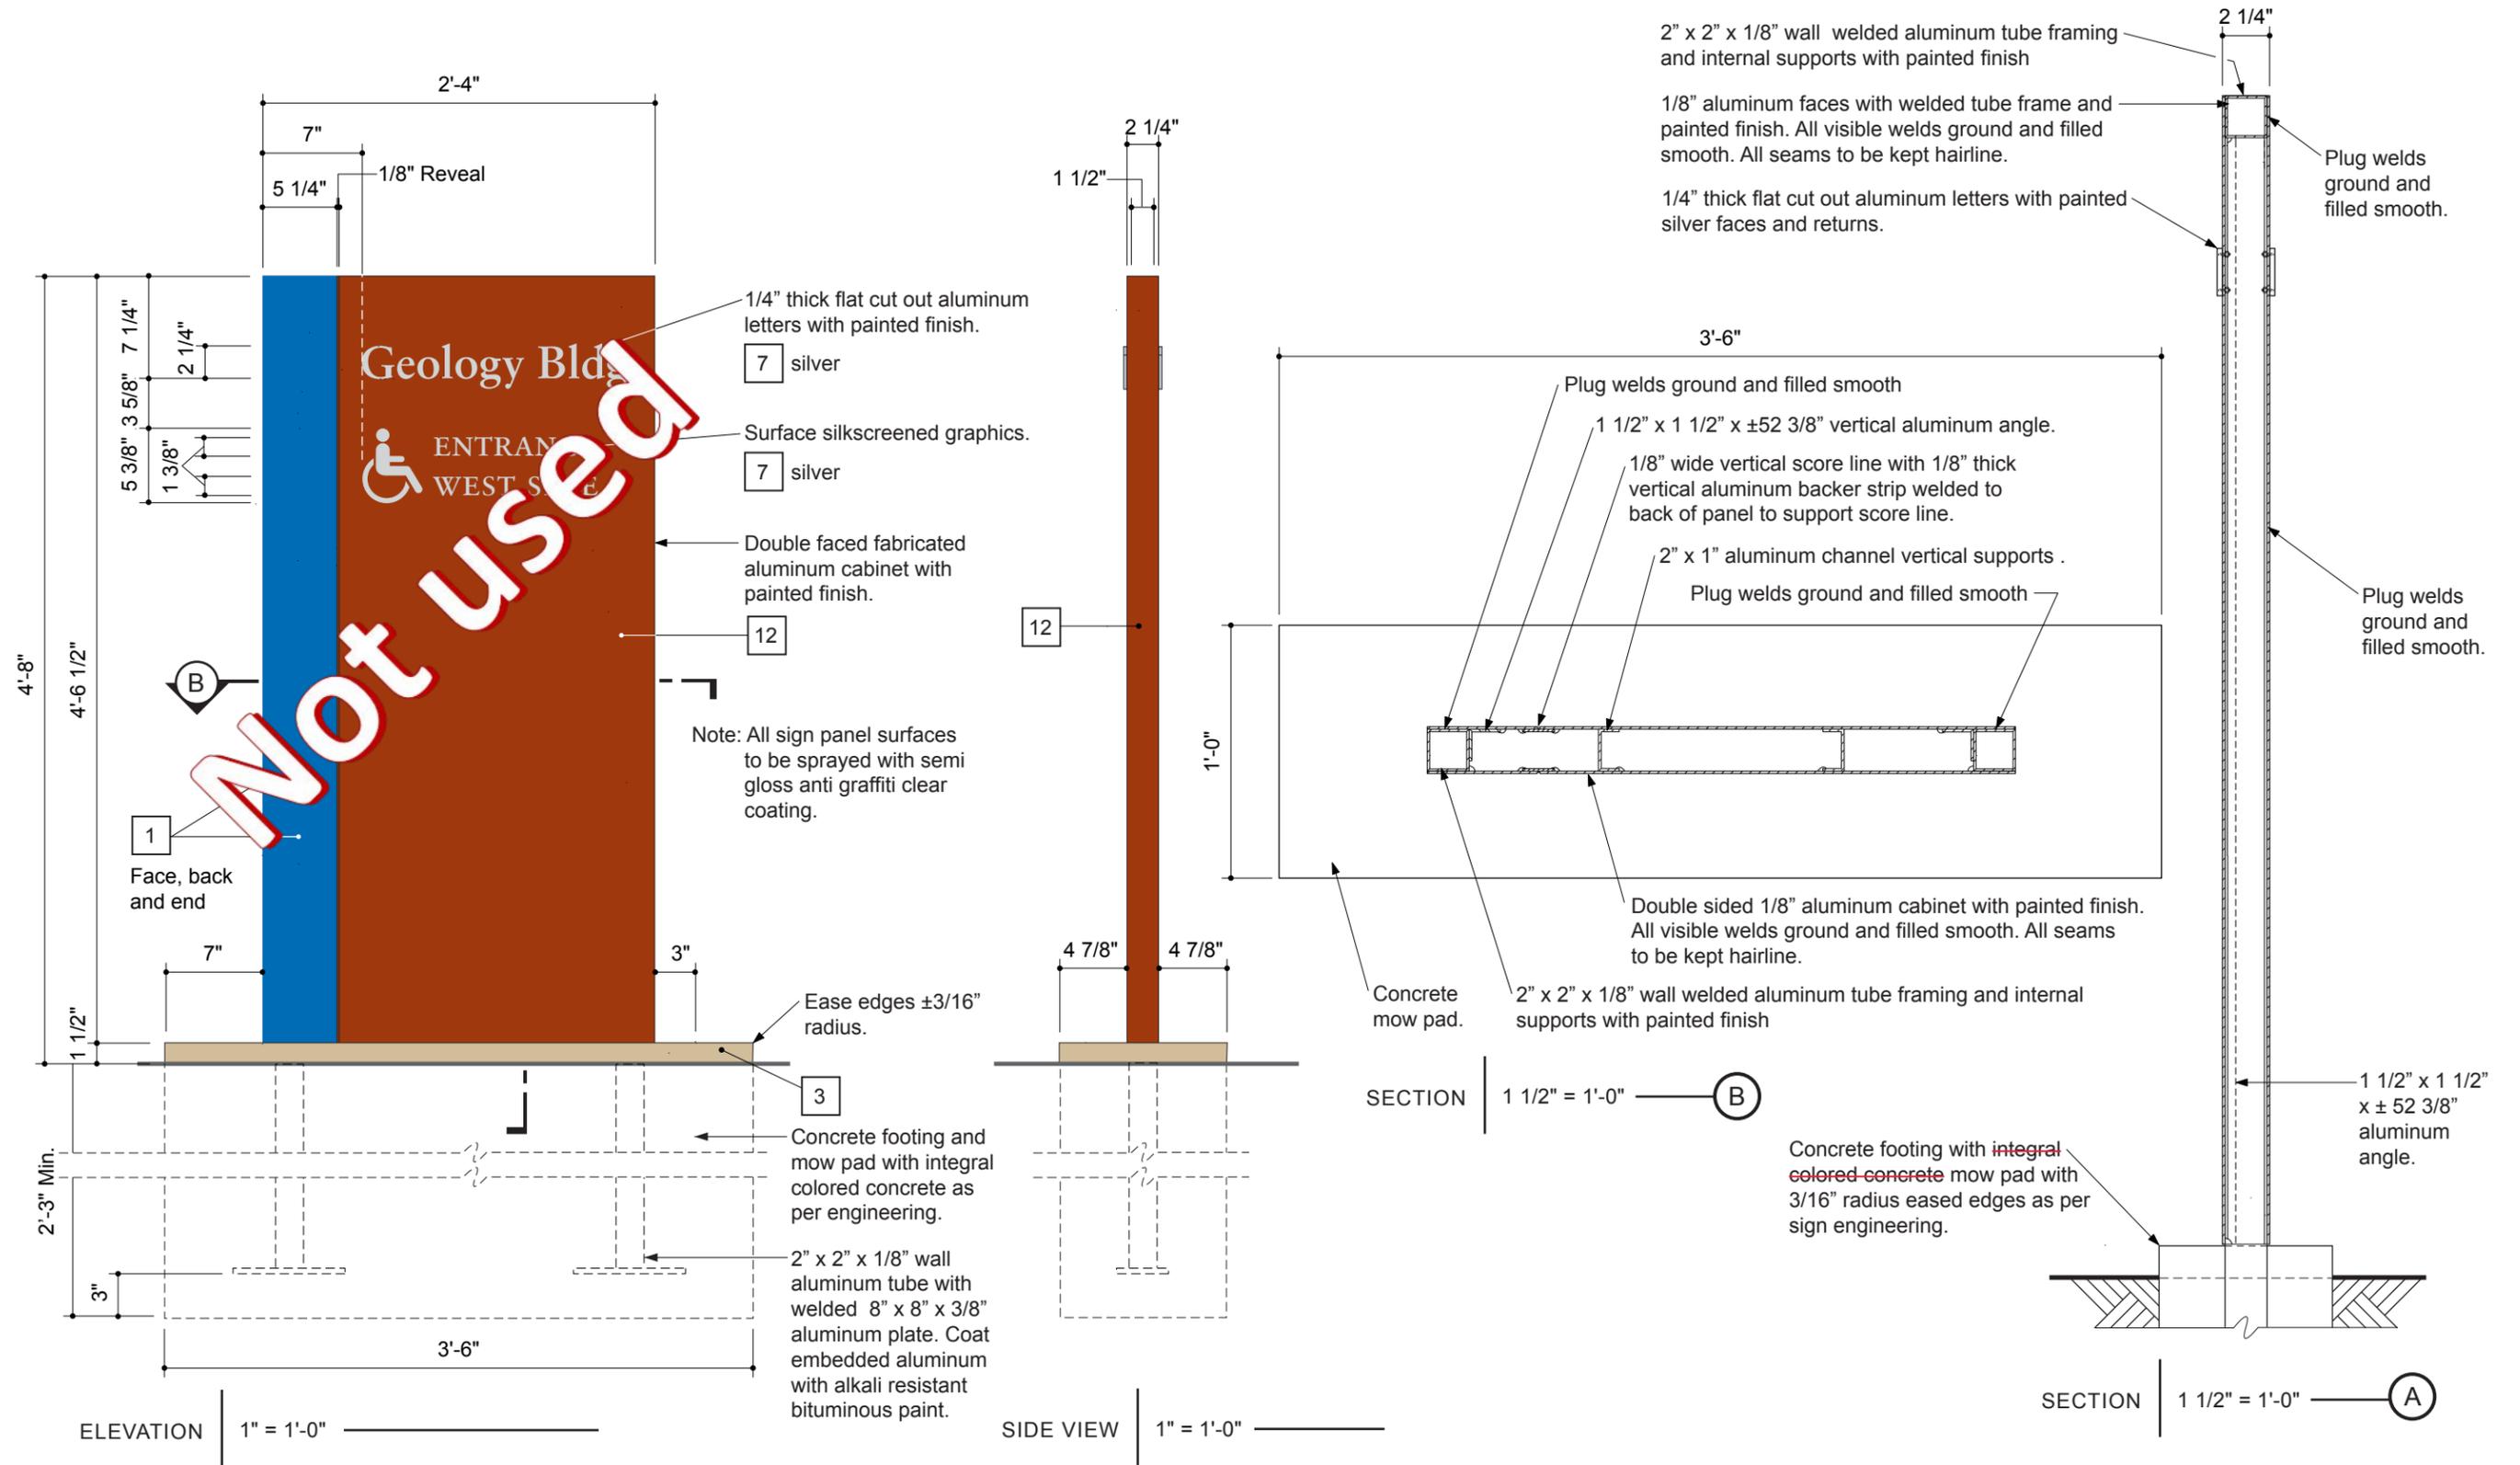

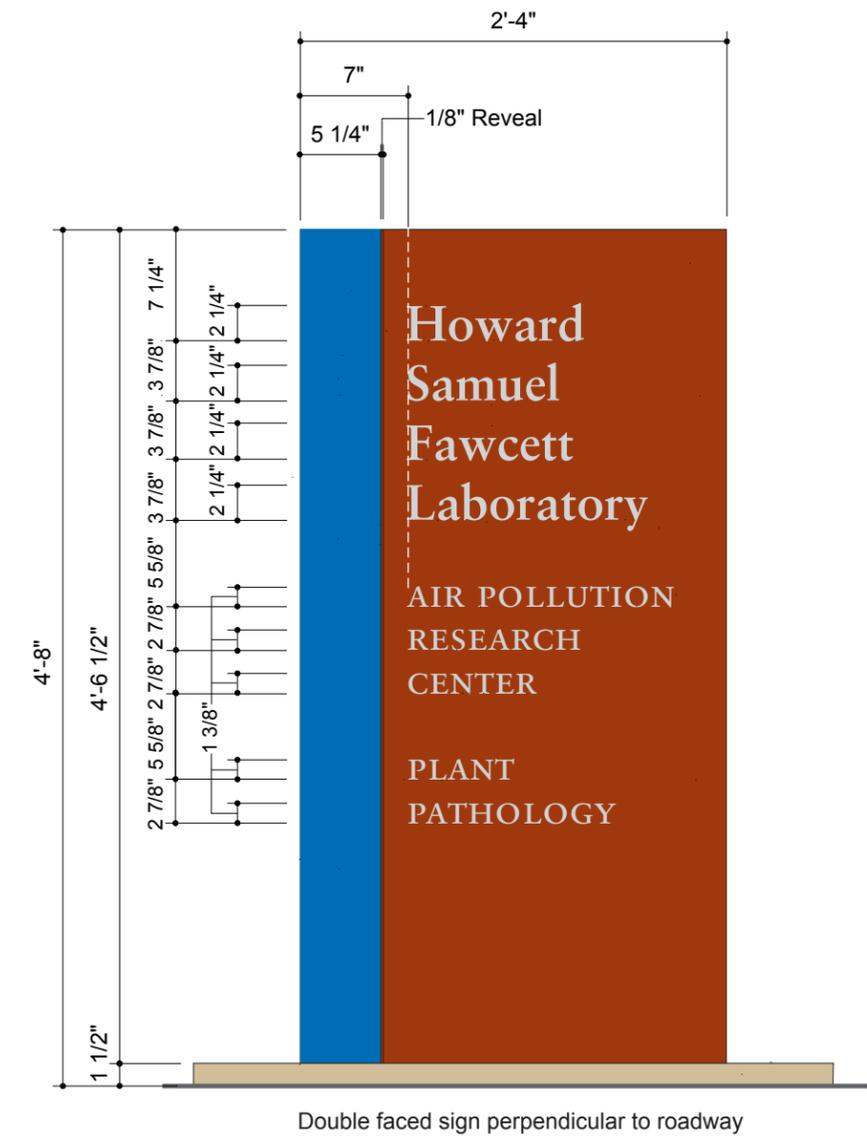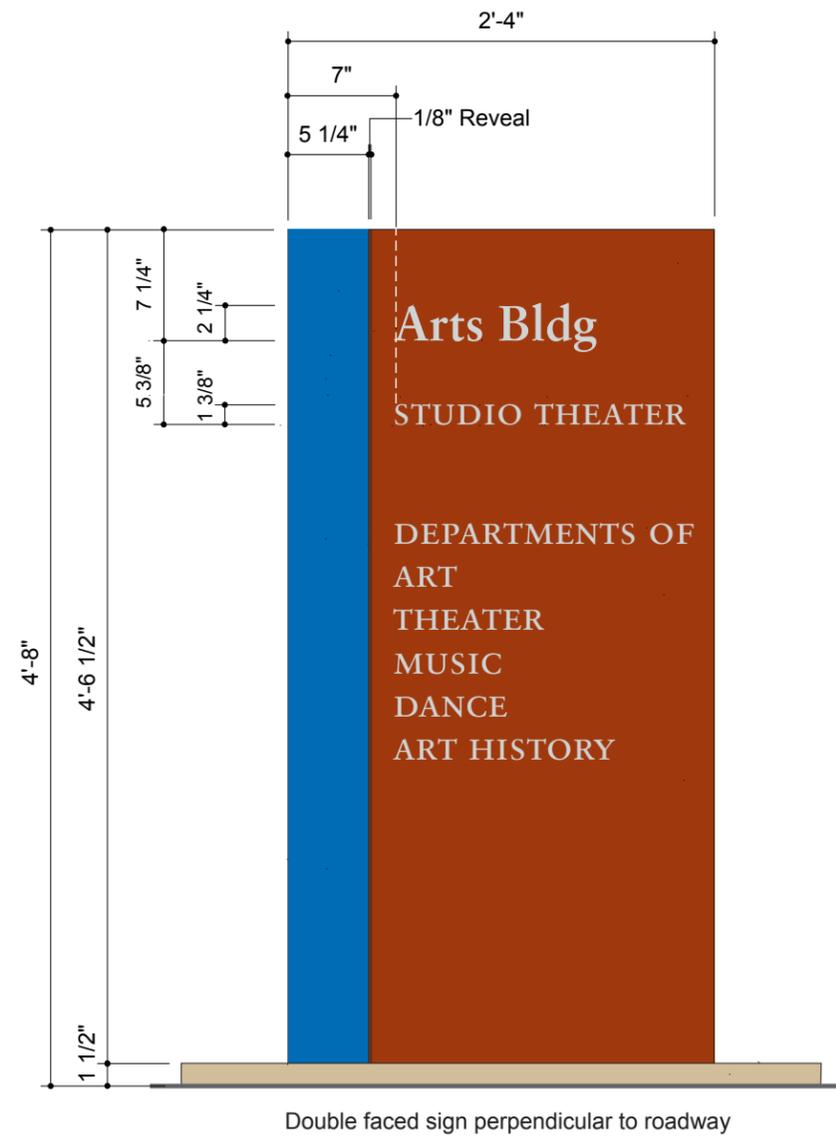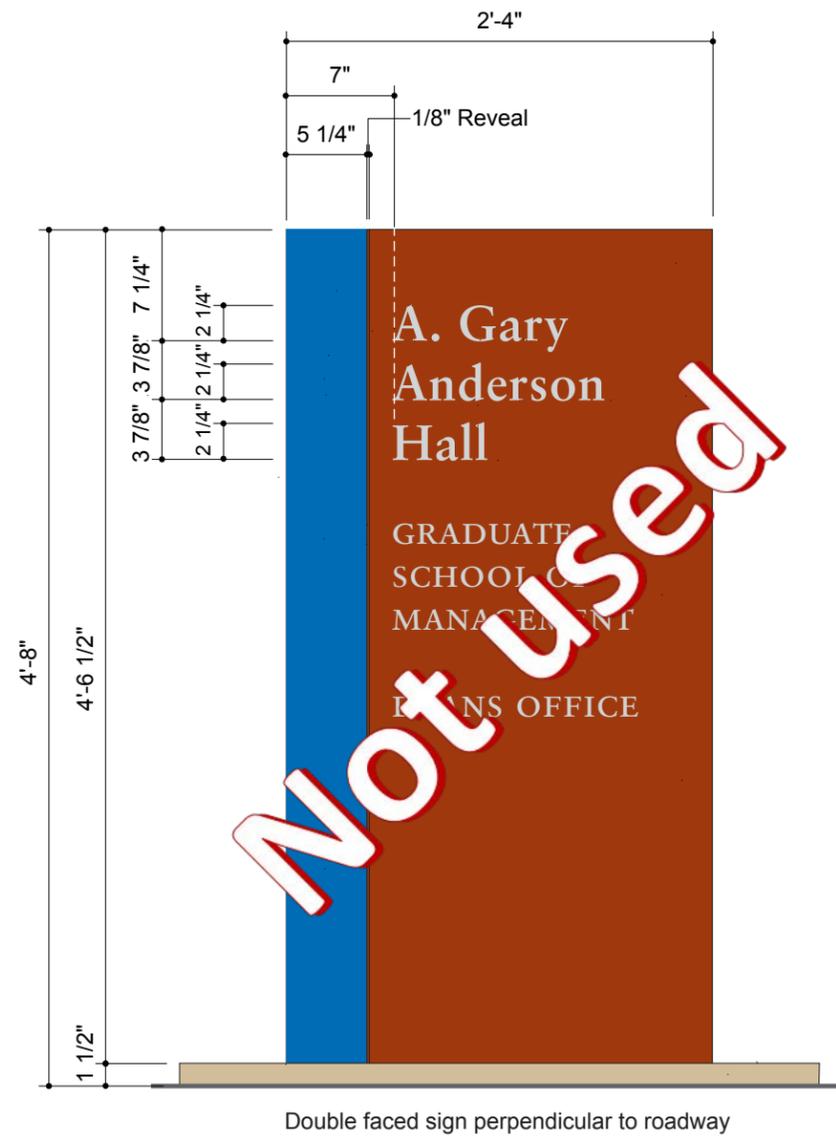

LAYOUT CONDITIONS | 1" = 1'-0" ————— See Sheet 1.31, Sign Type W51, for Specifications


HUNT DESIGN
25 N. MENTOR AVE.
PASADENA, CA 91106

PAGE: 1 of 2
PROJECT: UC RIVERSIDE
SUBJECT: RIVERSIDE, CA
SIGN STRUCTURAL CALCS.
BY: DVM DATE: 10-1-07
P.O.# DWGS. FROM PERRY SHIMOJI

FOR COLUMN & FOOTING DESIGN

AREA -- SIGN TYPES W50.0 & W70.0
A = 5.29' * 2.96' = 15.7 S.F. (TYPE W70.0)

NOTE: SIGN TYPE W50.0 IS SLIGHTLY
SMALLER IN SIZE THAN TYPE W70.0 -
COLUMN & FOOTING DESIGN FOR BOTH
IS O.K. BY INSPECTION

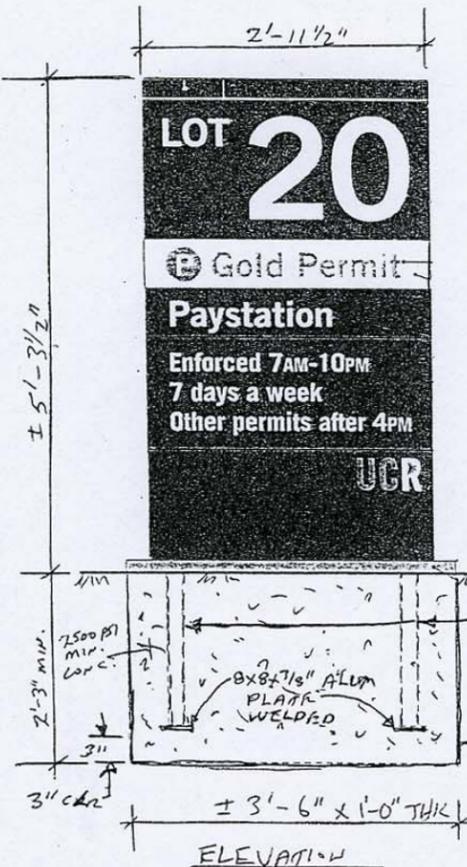

| | | |
|----------|----------------------------------|----------------|
| WIND | CBC-'01 | 80 MPH, EXP. C |
| CBC-1613 | $p=Cq \cdot Ce \cdot Qs \cdot I$ | $I=1.0$ |
| $Qs =$ | 16.4 | $Cq = 1.4$ |
| | 25.94 LBS/S.F. @ 20' | $Ce = 1.13$ |
| | 24.34 LBS/S.F. < 15' | $Ce = 1.06$ |
| S.F. | LBS | FT. |
| AREA | !PRESS! | X-DIST |
| 15.7 | 382 | 2.65 |
| 0.0 | 0 | 0.00 |
| 0.0 | 0 | 0.00 |
| 0.0 | 0 | 0.00 |

| | | | |
|---------------|------|--------|------|
| TOTAL | 382 | 2.65 | 1013 |
| | | (AVE.) | |
| DOUBLE COLUMN | | | |
| MOM.'K | 0.51 | | |

ALUM $F_b = 12$ K/SQ. IN.
 $S = M/F_b$ WIND 1/3 INCR.
 $S = 0.75 \cdot M$ (INCL 1.33 WIND)
 $S = 0.38$ IN³

$S = (bd^3 - b1 \cdot d1^3) / (6 \cdot d)$
 $d = 2$ $d1 = 1.75$
 $b = 2$ $b1 = 1.75$

USING 2"x2"x 1/8" ALUM. TUBE
 $S = 0.55$ IN³ > 0.38
O.K.

COAT ALUM. SURFACES EMBEDDED IN
CONC. WITH ONE HEAVY COAT OF
ALKALI-RESISTANT BITUMINOUS
(BITUMASTIC) PAINT TO 2" MIN.
ABOVE GRADE

WT. OF SIGN = 175 LBS +/-
AXIAL STRESS IS NEGLIGIBLE

SEE PAGE 2 FOR FOOTING DETAILS



JOB NO. HUNT-144

HUNT DESIGN
25 N. MENTOR AVE.
PASADENA, CA 91106

PAGE: 2 of 2
PROJECT: UC RIVERSIDE
SUBJECT: RIVERSIDE, CA
SIGN STRUCTURAL CALCS.
BY: DVM DATE: 10-1-07
P.O.# DWGS. FROM PERRY SHIMOJI


SINGLE FOOTING - STRAIGHT

DESIGN OF EMBEDDED POLE FOOTINGS


| | | | | |
|-------------------------------|------|------------|-------|-------|
| DESCRIPTION | >> | 42" WIDE | | |
| | >> | + 12" THK. | | |
| ALLOW PASSIVE | psf | 200 | 200 | 200 |
| MAX PASSIVE | psf | 1,500 | 1,500 | 1,500 |
| LOAD DURATION FACTOR | | 1.33 | 1.33 | 1.33 |
| POINT LOAD | lbs | 382 | 0 | 0 |
| LOAD HT. | ft | 2.65 | 0.00 | 0.00 |
| DIST. LOAD | #/ft | 0 | 0 | 0 |
| START HT. | ft | 0.00 | 0.00 | 0.00 |
| END HT. | ft | 0.00 | 0.00 | 0.00 |
| WIDTH/DIAMETER | in | 42 | 0 | 0 |
| CIRCULAR ? | y/n | N | N | N |
| RESTRAINED ? | y/n | N | N | N |
| SUMMARY | | | | |
| Moments @ Surface: | | | | |
| Point Load | ft-# | 1,012 | 0 | 0 |
| Uniform Load | ft-# | 0 | 0 | 0 |
| ... Total Moment | ft-# | 1,012 | 0 | 0 |
| Total Lateral Load | # | 382 | 0 | 0 |
| NON-RESTRAINED | | | | |
| Min. Req'd Embedment | | 2'-3" | | |
| $A(1+(1+4.36h/A)^{.5})/2$ | ft | 2.18' | 0.00 | 0.00 |
| $A=2.34P/(S \cdot 1 \cdot b)$ | | DEPTH | | |
| Press @ 1/3 Embed.: | | | | |
| Actual | psf | 194 | 0 | 0 |
| Allowable | psf | 193 | 0 | 0 |
| RESTRAINED | | | | |
| Min. Req'd Embedment | | 0.00 | 0.00 | 0.00 |
| $(4.25 P h / S3 b)^{.5}$ | ft | | | |
| Pressure @ Bottom | | | | |
| Actual | psf | 0 | 0 | 0 |
| Allowable | psf | 0 | 0 | 0 |
| Surface Restraint | | | | |
| Force | lbs | 0 | 0 | 0 |

PER CBC TABLE 18-1-A
POLE 2X ALLOWABLE




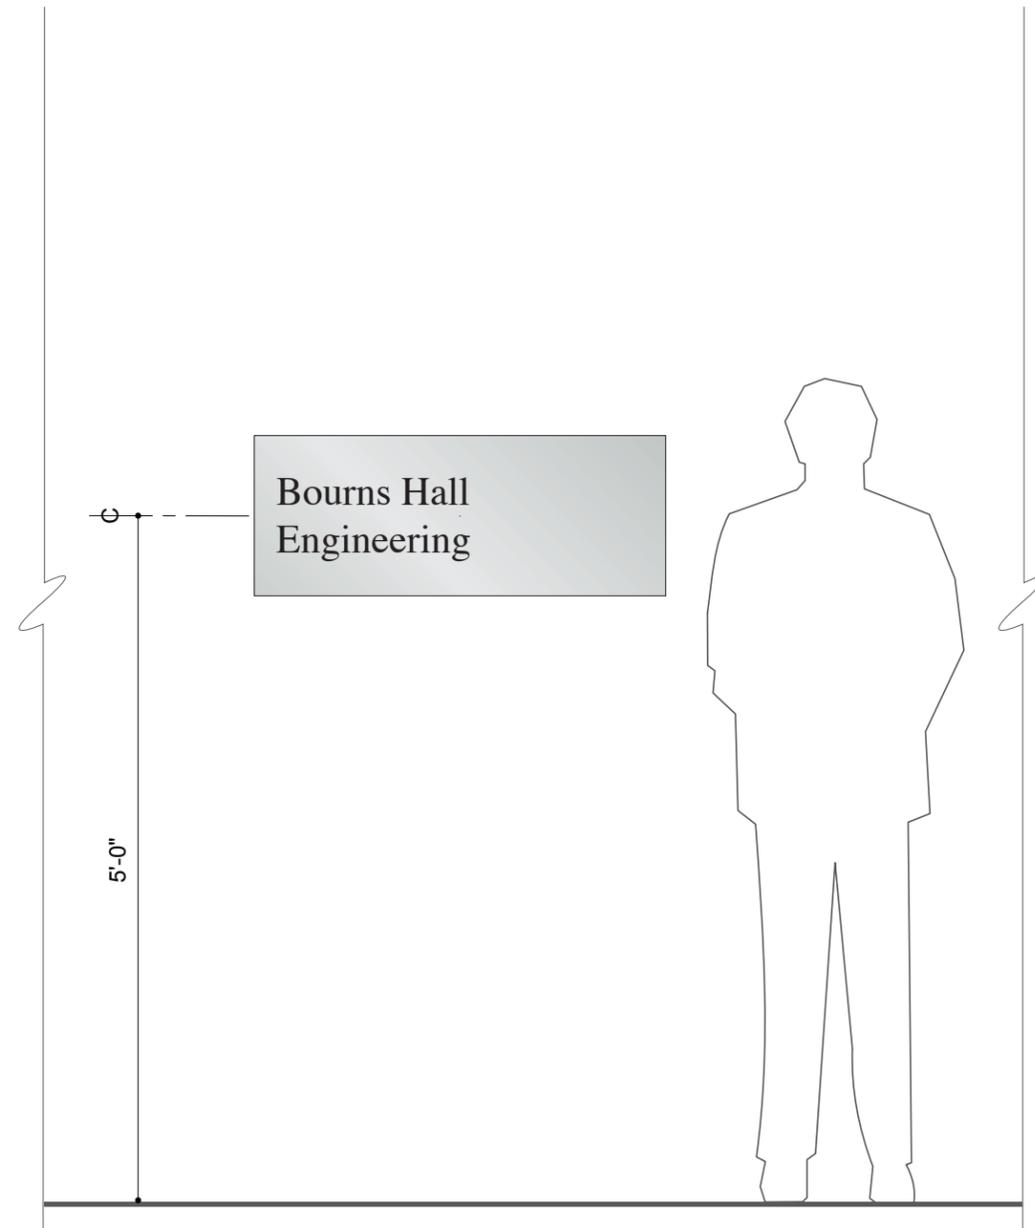


ELEVATION | 3/4" = 1'-0"

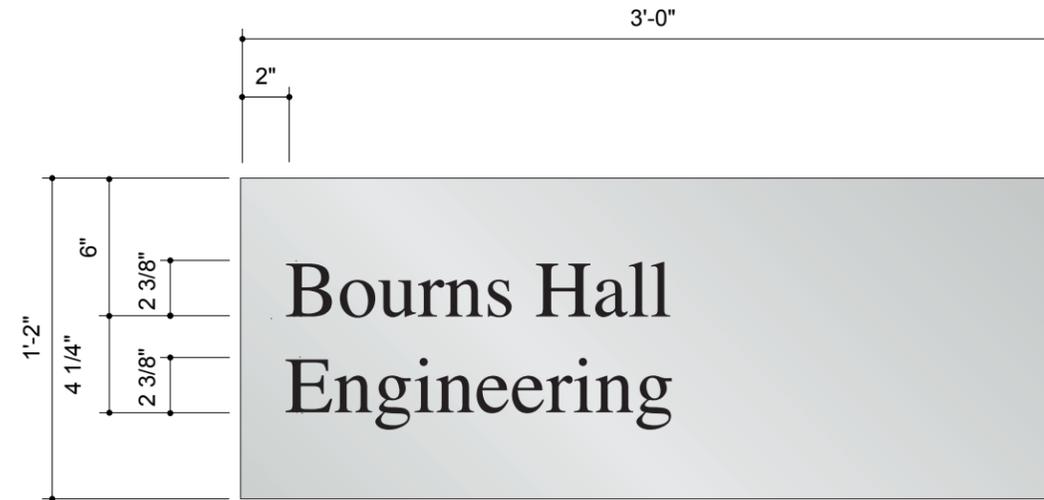



TWO LINE LAYOUT | 1 1/2" = 1'-0"

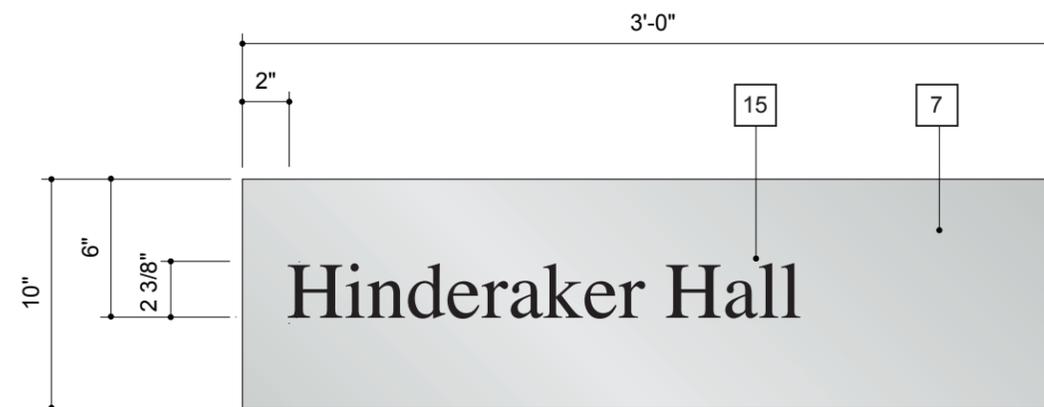

ONE LINE LAYOUT | 1 1/2" = 1'-0"

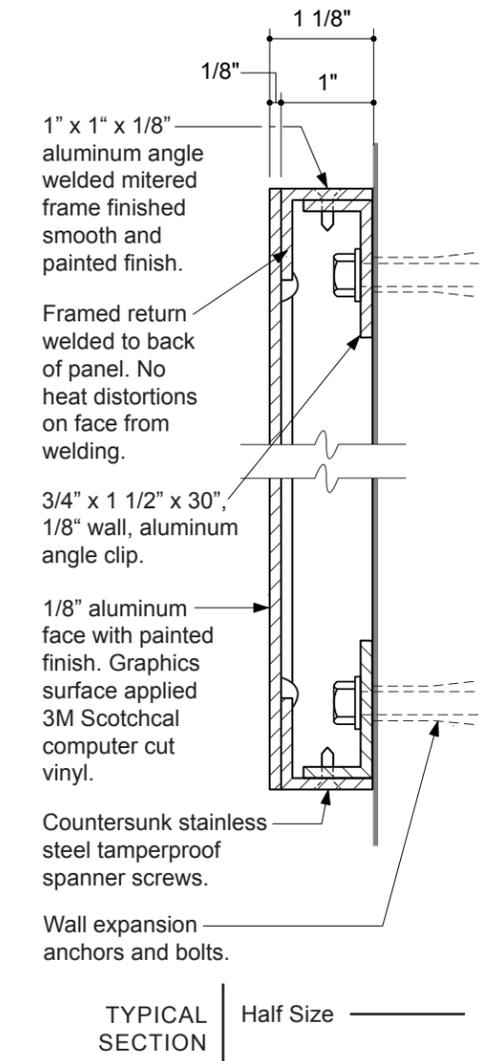

1 1/8" deep fabricated aluminum panel with painted finish. Graphics surface applied 3M Scotchcal computer cut vinyl.

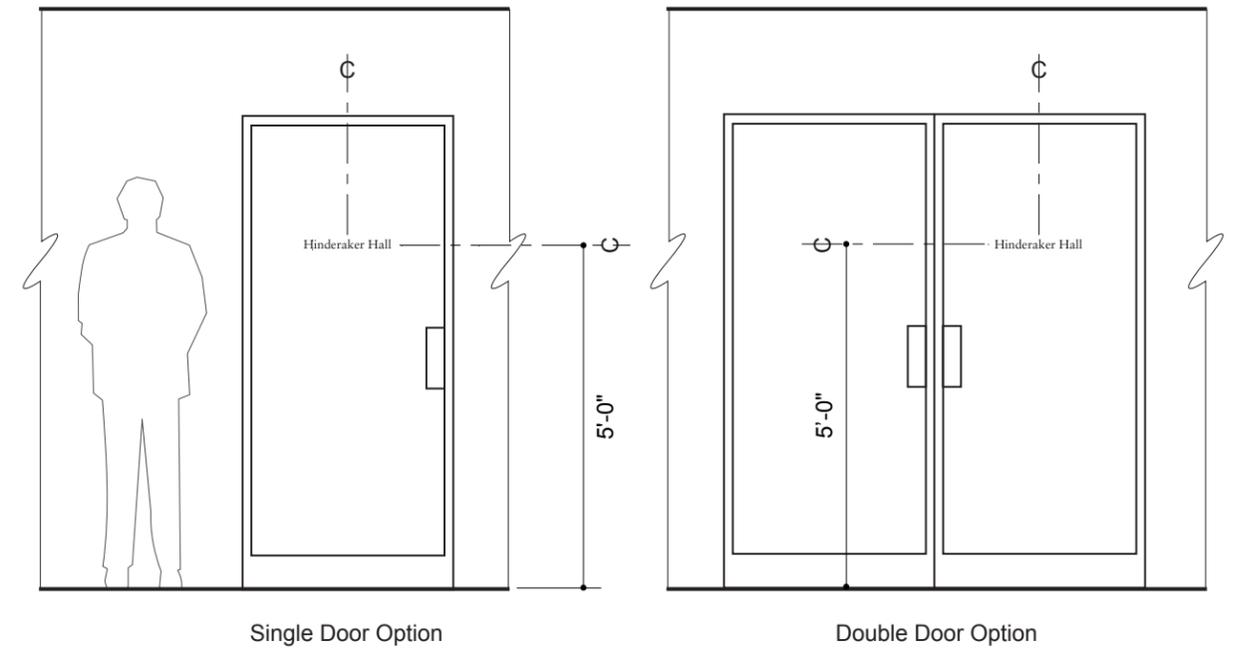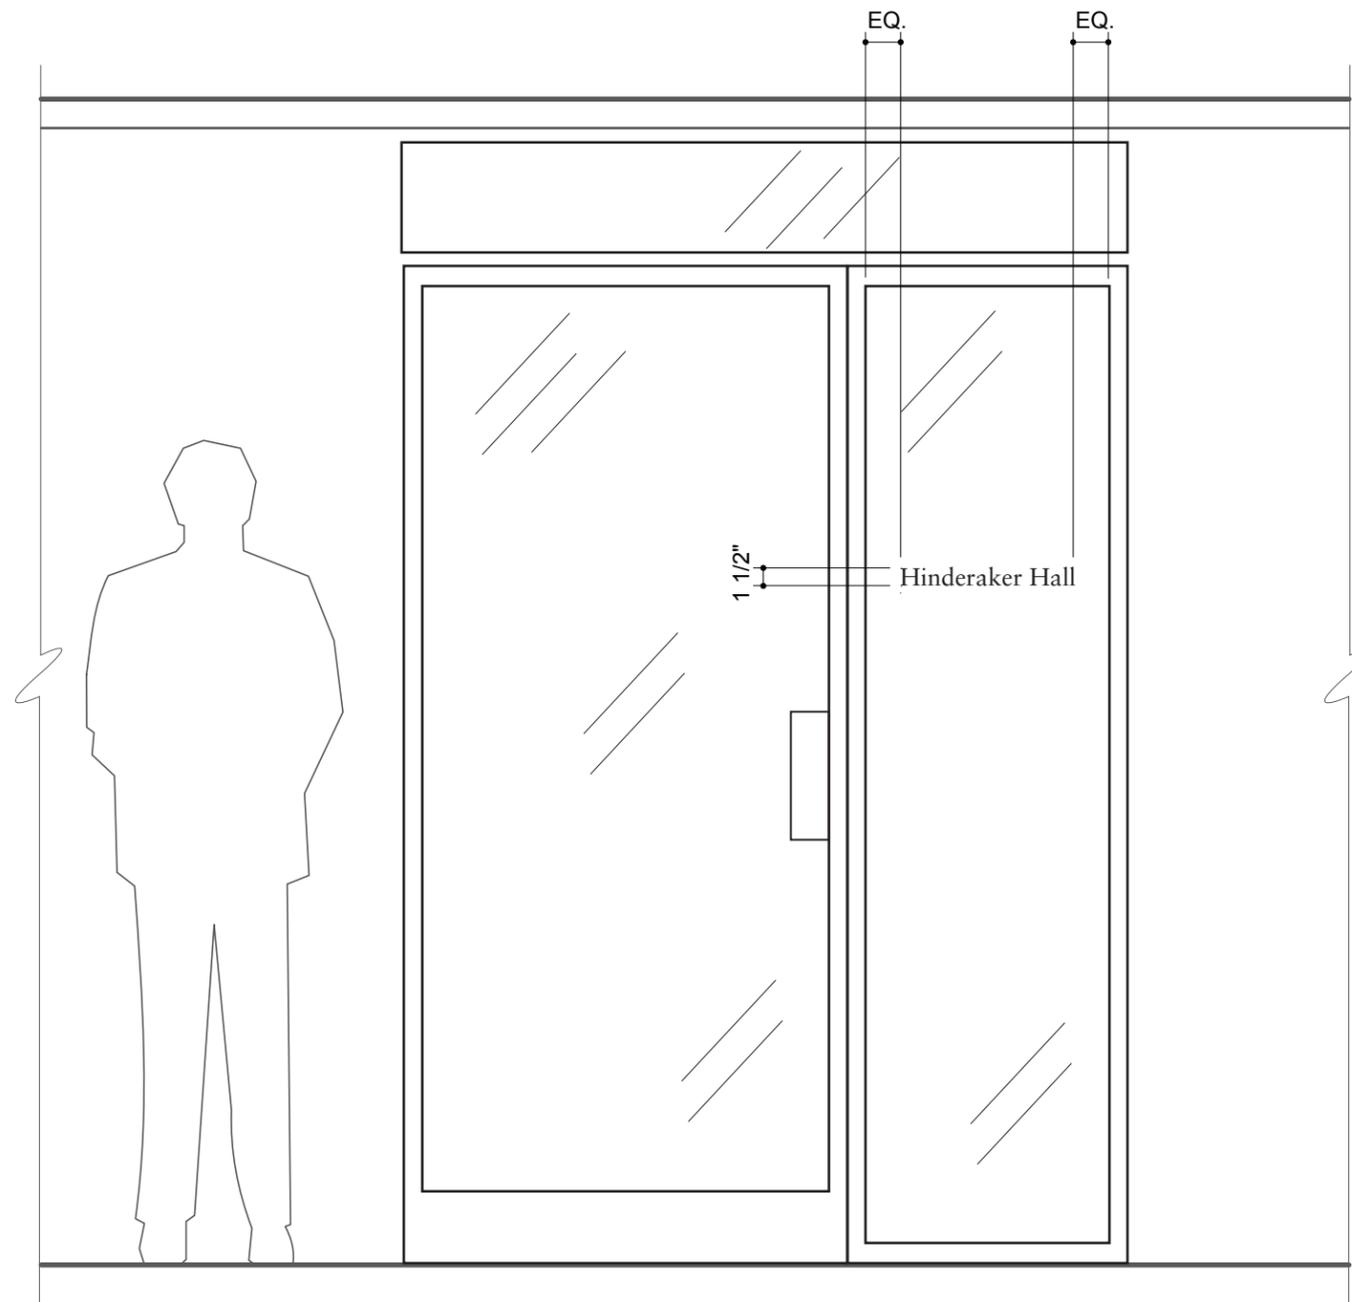



UNIVERSITY REPRESENTATIVE'S SUBMITTAL STAMP

- No Exceptions Taken
- Reviewed & No Exceptions Taken
- Revise & Resubmit
- Rejected
- Reviewed Without Action, Submittal Not Required by Contract Documents
- Make corrections noted

The undersigned's review of this submittal is limited to how Design Builder proposes to conform to the information given and the design concept expressed in the Contract Documents. The undersigned's review does not relieve Design Builder of Design Builder's responsibility under the Contract Documents, including without limitation, Article 3 of the General Conditions.


By University's Representative:
 Fernando Nuñez Jr.
 Project Manager

DATE: 8/6/18

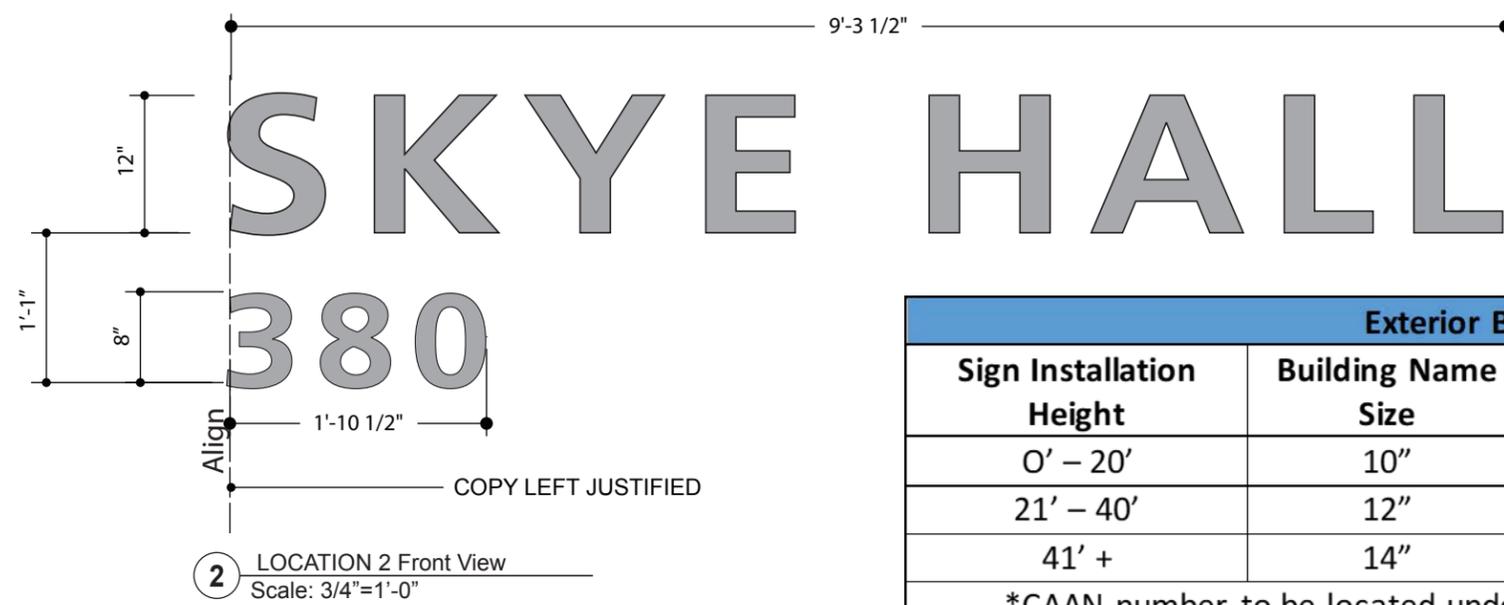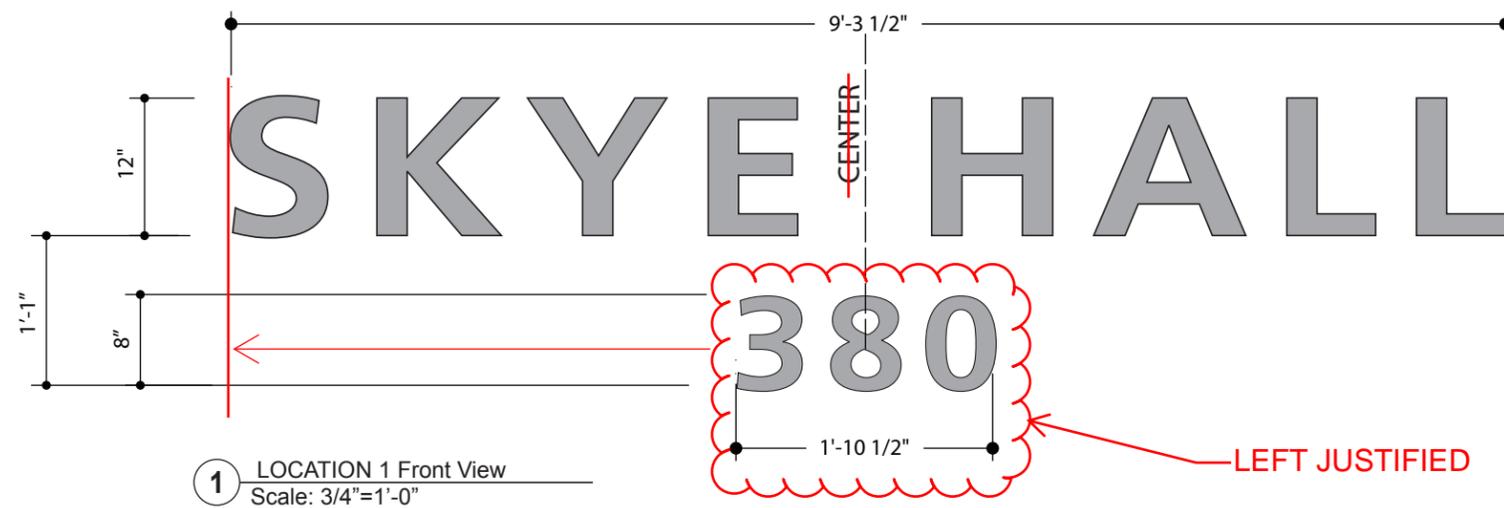Cast Aluminum, Brushed finish letters with 1/2" stainless steel stand-offs from wall.

Stainless steel all thread studs with wall mounting holes filled with 2-part epoxy adhesive.

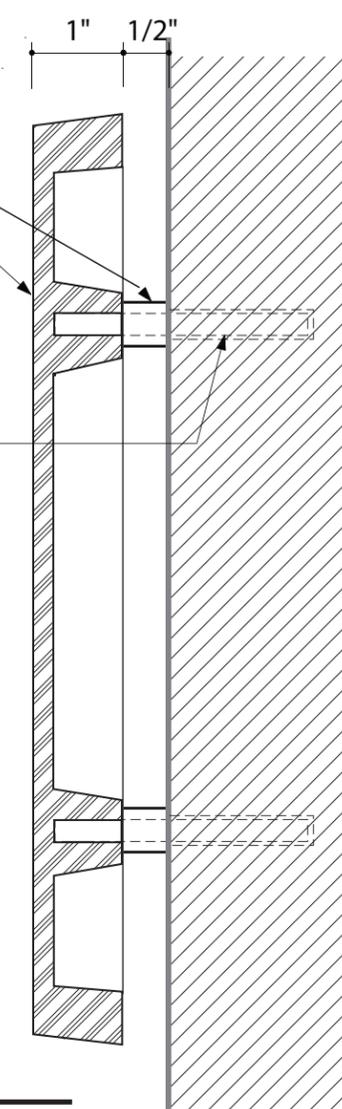

ITEM NO.: 1

QTY: 2

SIGN MATERIALS:
 Each sign location is consisting of 12"h & 8" h Cast letters with 1/2" stand-off from the wall for mounting.

MOUNTING:
 Wall mounted

COLOR/FINISH:
 Horizontal Brushed Finish

FONT:
 FRUTIGER 65 (BOLD)

Fabrication Drawing

Project
 UC Riverside
 1223 University Ave Suite 240

Customer
 UC Riverside
 Attn: Fernando Nunez
 Accounting Office-2
 Riverside, CA 92521
 P: (951) 827-2466
 E-Mail: Fernando.nunez@ucr.edu

Designers

Order Item: 1

Sign Type: Cast Letters

Revision No.:

Depending on height of letter location on the building, confer with University Representative on correct letter height.

Three digit fire address required per code (3 digits of Capital Asset Account No. (CAAN) - contact Campus Space Manager and Campus Fire Marshall)

TWO SETS of building identification and fire address are required for each building

A standalone monument sign for the building name is not allowed

ALUMINUM CAST LETTERS WITH HORIZONTALLY BRUSHED FINISH

Drawn By: MT



Vomar Products, Inc.
 7800 Deering Avenue
 Canoga Park, CA 91304-5005
 Tel.: 818-610-5115
 Fax: 818-610-5123
 E-mail: info@vomarproducts.com

| Exterior Building Sign Size Guide | | | |
|--|--------------------|------------------|---|
| Sign Installation Height | Building Name Size | CAAN Number Size | Spacing between Building Name and CAAN Number |
| 0' - 20' | 10" | 6" | 2" |
| 21' - 40' | 12" | 8" | 4" |
| 41' + | 14" | 10" | (still pending direction) |
| *CAAN number to be located under Building Name with numbers justified to left. | | | |
| **Only the last three numbers of the building CAAN number are to be installed | | | |

Sheet Date: 07/10/18

Sheet Number: 1.0



Exact placement to be determined in field.

Older standard provided for reference. Consult with University Representative for approval to use (only for special consideration).

Depending on height of letter location on the building, confer with PD&C on correct letter height. 3 digit

Fire address required per code (3 digits of Capital Asset Account No. (CAAN) - contact Campus Space Manager and Campus Fire Marshall)

TWO SETS of building identification and fire address are required for each building

LOCATION ELEVATION

N.T.S.




ELEVATION

3/4" = 1'-0"

Standard Times Bold cast bronze letters with 1/2" stainless steel stand-offs from wall.


Stainless steel all thread studs with wall mounting holes filled with 2-part epoxy adhesive.

Standard Times Bold cast bronze letters with 1/2" stainless steel stand-offs from wall.

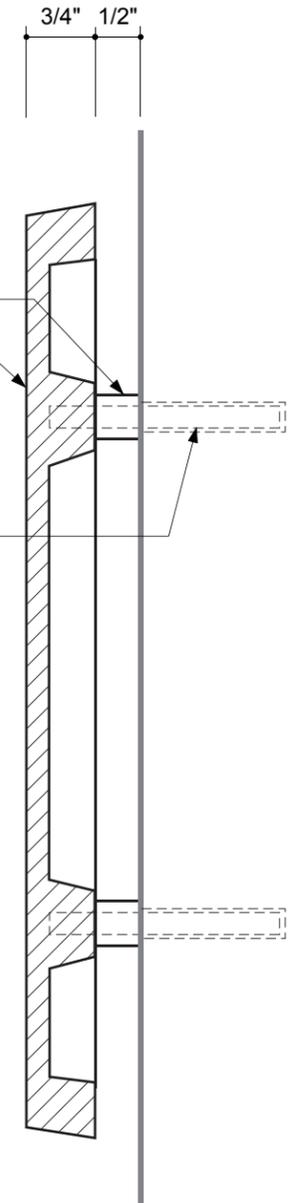


TYPICAL LETTER SECTION


3/4" = 1'-0"

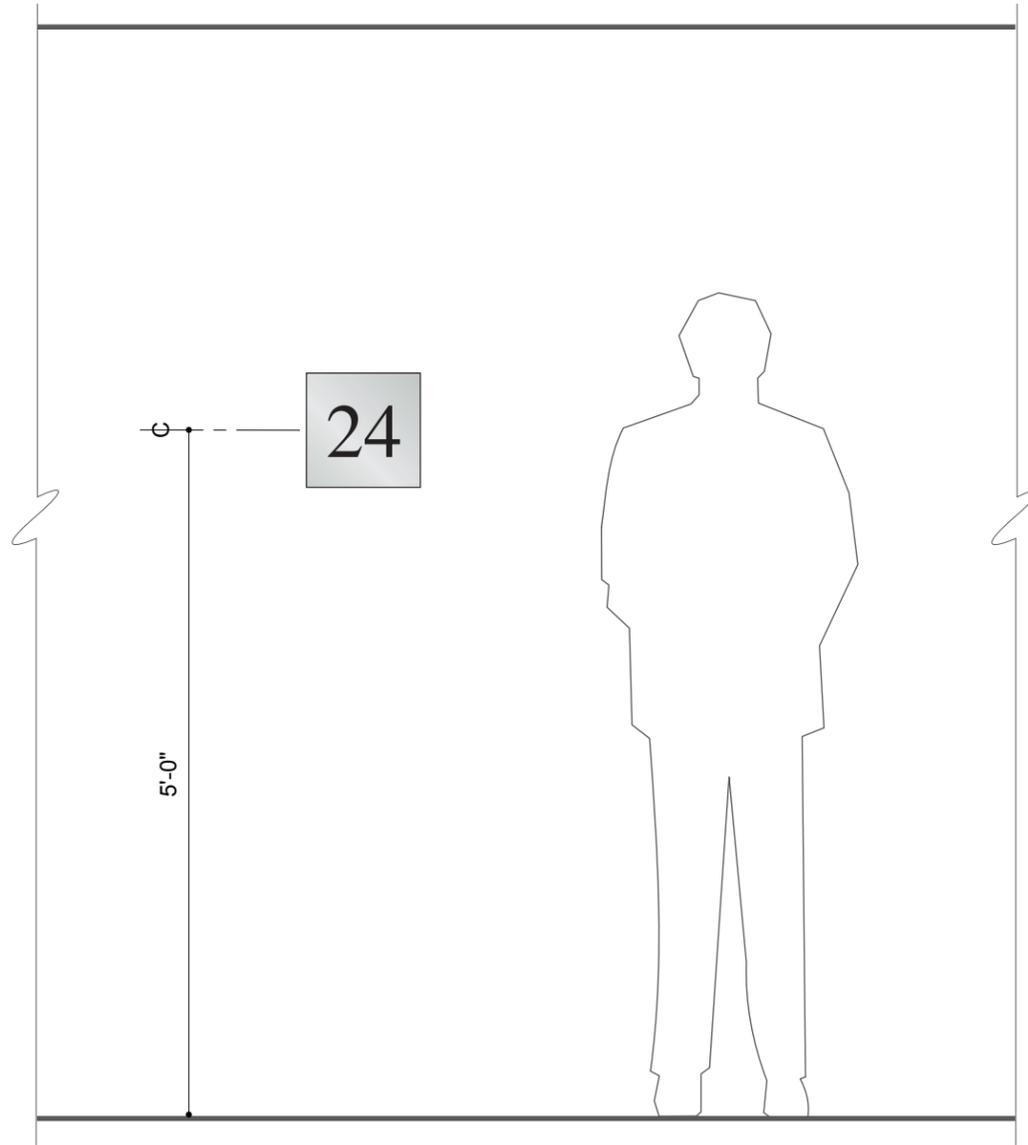


ELEVATION | 3/4" = 1'-0"

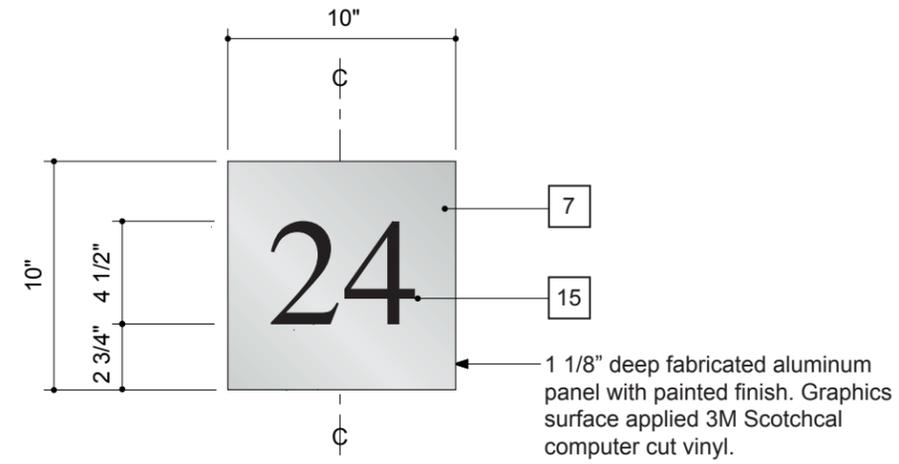

LAYOUT | 1 1/2" = 1'-0"

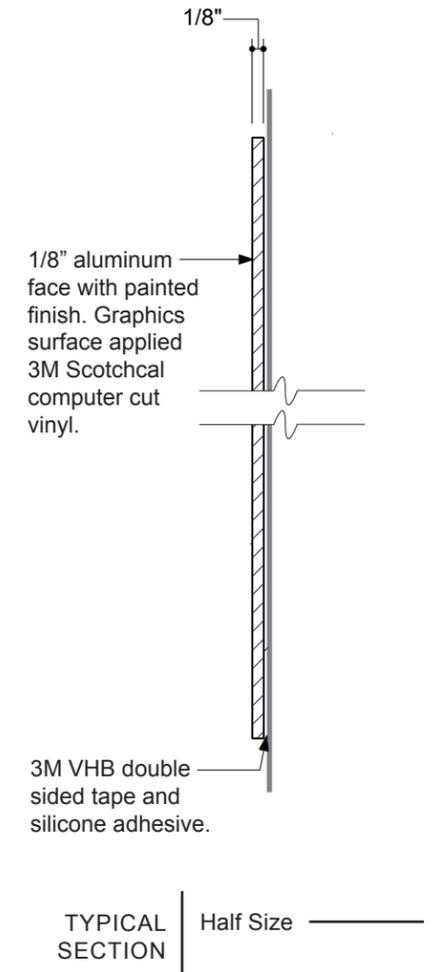

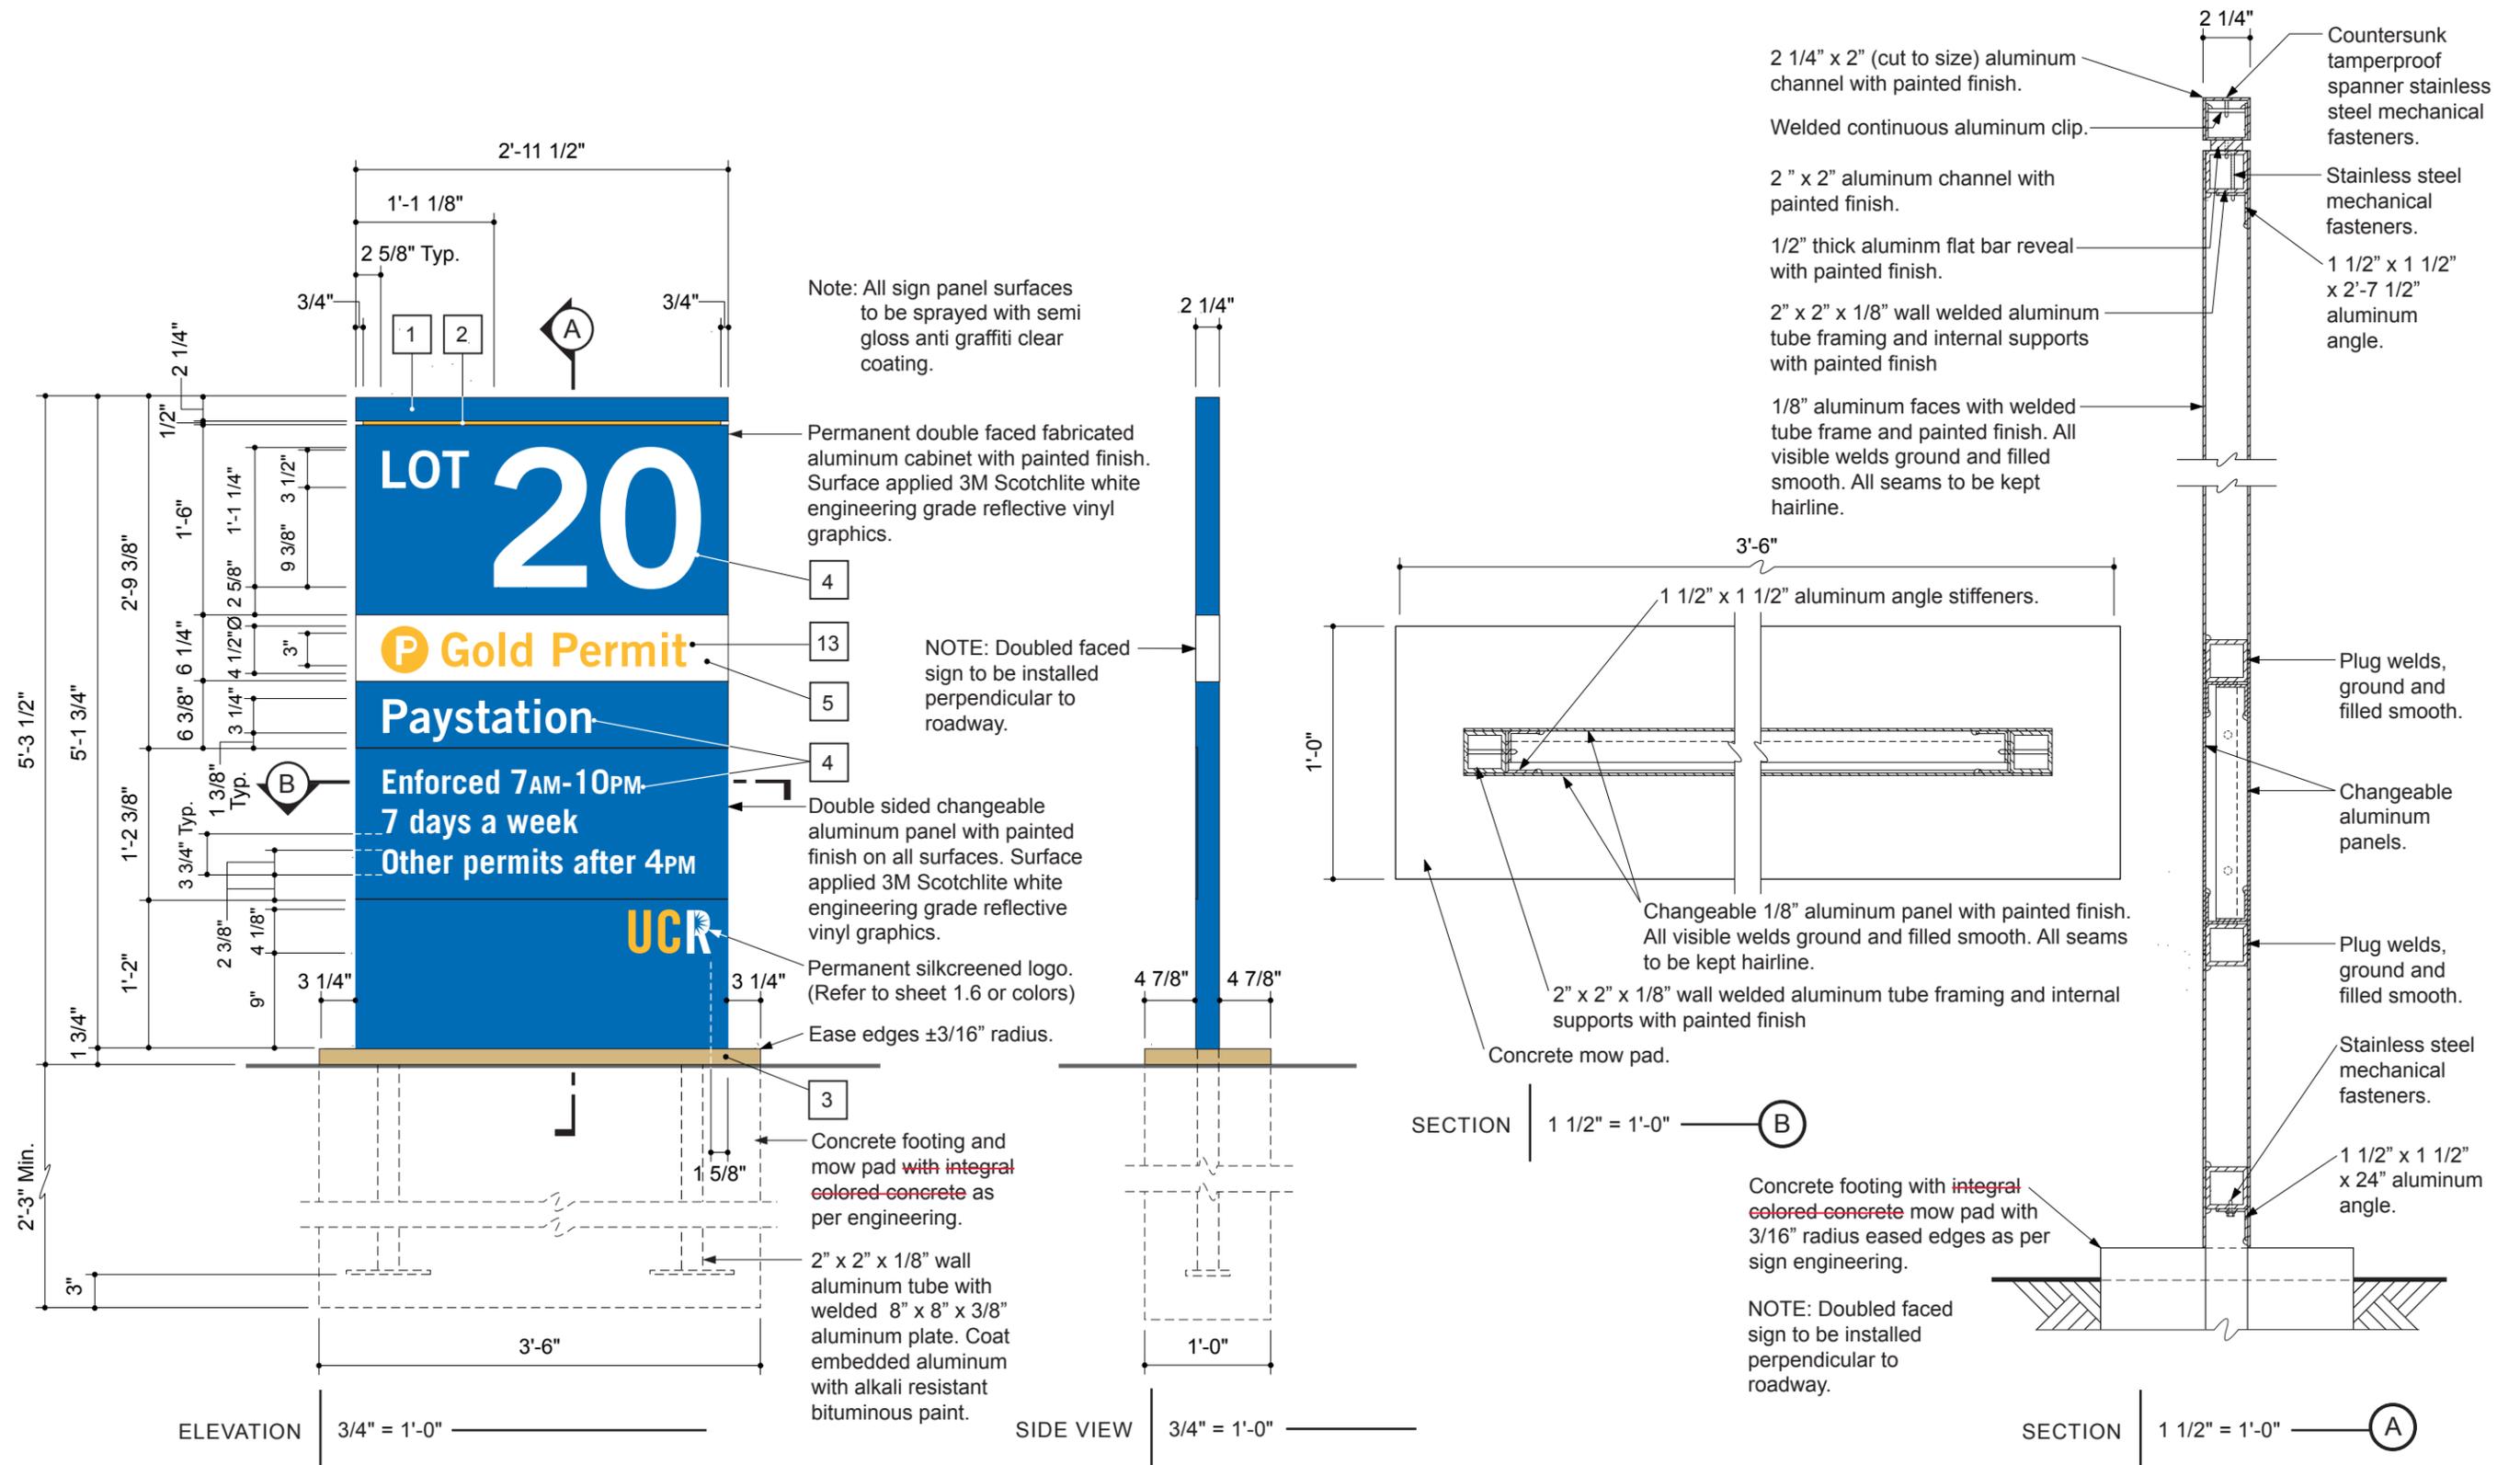


HUNT DESIGN
25 N. MENTOR AVE.
PASADENA, CA 91106

PAGE: 1 of 2
PROJECT: UC RIVERSIDE
SUBJECT: RIVERSIDE, CA
SIGN STRUCTURAL CALCS.
BY: DVM DATE: 10-1-07
P.O.# DWGS. FROM PERRY SHIMOJI

FOR COLUMN & FOOTING DESIGN

AREA -- SIGN TYPES W50.0 & W70.0
A = 5.29' * 2.96' = 15.7 S.F. (TYPE W70.0)

NOTE: SIGN TYPE W50.0 IS SLIGHTLY
SMALLER IN SIZE THAN TYPE W70.0 -
COLUMN & FOOTING DESIGN FOR BOTH
IS O.K. BY INSPECTION

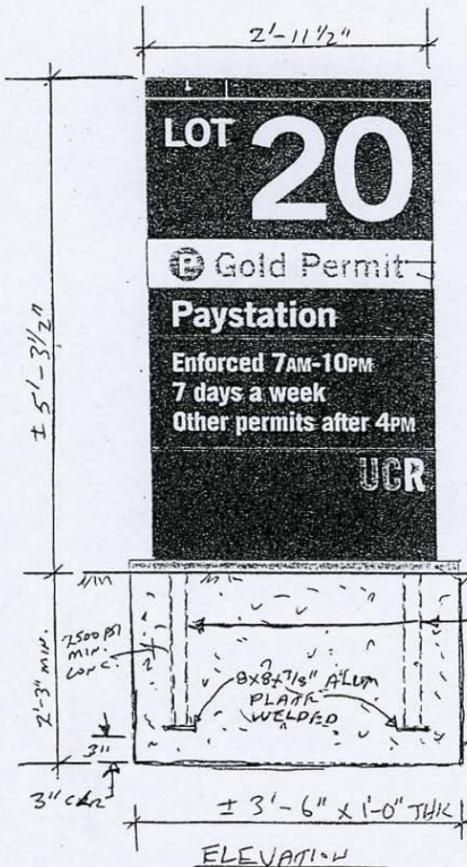

| | | |
|----------|----------------------------------|----------------|
| WIND | CBC-'01 | 80 MPH, EXP. C |
| CBC-1613 | $p=Cq \cdot Ce \cdot Qs \cdot I$ | $I=1.0$ |
| $Qs =$ | 16.4 | $Cq = 1.4$ |
| | 25.94 LBS/S.F. @ 20' | $Ce = 1.13$ |
| | 24.34 LBS/S.F. < 15' | $Ce = 1.06$ |
| S.F. | LBS | FT. |
| AREA | !PRESS! | X-DIST |
| 15.7 | 382 | 2.65 |
| 0.0 | 0 | 0.00 |
| 0.0 | 0 | 0.00 |
| 0.0 | 0 | 0.00 |

| | | | |
|----------------------|------|--------|------|
| TOTAL | 382 | 2.65 | 1013 |
| | | (AVE.) | |
| <u>DOUBLE COLUMN</u> | | | |
| MOM. 'K | 0.51 | | |

ALUM $F_b = 12$ K/SQ. IN.
 $S = M/F_b$ WIND 1/3 INCR.
 $S = 0.75 \cdot M$ (INCL 1.33 WIND)
 $S = 0.38$ IN³

$S = (bd^3 - b1 \cdot d1^3) / (6 \cdot d)$
 $d = 2$ $d1 = 1.75$
 $b = 2$ $b1 = 1.75$

USING 2"x2"x 1/8" ALUM. TUBE
 $S = 0.55$ IN³ > 0.38
O.K.

COAT ALUM. SURFACES EMBEDDED IN
CONC. WITH ONE HEAVY COAT OF
ALKALI-RESISTANT BITUMINOUS
(BITUMASTIC) PAINT TO 2" MIN.
ABOVE GRADE

WT. OF SIGN = 175 LBS +/-
AXIAL STRESS IS NEGLIGIBLE

SEE PAGE 2 FOR FOOTING DETAILS



JOB NO. HUNT-144

HUNT DESIGN
25 N. MENTOR AVE.
PASADENA, CA 91106

PAGE: 2 of 2
PROJECT: UC RIVERSIDE
SUBJECT: RIVERSIDE, CA
SIGN STRUCTURAL CALCS.
BY: DVM DATE: 10-1-07
P.O.# DWGS. FROM PERRY SHIMOJI






SINGLE FOOTING - STRAIGHT

DESIGN OF EMBEDDED POLE FOOTINGS

| | | | | |
|-------------------------------|------|------------|-------|-------|
| DESCRIPTION | >> | 42" WIDE | | |
| | >> | + 12" THK. | | |
| ALLOW PASSIVE | psf | 200 | 200 | 200 |
| MAX PASSIVE | psf | 1,500 | 1,500 | 1,500 |
| LOAD DURATION FACTOR | | 1.33 | 1.33 | 1.33 |
| POINT LOAD | lbs | 382 | 0 | 0 |
| LOAD HT. | ft | 2.65 | 0.00 | 0.00 |
| DIST. LOAD | #/ft | 0 | 0 | 0 |
| START HT. | ft | 0.00 | 0.00 | 0.00 |
| END HT. | ft | 0.00 | 0.00 | 0.00 |
| WIDTH/DIAMETER | in | 42 | 0 | 0 |
| CIRCULAR ? | y/n | N | N | N |
| RESTRAINED ? | y/n | N | N | N |
| SUMMARY | | | | |
| Moments @ Surface: | | | | |
| Point Load | ft-# | 1,012 | 0 | 0 |
| Uniform Load | ft-# | 0 | 0 | 0 |
| ... Total Moment | ft-# | 1,012 | 0 | 0 |
| Total Lateral Load | # | 382 | 0 | 0 |
| NON-RESTRAINED | | | | |
| Min. Req'd Embedment | | | | |
| $A(1+(1+4.36h/A)^{.5})/2$ | ft | 2'-3" | | |
| $A=2.34P/(S \cdot 1 \cdot b)$ | ft | 2.18' | 0.00 | 0.00 |
| Press @ 1/3 Embed.: | | | | |
| Actual | psf | 194 | 0 | 0 |
| Allowable | psf | 193 | 0 | 0 |
| RESTRAINED | | | | |
| Min. Req'd Embedment | | | | |
| $(4.25 P h / S3 b)^{.5}$ ft | ft | 0.00 | 0.00 | 0.00 |
| Pressure @ Bottom | | | | |
| Actual | psf | 0 | 0 | 0 |
| Allowable | psf | 0 | 0 | 0 |
| Surface Restraint Force | lbs | 0 | 0 | 0 |

PER CBC TABLE 18-1-A
POLE 2X ALLOWABLE



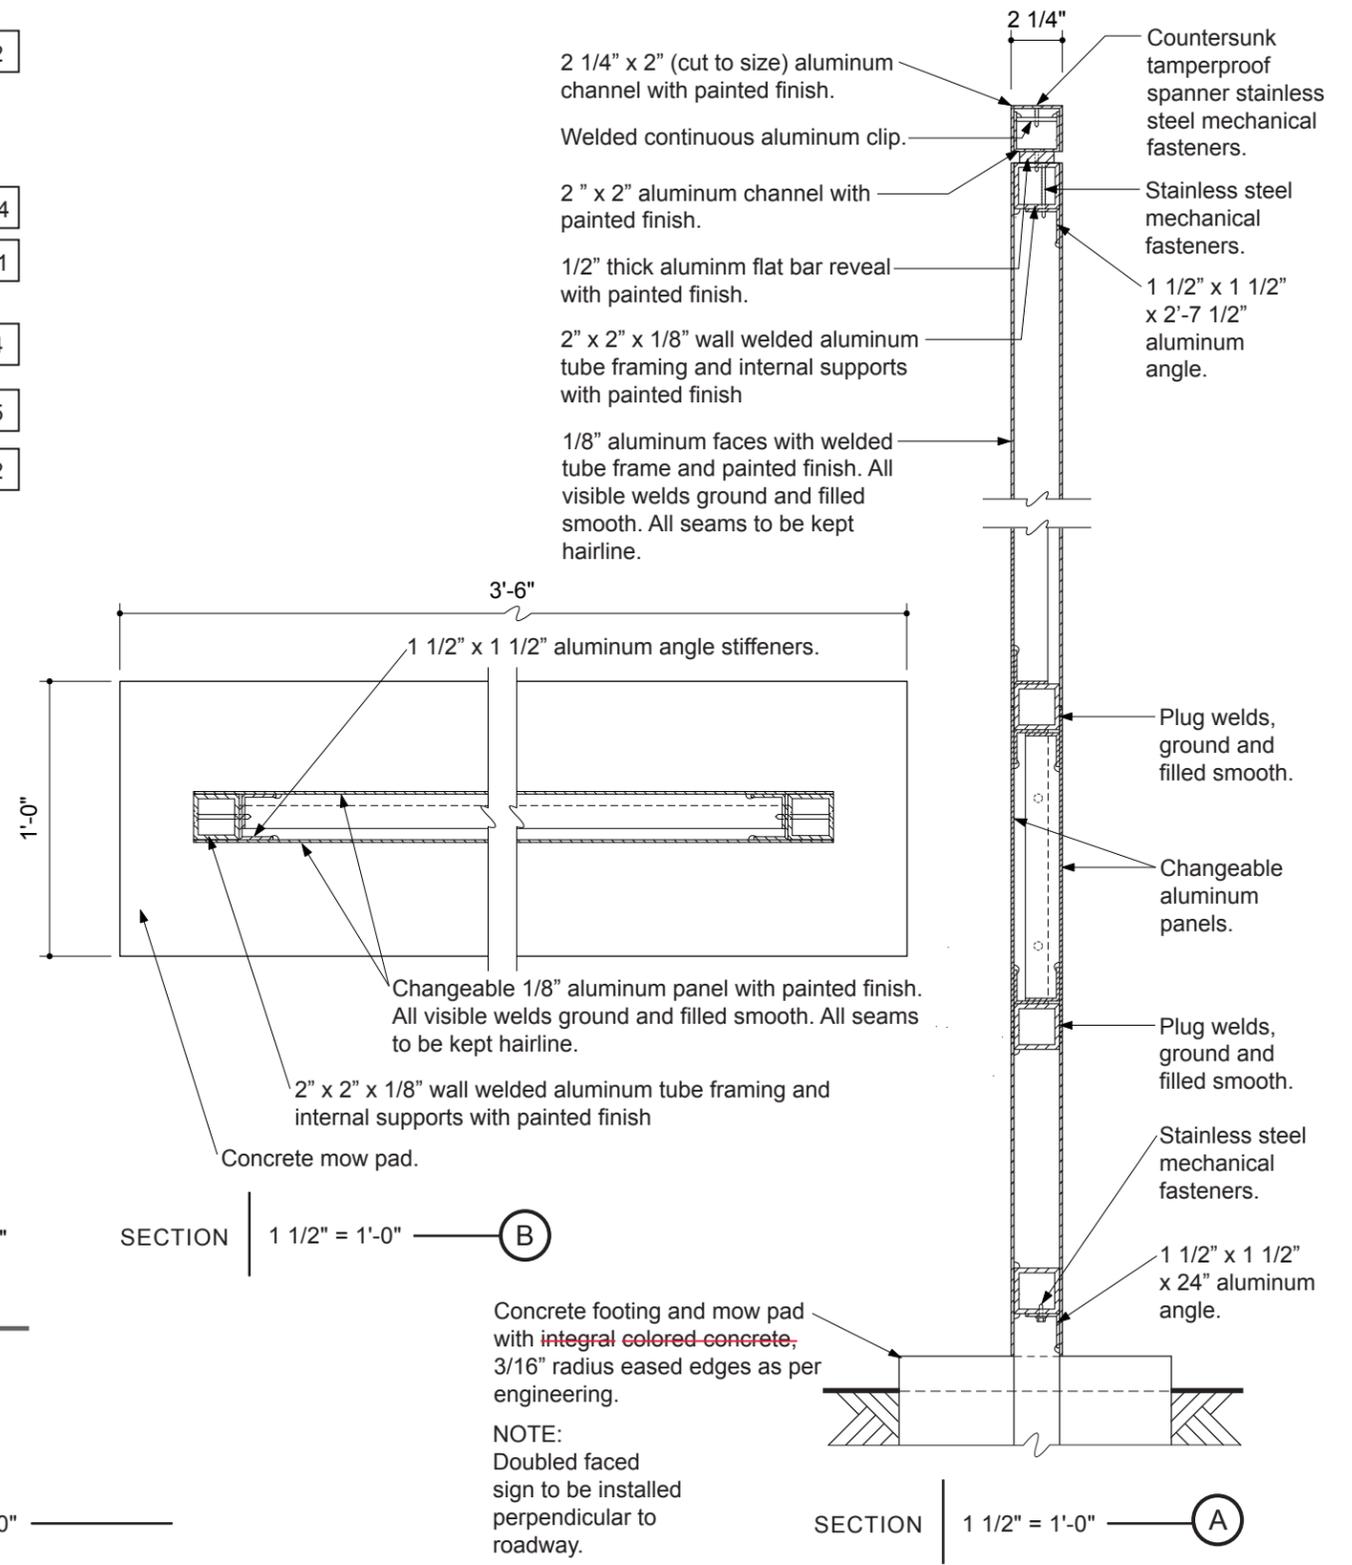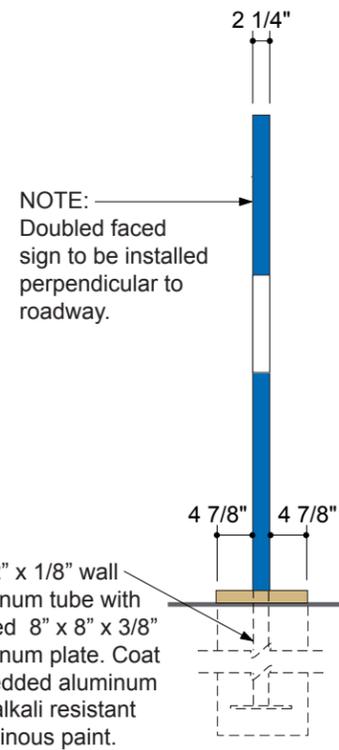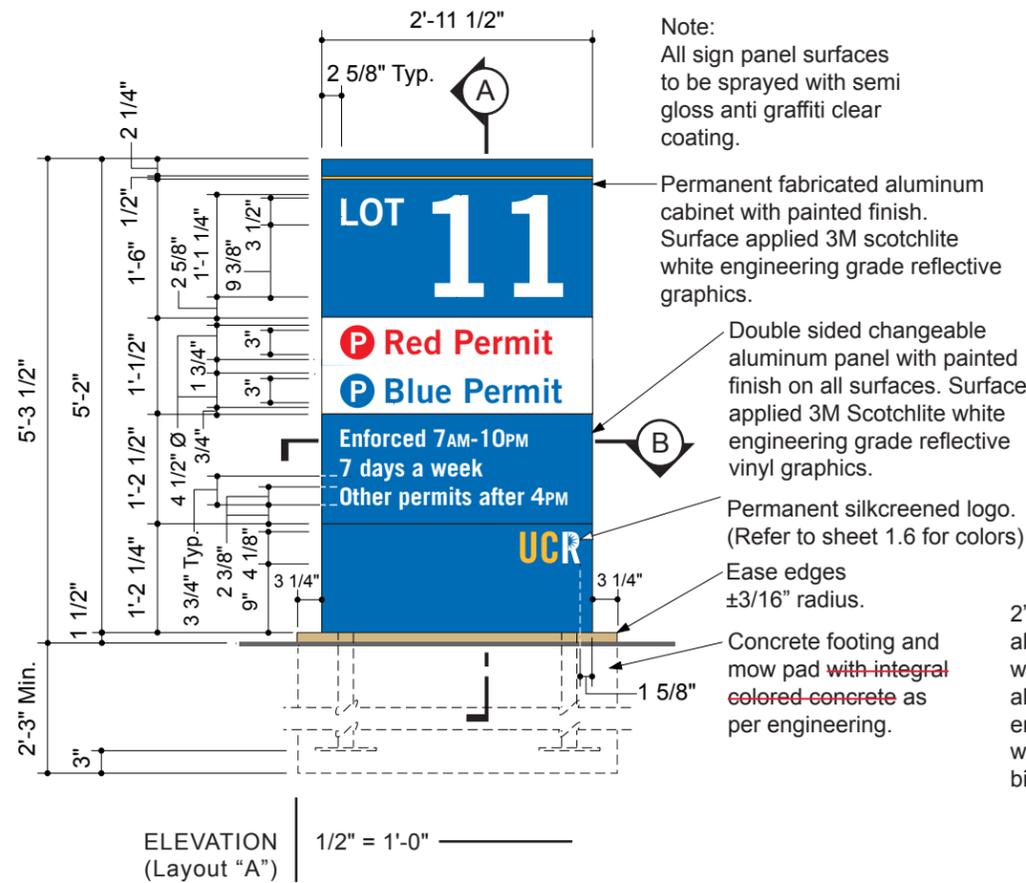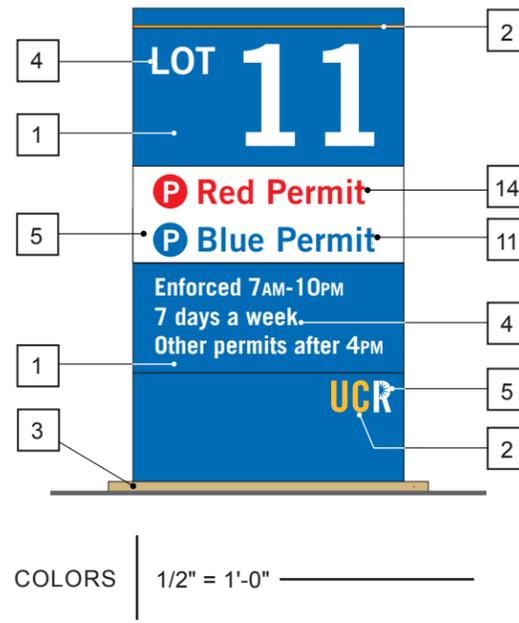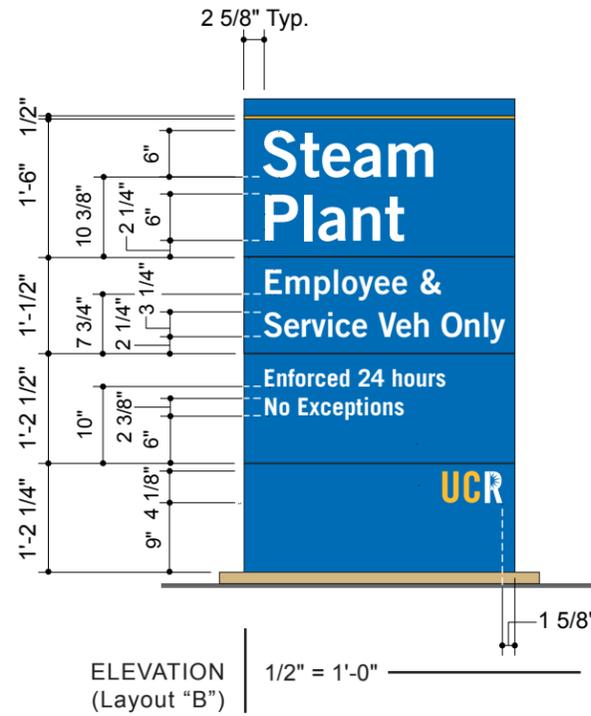


HUNT DESIGN
25 N. MENTOR AVE.
PASADENA, CA 91106

PAGE: 1 of 2
PROJECT: UC RIVERSIDE
SUBJECT: RIVERSIDE, CA
SIGN STRUCTURAL CALCS.
BY: DVM DATE: 10-1-07
P.O.# DWGS. FROM PERRY SHIMOJI

FOR COLUMN & FOOTING DESIGN

AREA -- SIGN TYPES W50.0 & W70.0
A = 5.29' * 2.96' = 15.7 S.F. (TYPE W70.0)

NOTE: SIGN TYPE W50.0 IS SLIGHTLY
SMALLER IN SIZE THAN TYPE W70.0 -
COLUMN & FOOTING DESIGN FOR BOTH
IS O.K. BY INSPECTION

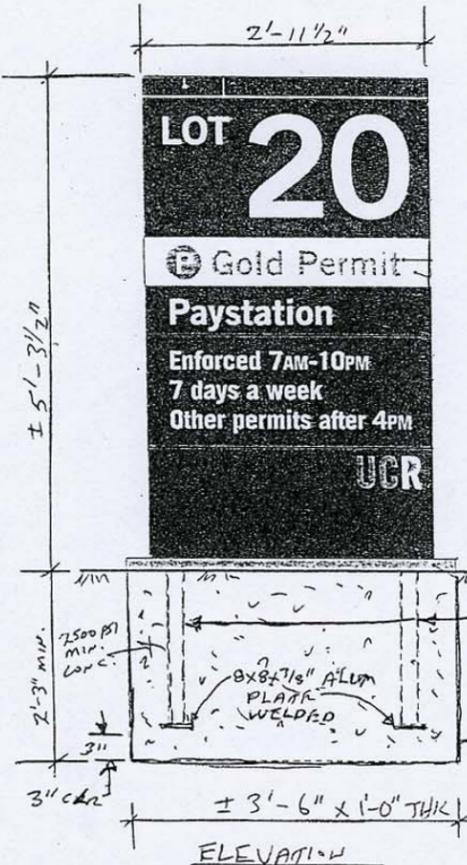

JOB NO. HUNT-144

WIND CBC-'01 80 MPH, EXP. C

| | | |
|----------|------------------------|-------------|
| CBC-1613 | $p=Cq*Ce*Qs*I$ | $I=1.0$ |
| $Qs =$ | 16.4 | $Cq = 1.4$ |
| | 25.94 LBS/S.F. @ 20' | $Ce = 1.13$ |
| | 24.34 LBS/S.F. < 15' | $Ce = 1.06$ |
| S.F. | LBS | FT. |
| AREA | !PRESS! | X-DIST |
| 15.7 | 382 | 2.65 |
| 0.0 | 0 | 0.00 |
| 0.0 | 0 | 0.00 |
| 0.0 | 0 | 0.00 |

TOTAL 382 2.65 1013 (AVE.)

DOUBLE COLUMN MOM.'K 0.51

ALUM $F_b = 12$ K/SQ. IN.
 $S = M/F_b$ WIND 1/3 INCR.
 $S = 0.75 * M$ (INCL 1.33 WIND)
 $S = 0.38$ IN³

$S = (bd^3 - b1*d1^3) / (6*d)$
 $d = 2$ $d1 = 1.75$
 $b = 2$ $b1 = 1.75$

USING 2"x2"x 1/8" ALUM. TUBE
 $S = 0.55$ IN³ > 0.38
O.K.

COAT ALUM. SURFACES EMBEDDED IN CONC. WITH ONE HEAVY COAT OF ALKALI-RESISTANT BITUMINOUS (BITUMASTIC) PAINT TO 2" MIN. ABOVE GRADE

WT. OF SIGN = 175 LBS +/-
AXIAL STRESS IS NEGLIGIBLE

SEE PAGE 2 FOR FOOTING DETAILS



HUNT DESIGN
25 N. MENTOR AVE.
PASADENA, CA 91106






PAGE: 2 of 2
PROJECT: UC RIVERSIDE
SUBJECT: RIVERSIDE, CA
SIGN STRUCTURAL CALCS.
BY: DVM DATE: 10-1-07
P.O.# DWGS. FROM PERRY SHIMOJI


SINGLE FOOTING - STRAIGHT

DESIGN OF EMBEDDED POLE FOOTINGS


| DESCRIPTION | >> | 42" WIDE | >> | PER CBC TABLE 18-1-A POLE 2X ALLOWABLE |
|-------------------------|------|------------|-------|---|
| | | + 12" THK. | | |
| ALLOW PASSIVE | psf | 200 | 200 | 200 |
| MAX PASSIVE | psf | 1,500 | 1,500 | 1,500 |
| LOAD DURATION FACTOR | | 1.33 | 1.33 | 1.33 |
| POINT LOAD | lbs | 382 | 0 | 0 |
| LOAD HT. | ft | 2.65 | 0.00 | 0.00 |
| DIST. LOAD | #/ft | 0 | 0 | 0 |
| START HT. | ft | 0.00 | 0.00 | 0.00 |
| END HT. | ft | 0.00 | 0.00 | 0.00 |
| WIDTH/DIAMETER | in | 42" | 0 | 0 |
| CIRCULAR ? | y/n | N | N | N |
| RESTRAINED ? | y/n | N | N | N |
| SUMMARY | | | | |
| Moments @ Surface: | | | | |
| Point Load | ft-# | 1,012 | 0 | 0 |
| Uniform Load | ft-# | 0 | 0 | 0 |
| ... Total Moment | ft-# | 1,012 | 0 | 0 |
| Total Lateral Load | # | 382 | 0 | 0 |
| NON-RESTRAINED RESULTS | | | | |
| Min. Req'd Embedment | | 2'-3" | | |
| $A(1+(1+4.36h/A)^.5)/2$ | ft | 2.18' | 0.00 | 0.00 |
| $A=2.34P/(S 1 b)$ | | DEPTH | | |
| Press @ 1/3 Embed.: | | | | |
| Actual | psf | 194 | 0 | 0 |
| Allowable | psf | 193 | 0 | 0 |
| RESTRAINED RESULTS | | | | |
| Min. Req'd Embedment | | 0.00 | 0.00 | 0.00 |
| $(4.25 P h/S3 b)^.5$ ft | | | | |
| Pressure @ Bottom | | | | |
| Actual | psf | 0 | 0 | 0 |
| Allowable | psf | 0 | 0 | 0 |
| Surface Restraint Force | lbs | 0 | 0 | 0 |



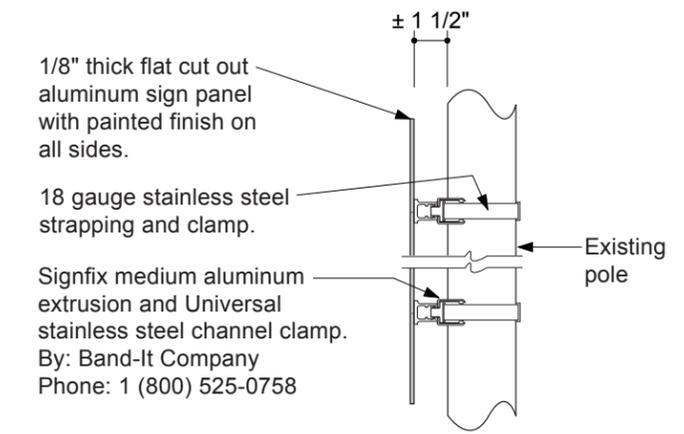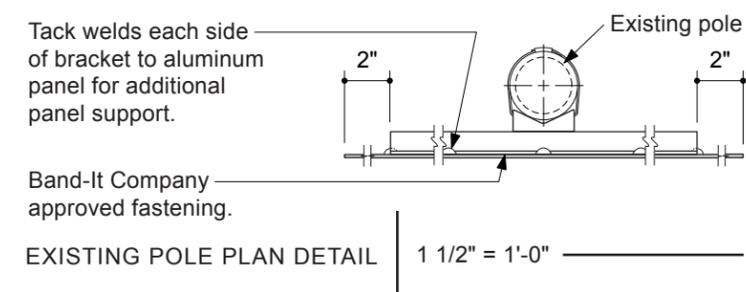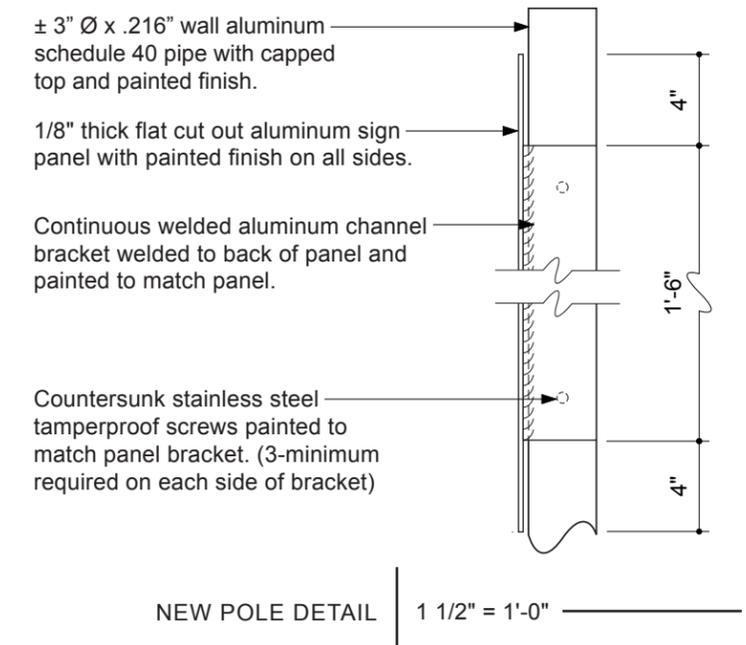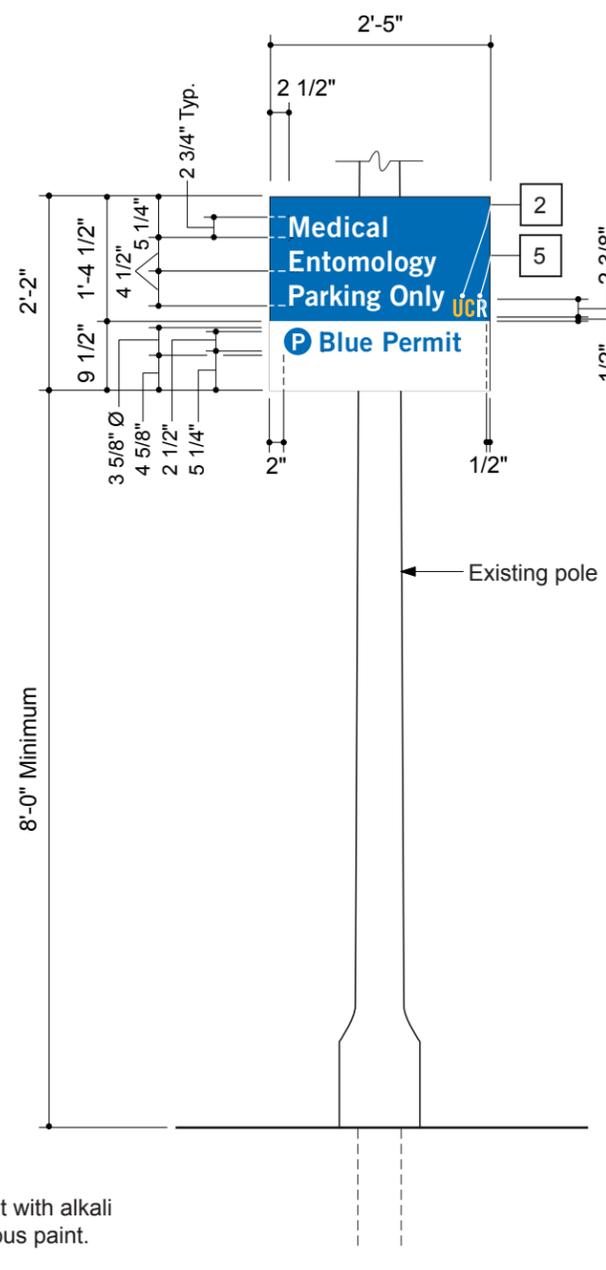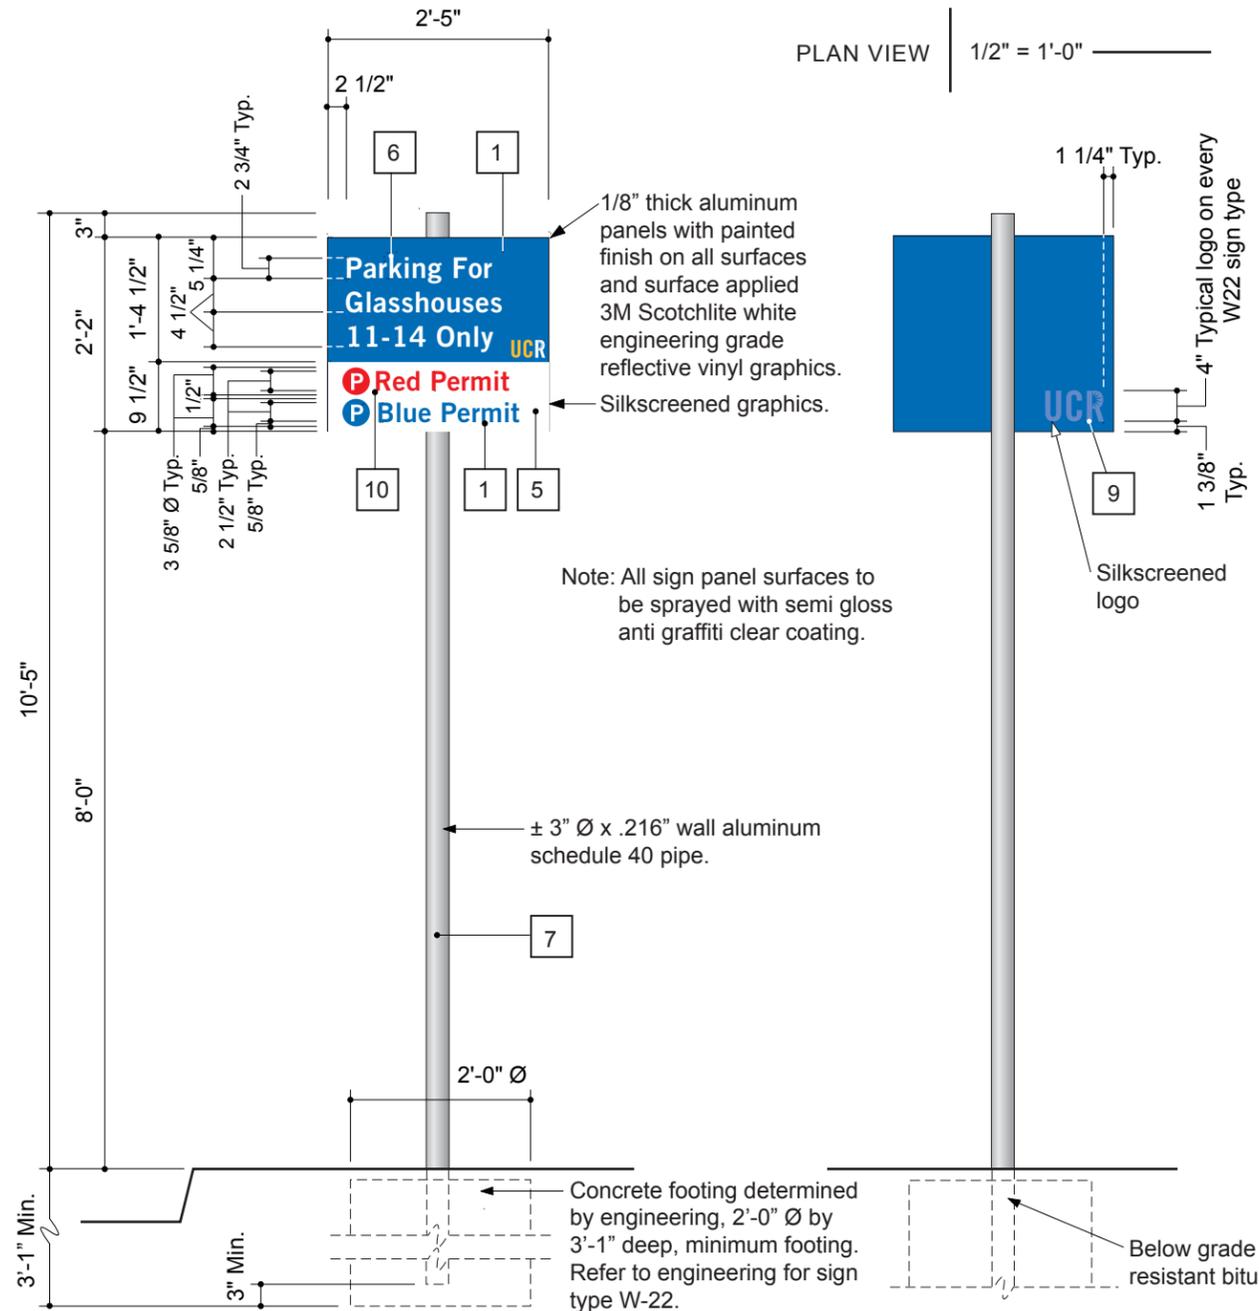


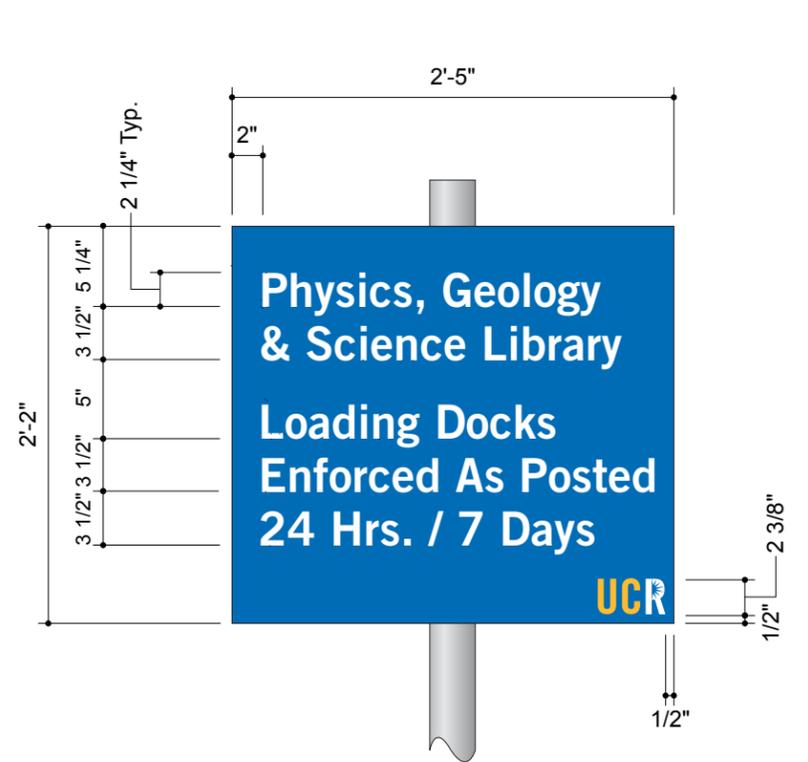


5-LINE CONDITION | 1" = 1'-0"

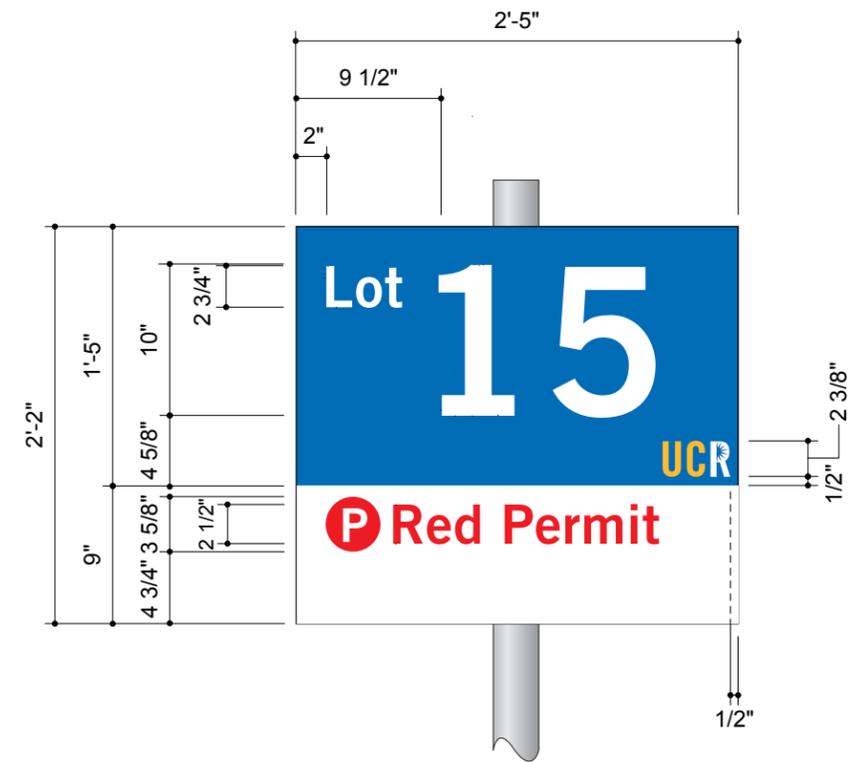

2-LINE CONDITION W/ LARGE NUMERAL | 1" = 1'-0"

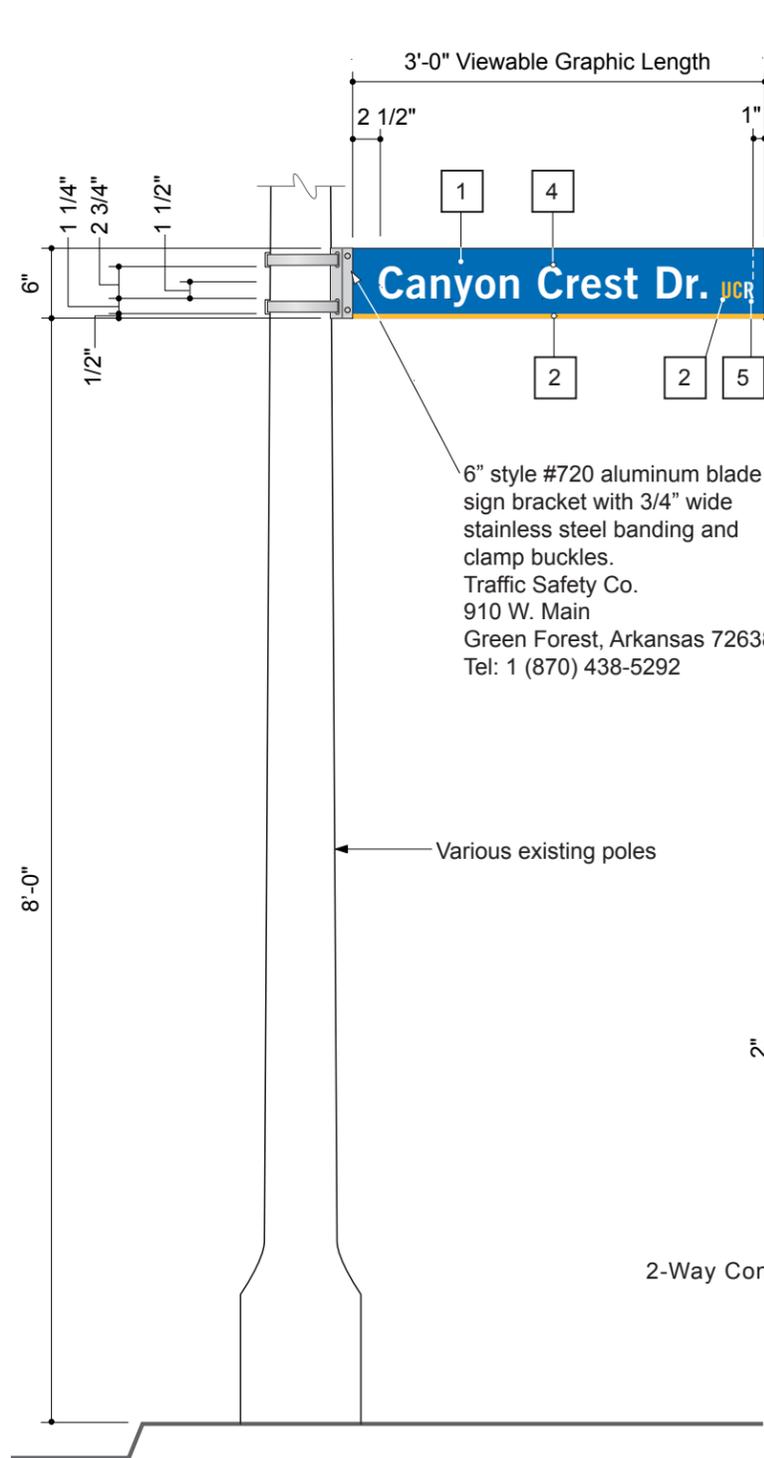


ELEVATION 1-Way Condition | 3/4" = 1'-0"



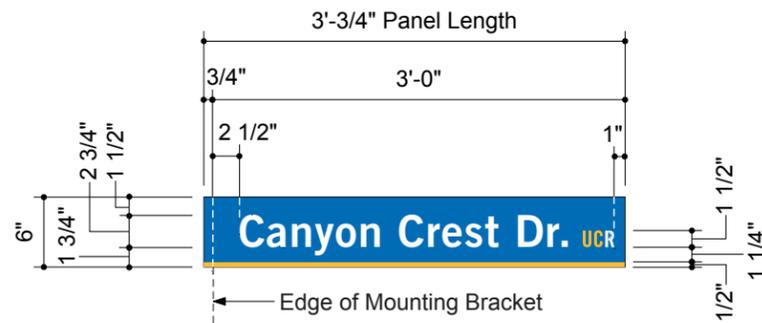


TYPICAL PANEL | 3/4" = 1'-0"

Note: All sign panel surfaces to be sprayed with semi gloss anti graffiti clear coating.

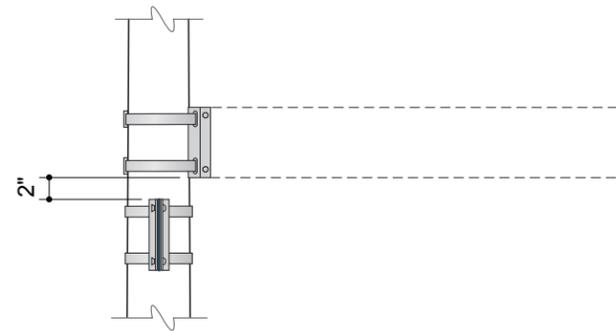

2-Way Condition | 3/4" = 1'-0"

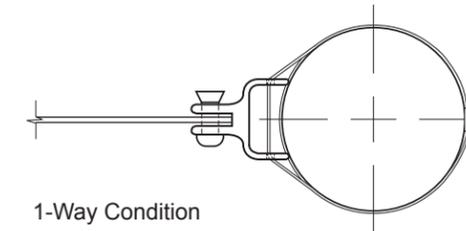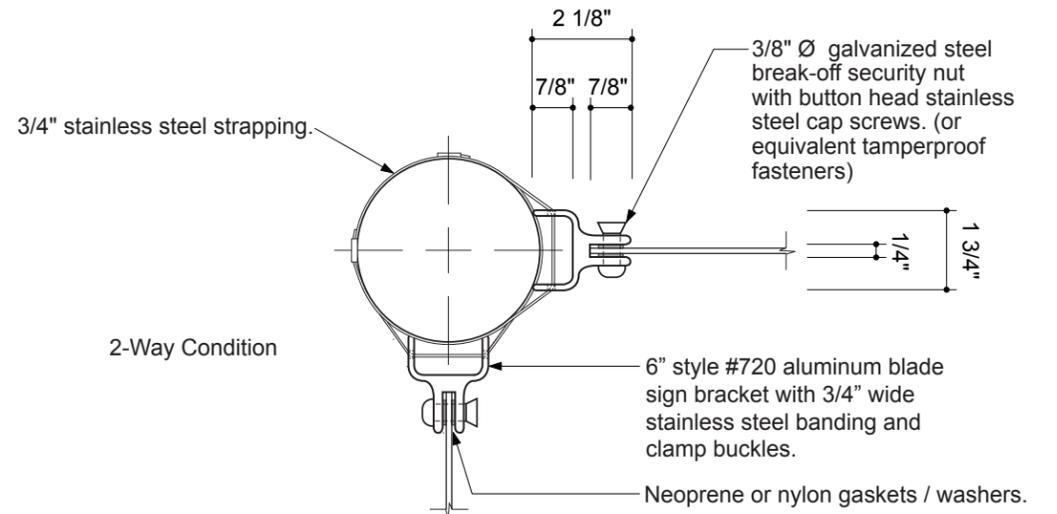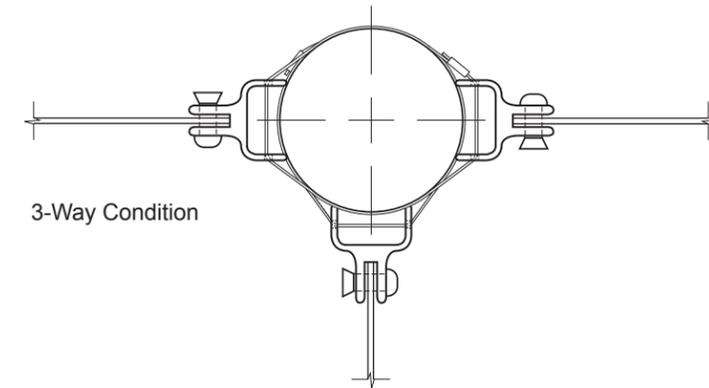

PLAN VIEWS | 3" = 1'-0"

**INTERIOR SIGNAGE PROGRAM for
Multidisciplinary Research Building (MRB)
PDF pages 67 to 97**

Follow the details per the sign program for the Multidisciplinary Research Building project for all interior signage. There may be some flexibility with color. Consult with University representative if a different color (from what is prescribed in the MRB set) is desired

If an interior signtype not included in the MRB set is desired, refer to the most recent annotated version of the Campus Sign Program for style guidance and adapt to be complementary to the building interior sign program. Consult with University representative on proposed design.

If project-specific interior or exterior signage is desired, consult with University representative

Contents

| | |
|--|-----------|
| Interior Signs | 03 |
| DIN Medium ADA Font Analysis | 04 |
| Exit / Exit Route Design and Specification | 05 |
| Emergency Signs Design and Specification | 06 |
| Sign Type B81 Stair Door and Level ID | 07 |
| Sign Type B75 Evacuation Map | 08 |
| Sign Type FS In Case of Fire Elevator Sign | 09 |
| Sign Type EJS Elevator Jamb Sign | 10 |
| Sign Type: Star of Life | 11 |
| Sign Type B92 Assessible ID | 12 |
| Sign Type B70 Room ID | 13 |
| Sign Type B31 Wall Mounted Paper Holder Room ID | 14 |
| Sign Type B31 Wall Mounted Paper Holder Room ID | 15 |
| Sign Type B36 Wall Mounted Restroom ID | 16 |
| Sign Type B80 Door Mounted Restroom ID | 17 |
| Sign Type B82 Wall Mounted Stair ID | 18 |
| Sign Type B60 Wall Mounted Secondary Info | 19 |
| Sign Type B32 Wall Mounted Paper Holder Room ID | 20 |
| Lab Bench Lab Bench / Lab Safety Sign | 21 |
| Sign Type B95 Wall Mounted Loading Dock | 22 |
| Sign Type 2W Wall Communication Device Instructions | 23 |
| Sign Type FDC Fire Department Connection | 24 |

Interior Sign Installation Guidelines 25


| | |
|--|----|
| Install Guidelines ADA sign installation | 26 |
| Install Guidelines Room Signs, Office Signs | 27 |
| Install Guidelines Conference Room, Exit Signs | 28 |
| Install Guidelines Dual ADA Room Signs | 29 |
| Install Guidelines Restrooms, Evac Maps, ALD, Accessible ID | 30 |
| Install Guidelines Stair Signs | 31 |
| Install Guidelines Elevator Bay | 32 |

03

Interior Signs

General Contractor: Hensel Phelps
Project: UCR MRB1
Developed By: Century Sign Builders

10

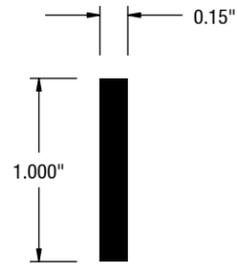

1 **DIN MEDIUM**
SCALE: 1:1

2 **STROKE THICKNESS**
SCALE: 1:1

3 **CHARACTER PROPORTIONS**
SCALE: 1:1

| DIN Medium Font Title: DIN Medium | | | | Tactile Specifications | | | Visual Specifications | | | | | | | | | | | | | | | | | | | | | | | | | | | | | | | | | | |
|---|
| <p>Passed ADA Compliant Raised Characters Passed ADA Visual Characters</p> <p>Reference Excel Sheet M:\ADAVADA Font Tests\CSB ADA Font List</p> | | | | 703.2.4 Character Proportions Characters shall be selected from fonts where the width of the uppercase letter "O" is 55 percent minimum and 110 percent maximum of the height of the uppercase letter "I". | | | 703.2.6 Stroke Thickness Stroke thickness of the uppercase letter "I" shall be 15 percent maximum of the height of the character. | | | 703.5.4 Character Proportions Characters shall be selected from fonts where the width of the uppercase letter "O" is 55 percent minimum and 110 percent maximum of the height of the uppercase letter "I". | | | 703.5.7 Stroke Thickness. Stroke thickness of the uppercase letter "I" shall be 10 percent minimum and 30 percent maximum of the height of the character. | | | | | | | <p>Compliant Range</p> <table border="1"> <tr> <th>Width of "O" is</th> <th>MIN Inches</th> <th>MAX Inches</th> <th></th> </tr> <tr> <td>0.719"</td> <td>0.55" (55%)</td> <td>1.1" (110%)</td> <td>PASS</td> </tr> </table> | | | Width of "O" is | MIN Inches | MAX Inches | | 0.719" | 0.55" (55%) | 1.1" (110%) | PASS | <p>Compliant Range</p> <table border="1"> <tr> <th>Width of "I" is</th> <th>MAX Inches</th> <th></th> </tr> <tr> <td>0.15"</td> <td>0.15" (15%)</td> <td>PASS</td> </tr> </table> | | | Width of "I" is | MAX Inches | | 0.15" | 0.15" (15%) | PASS | <p>Compliant Range</p> <table border="1"> <tr> <th>Width of "O" is</th> <th>MIN Inches</th> <th>MAX Inches</th> <th></th> </tr> <tr> <td>0.719"</td> <td>0.55" (55%)</td> <td>1.1" (110%)</td> <td>PASS</td> </tr> </table> | | | Width of "O" is | MIN Inches | MAX Inches | | 0.719" | 0.55" (55%) | 1.1" (110%) | PASS | <p>Compliant Range</p> <table border="1"> <tr> <th>Width of "I" is</th> <th>MIN Inches</th> <th>MAX Inches</th> <th></th> </tr> <tr> <td>0.15"</td> <td>0.1" (10%)</td> <td>0.3" (30%)</td> <td>PASS</td> </tr> </table> | | | Width of "I" is | MIN Inches | MAX Inches | |
| Width of "O" is | MIN Inches | MAX Inches | | | | | | | | | | | | | | | | | | | | | | | | | | | | | | | | | | | | | | | |
| 0.719" | 0.55" (55%) | 1.1" (110%) | PASS | | | | | | | | | | | | | | | | | | | | | | | | | | | | | | | | | | | | | | |
| Width of "I" is | MAX Inches | | | | | | | | | | | | | | | | | | | | | | | | | | | | | | | | | | | | | | | | |
| 0.15" | 0.15" (15%) | PASS | | | | | | | | | | | | | | | | | | | | | | | | | | | | | | | | | | | | | | | |
| Width of "O" is | MIN Inches | MAX Inches | | | | | | | | | | | | | | | | | | | | | | | | | | | | | | | | | | | | | | | |
| 0.719" | 0.55" (55%) | 1.1" (110%) | PASS | | | | | | | | | | | | | | | | | | | | | | | | | | | | | | | | | | | | | | |
| Width of "I" is | MIN Inches | MAX Inches | | | | | | | | | | | | | | | | | | | | | | | | | | | | | | | | | | | | | | | |
| 0.15" | 0.1" (10%) | 0.3" (30%) | PASS | | | | | | | | | | | | | | | | | | | | | | | | | | | | | | | | | | | | | | |
| Font Name | Test Height of "I" | Raised Characters Compliant | Visual Characters Compliant | Width of "O" is | MIN Inches | MAX Inches | | Width of "O" is | MIN Inches | MAX Inches | | Width of "O" is | MIN Inches | MAX Inches | | Width of "I" is | MIN Inches | MAX Inches | | | DIN Medium | 1" | YES | YES | 0.719" | 0.55" | 1.1" | PASS | 0.15" | 0.15" | | PASS | 0.719" | 0.55" | 1.1" | PASS | 0.15" | 0.1" | 0.3" | PASS | | | | | | | | | | | | | | | | | | | | | | |


FILE PATH Q:\UCR MRB1\20180426 UCR Contract\Renderings, Submittals & PDFs\Submittals\Archive\UCR MRB1_Interior Code Signs

EXIT SIGN


Sign Type: ADA Exit Sign / Exit Route

SIGN SPECIFICATIONS


- 1. SIGN PANEL SUBSTRATE**
 Finish Size: 3" H x 5" W
 Material: Plaskolite Non-Glare Clear Acrylic (P99)
 Thickness: 1/4"
 Backpaint: Matthews MAP-LVS202 White
- 2. TACTILE APPLIQUÉ**
 Material: Modified Acrylic
 Font Height: 1 1/4" and 5/8" Tall
 Font Depth: 1/32" Thick
 Font: DIN Medium
 Font Color: 311-307 Charcoal Grey
- 3. BRAILLE**
 Type: Clear Grade II Braille
- 4. MOUNTING**
 Tape: 1/16" Thick Double Sided Foam Tape & RTV 108 Silicon Adhesive as needed

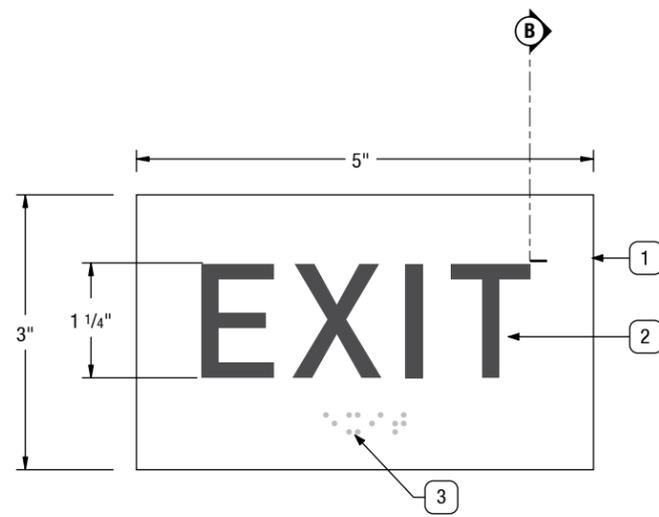

A EXIT DOOR SIGN
SCALE: 1:3

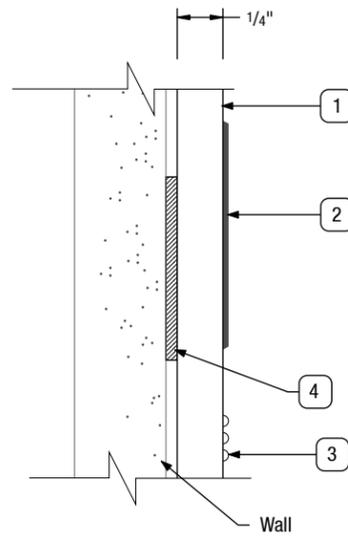

B DETAIL SECTION
SCALE: 1:1

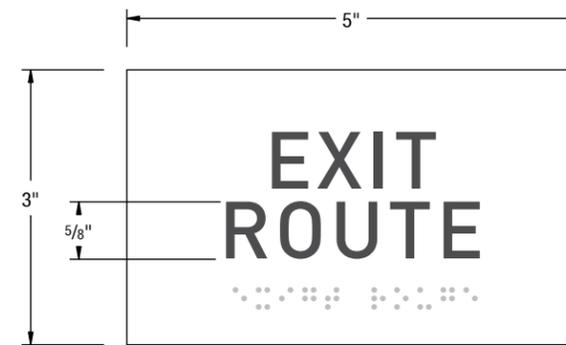

C EXIT ROUTE DOOR SIGN
SCALE: 1:3

FILE PATH Q:\UCR MRB1\20180426 UCR Contract\Renderings, Submittals & PDFs\Submittals\Archive\UCR MRB1_Interior Code Signs



| CONTACT | DRAWN BY | CLIENT / PROJECT | DATE | SHEET TITLE | SHEET |
|---|--|--|--|---|-------|
| Albuquerque / Phoenix P 505.888.2901 ext 109 F 505.888.2902 csbsigns.com | Lawrence Spingola Lawrence Spingola@csbsigns.com <small>This artwork and design is owned by Century Sign Builders unless expressly stated. Use of this document or the design shown here without permission is prohibited.</small> | Client / GC: Hensel Phelps Project: University of California, Riverside - MRB1 APPROVAL REQUIRED FOR PRODUCTION | Modification Date: July 24, 2018 4:03 PM SIGNATURE / DATE | Exit / Exit Route Design and Specification | 05 |

AR / EP / FA

Description:
 - Area of Refuge Sign
 - Emergency Phone
 - Fire Alarm Pull

SIGN SPECIFICATIONS

1. SIGN PANEL SUBSTRATE (FACES)

Finish Sizes:
 - .75" H x 10" W (top piece)
 - 4" H x 10" W (Bottom piece)
 Material: 1/8" Plaskolite Non-Glare
 Clear Acrylic (P99)
 Backpaint: Matthews MAP-LVS202 White

2. TACTILE APPLIQUÉ

Material: Modified Acrylic
 Font Height: 5/8" Tall
 Font Depth: 1/32" Thick
 Font: DIN Medium
 Font Color: 311-307 Charcoal Grey

3. BRAILLE

Type: Clear Grade II Braille

4. DECORATIVE METAL BAR

Material: 6063 aluminum Square .25" x 10"
 Finish: #4 brushed finish (horizontal grain)
 Fastener: Thin DT tape

5. SIGN PANEL SUBSTRATE (BACKER)


Finish Size: 5" H x 10" W
 Material: 1/8" Plaskolite Non-Glare
 Clear Acrylic (P99)
 Fasten to sign panel substrate (detail 1)
 with thin DT tape

6. MOUNTING


Tape: 1/16" Thick Double Sided Foam Tape
 & RTV 108 Silicon Adhesive as needed

INSTALLATION PLACEMENT


Top of Sign: 60" AFF
 Placement: 9" OC of Tactile Characters
 From Opening of Door
 Location: Adjacent to Latch Side of Door
 Refer to CSB Installation Standards

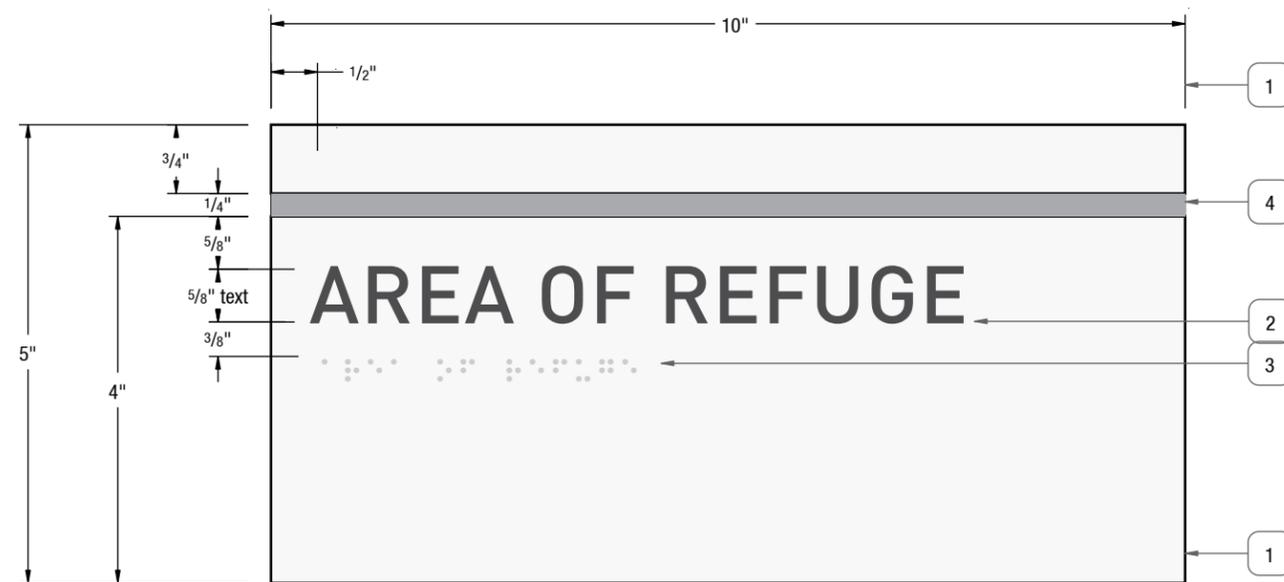


A ELEVATION - AREA OF REFUGE
 SCALE: 1:2

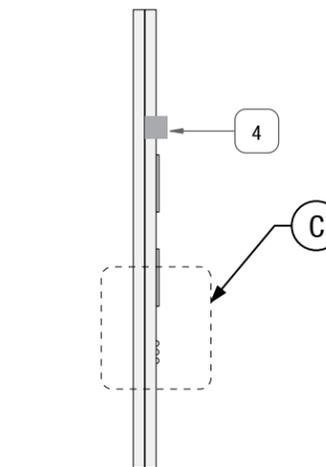


B SIDE VIEW
 SCALE: 1:2

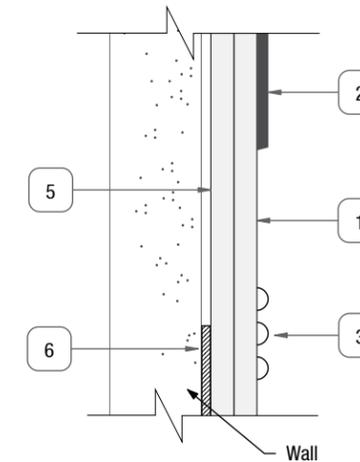

C DETAIL SECTION
 SCALE: 1:1

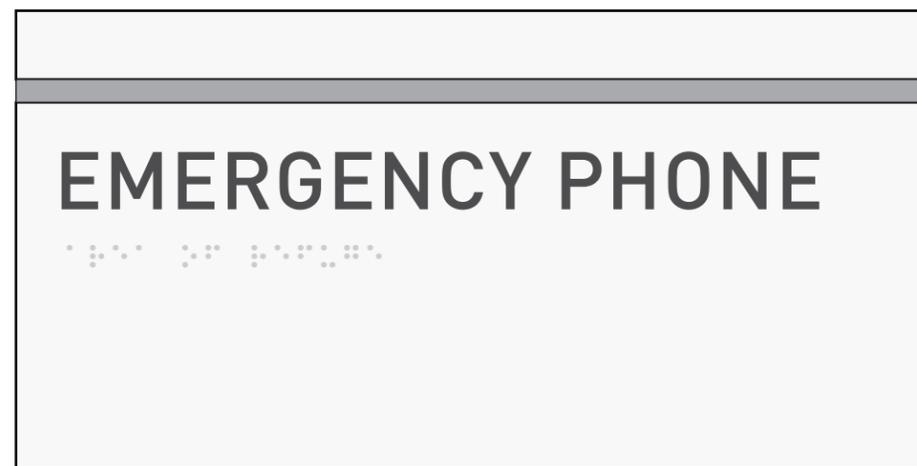

D ELEVATION - EMERGENCY PHONE
 SCALE: 1:2

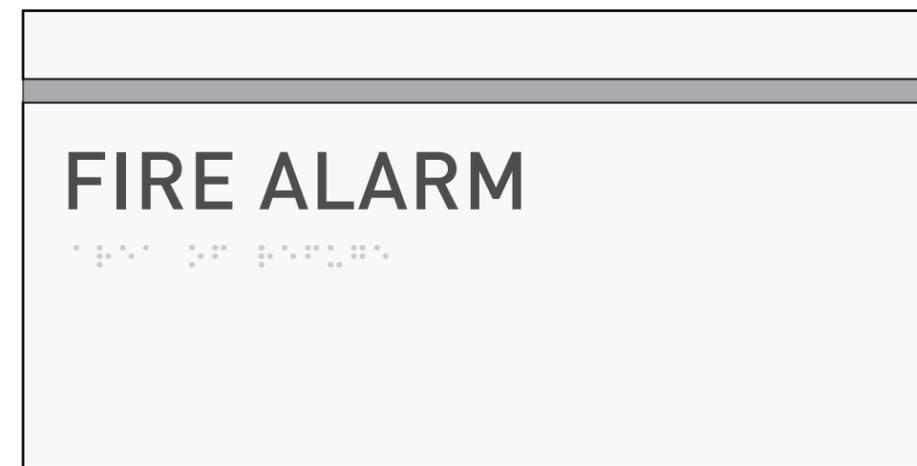

E ELEVATION - FIRE ALARM
 SCALE: 1:2

FILE PATH Q:\UCR MRB1\20180426 UCR Contract\Renderings, Submittals & PDFs\Submittals\Archive\UCR MRB1_Interior Code Signs



CONTACT
 Albuquerque / Phoenix
 P 505.888.2901 ext 109
 F 505.888.2902
 csbsigns.com

DRAWN BY
 Lawrence Spingola
 Lawrence Spingola@csbsigns.com
 This artwork and design is owned by Century Sign Builders unless expressly stated. Use of this document or the design shown here without permission is prohibited.

CLIENT / PROJECT
 Client / GC: Hensel Phelps
 Project: University of California, Riverside - MRB1

APPROVAL REQUIRED FOR PRODUCTION

SIGNATURE / DATE

DATE
 Modification Date: July 24, 2018 4:03 PM

SHEET TITLE
 Emergency Signs
 Design and Specification

SHEET

06

B81

Description: Wall Mounted Stair Level ID

SIGN SPECIFICATIONS

1. SIGN PANEL SUBSTRATE (FACES)

Finish Sizes:
 - .75" H x 10" W (top piece)
 - 4" H x 10" W (Bottom piece)
 Material: 1/8" Plaskolite Non-Glare
 Clear Acrylic (P99)
 Backpaint: Matthews Paint
 Backpaint: Matthews MAP-LVS202 White

2. TACTILE APPLIQUÉ

Material: Modified Acrylic
 Font Height: 5/8" and 3/4" Tall
 Font Depth: 1/32" Thick
 Font: DIN Medium
 Font Color: 311-307 Charcoal Grey

3. BRAILLE

Type: Clear Grade II Braille

4. DECORATIVE METAL BAR

Material: 6063 aluminum Square .25" x 10"
 Finish: #4 brushed finish (horizontal grain)
 Fastener: Thin DT tape

5. SIGN PANEL SUBSTRATE (BACKER)


Finish Size: 5" H x 10" W
 Material: 1/8" Plaskolite Non-Glare
 Clear Acrylic (P99)
 Fasten to sign panel substrate (detail 1)
 with thin DT tape

6. MOUNTING


Tape: 1/16" Thick Double Sided Foam Tape
 & RTV 108 Silicon Adhesive as needed

INSTALLATION PLACEMENT


Top of Sign: 60" AFF
 Placement: 9" OC of Tactile Characters
 From Opening of Door
 Location: Adjacent to Latch Side of Door
 Refer to CSB Installation Standards

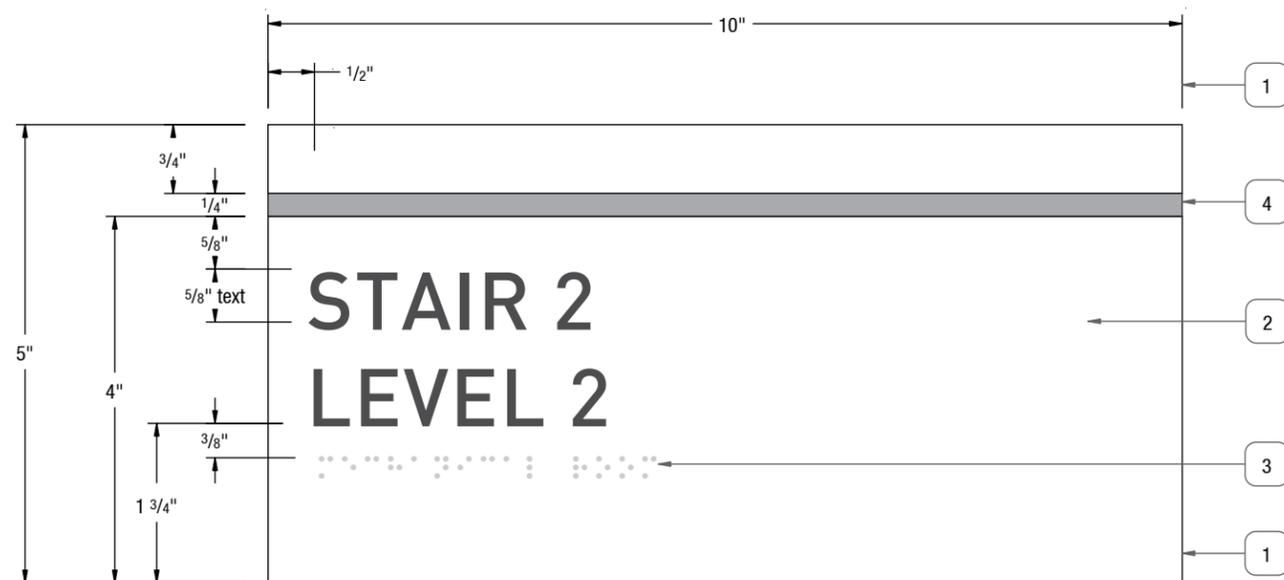


A ELEVATION - INSTALLS IN STAIRWELL
 SCALE: 1:2

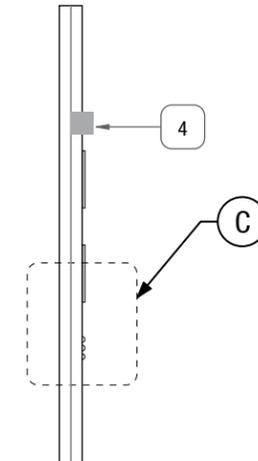


B SIDE VIEW
 SCALE: 1:2

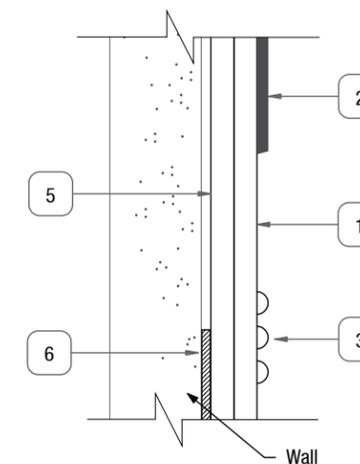

C DETAIL SECTION
 SCALE: 1:1

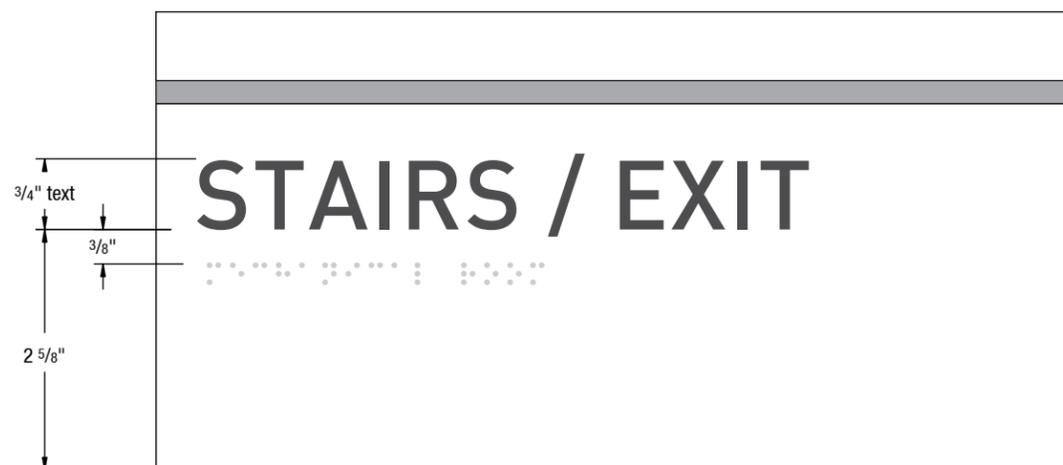

D ELEVATION - INSTALLS ON HALLWAY SIDE OF STAIR DOOR - ALL LEVELS EXEPT 1ST
 SCALE: 1:2

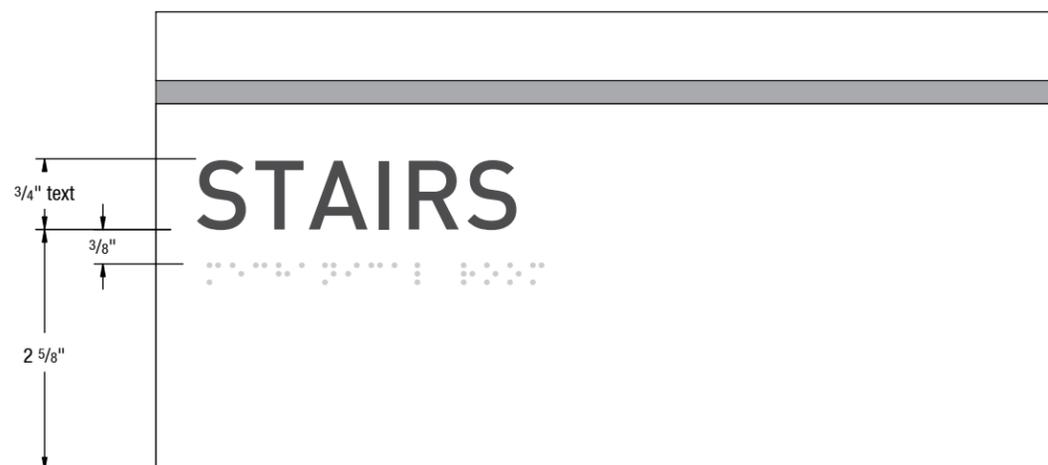

E ELEVATION - INSTALLS ON HALLWAY SIDE OF STAIR DOOR - LEVEL 1
 SCALE: 1:2

FILE PATH Q:\UCR MRB1\20180426 UCR Contract\Renderings, Submittals & PDFs\Submittals\Archive\UCR MRB1_Interior Code Signs



CONTACT
 Albuquerque / Phoenix
 P 505.888.2901 ext 109
 F 505.888.2902
 csbsigns.com

DRAWN BY
 Lawrence Spingola
 Lawrence Spingola@csbsigns.com

This artwork and design is owned by Century Sign Builders unless expressly stated. Use of this document or the design shown here without permission is prohibited.

CLIENT / PROJECT
 Client / GC: Hensel Phelps
 Project: University of California, Riverside - MRB1

APPROVAL REQUIRED FOR PRODUCTION

SIGNATURE / DATE

DATE
 Modification Date: July 24, 2018 4:03 PM

SHEET TITLE

Sign Type B81
 Stair Door and Level ID

07

SIGN SPECIFICATIONS

- 1. SIGN PANEL SUBSTRATE (FACES)**
 Finish Size: 19" x 14.25"
 Material: Plaskolite Non-Glare
 Clear Acrylic (P99)
 Thickness: 1/4"
 Backpaint: Matthews Paint
 Backpaint Color: MP13915 Neptaunian Grey

- 2. SIGN GRAPHICS**
 Direct to substrate print
 Front print: Yes
 Color Match:
 - Rowmark ADA Charcoal Grey (PMS 7 Black CV)
 - Note: Color matching accurate 7/19/2018


- 3. BRAILLE**
 Type: Clear Grade II Braille

- 4. MOUNTING**
 Tape: 1/16" Thick Double Sided Foam Tape
 & RTV 108 Silicon Adhesive as needed


- INSTALLATION PLACEMENT**
 Top of Sign: 60" AFF to center of sign

Questions / Notes

1. Verify Address
 2. Individual evac map designs to follow

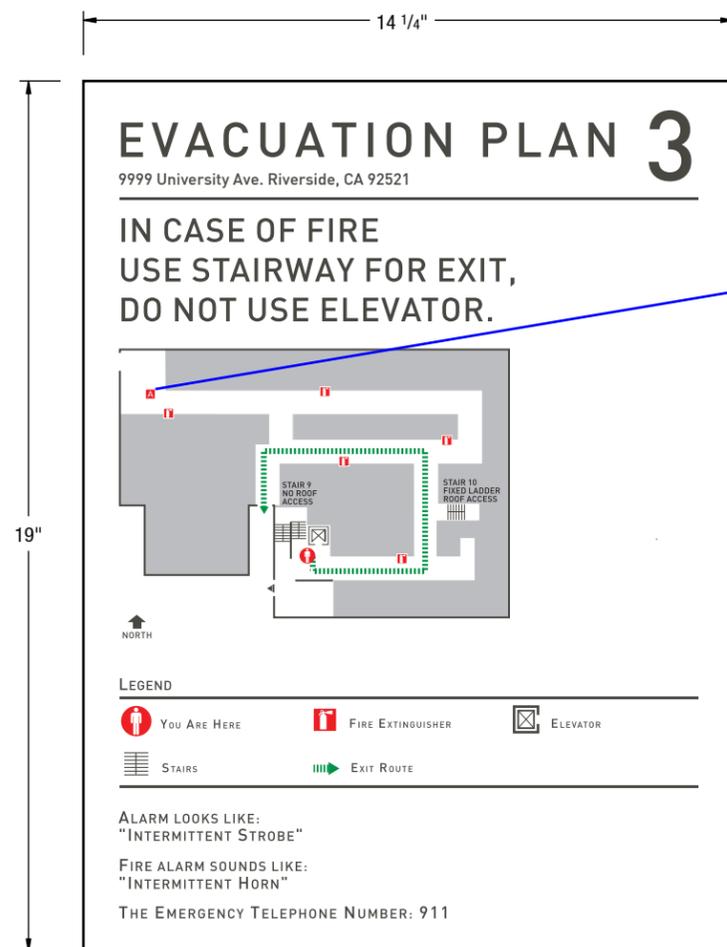

Provide "A" in Legend

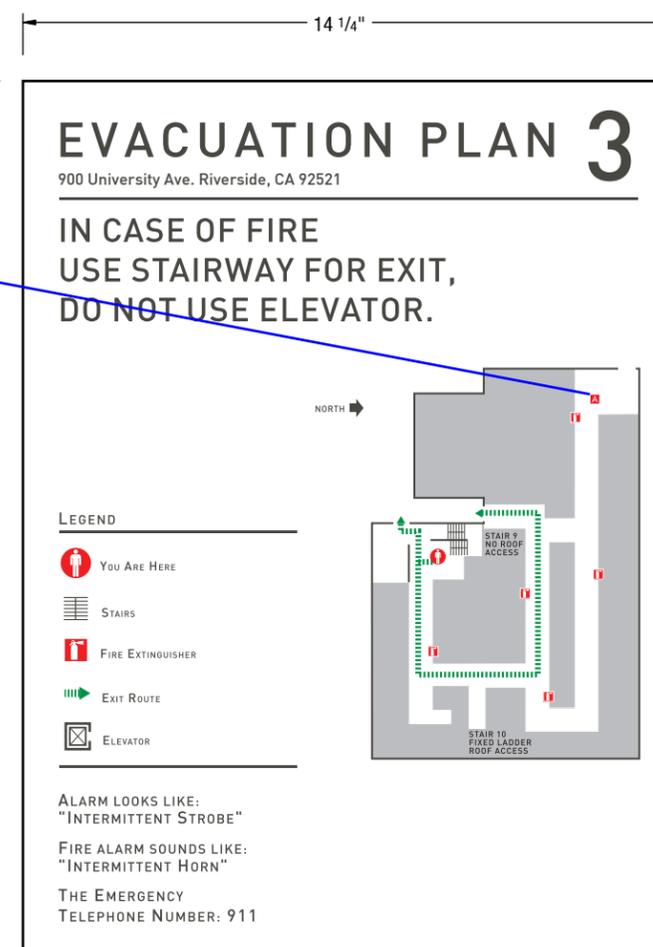

A EVACULATION MAP - HORIZONTAL LAYOUT
 SCALE 3"=1'

B EVACULATION MAP - HORIZONTAL LAYOUT
 SCALE 3"=1'

tk1sc

- NO EXCEPTIONS NOTED REJECTED RESUBMIT AS REQUIRED
 FURNISH AS CORRECTED REVISE & RESUBMIT

BY smiller DATE 8/2/2018

This review is only for general conformance with the design concept of the project and general compliance with the information included in the Contract Documents. Any action shown is subject to the requirements of the drawings and specifications. No action shown here shall in anyway relieve the contractor of the responsibility of providing complete and operating systems as shown on the Contract Documents. Contractor is responsible for correlating and confirming dimensions at the job site; choice of fabrication processes and techniques of construction; coordination of his work with that of other trades; and performing the work in a safe and satisfactory manner.

FILE PATH Q:\UCR MRB1\20180426 UCR Contract\Renderings, Submittals & PDFs\Submittals\Archive\UCR MRB1_Interior Code Signs

| CONTACT | DRAWN BY | CLIENT / PROJECT | DATE | SHEET TITLE | SHEET |
|---|--|--|--|---------------------------------|-------|
| Albuquerque / Phoenix P 505.888.2901 ext 109 F 505.888.2902 csbsigns.com | Lawrence Spingola Lawrence Spingola@csbsigns.com <small>This artwork and design is owned by Century Sign Builders unless expressly stated. Use of this document or the design shown here without permission is prohibited.</small> | Client / GC: Hensel Phelps Project: University of California, Riverside - MRB1 APPROVAL REQUIRED FOR PRODUCTION | Modification Date: July 24, 2018 4:03 PM SIGNATURE / DATE | Sign Type B75 Evacuation Map | 08 |



FS

Sign Type: In Case of Fire...
Description: Elevator Panel Sign

SIGN SPECIFICATIONS

1. SIGN PANEL SUBSTRATE (FACES)

Finish Sizes: 11.5" x 7.75"
Material: Plaskolite Non-Glare
Clear Acrylic (P99)
Thickness: 1/4"
Backpaint: Matthews Paint
Backpaint: Matthews MAP-LVS202 White

2. TACTILE APPLIQUÉ

Material: Modified Acrylic
Font Height: 5/8" Tall
Font Depth: 1/32" Thick
Font: DIN Medium
Font Color: 311-307 Charcoal Grey

3. BRAILLE

Type: Clear Grade II Braille

4. MOUNTING


Tape: 1/16" Thick Double Sided Foam Tape
& RTV 108 Silicon Adhesive as needed

INSTALLATION PLACEMENT


Top of Sign: 60" AFF
Placement: Center above elevator call button
Refer to CSB Installation Standards



A SIGN FACE ELEVATION
SCALE: 1:2

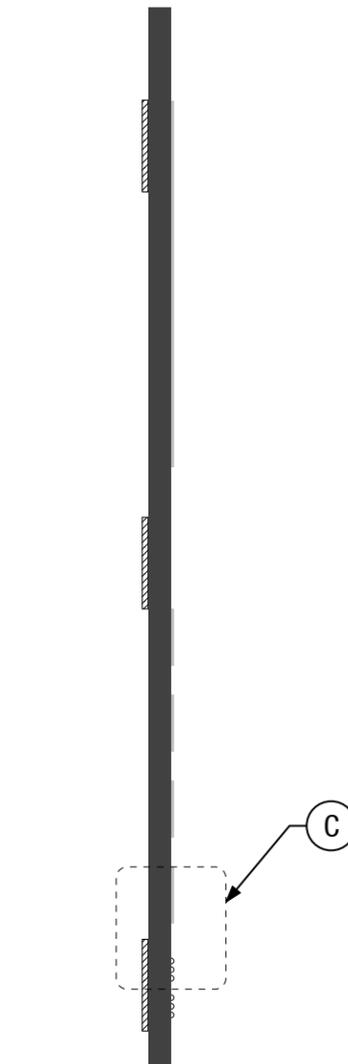

B SIDE VIEW
SCALE: 1:2

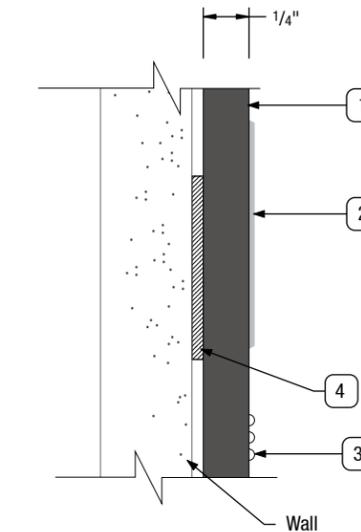

C DETAIL SECTION
SCALE: 2:1

FILE PATH Q:\UCR MRB1\20180426 UCR Contract\Renderings, Submittals & PDFs\Submittals\Archive\UCR MRB1_Interior Code Signs



CONTACT
Albuquerque / Phoenix
P 505.888.2901 ext 109
F 505.888.2902
csbsigns.com

DRAWN BY
Lawrence Spingola
Lawrence.Spingola@csbsigns.com
This artwork and design is owned by Century Sign Builders unless expressly stated. Use of this document or the design shown here without permission is prohibited.

CLIENT / PROJECT
Client / GC: Hensel Phelps
Project: University of California, Riverside - MRB1

APPROVAL REQUIRED FOR PRODUCTION

SIGNATURE / DATE


DATE
Modification Date: July 24, 2018 4:03 PM

SHEET TITLE


Sign Type FS
In Case of Fire Elevator Sign

SHEET


09

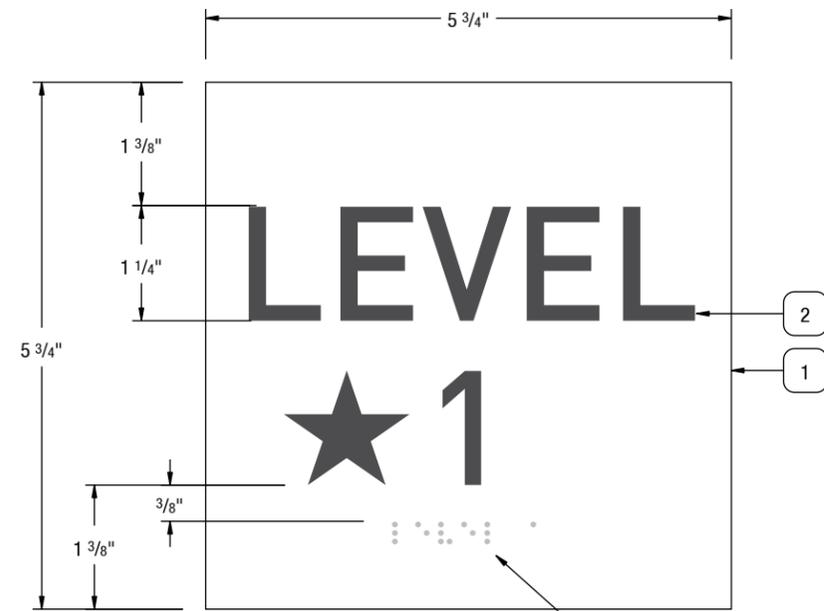

A SIGN FACE ELEVATION
SCALE: 1:2

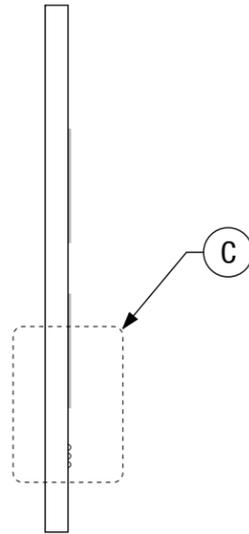

B SIDE VIEW
SCALE: 1:2

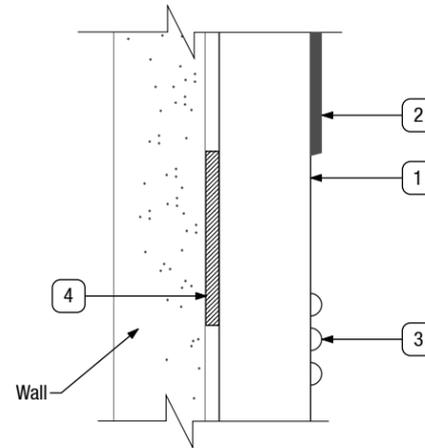

C DETAIL SECTION
SCALE: 2:1



D VARIATIONS
SCALE: 1:5

"Star" on sign indicates exit level.

Question: are all elevators on Basement level to be identified as exit level?

EJS

Sign Type: Elevator Jamb Sign

SIGN SPECIFICATIONS

- 1. SIGN PANEL SUBSTRATE**
Finish Size: 5.75" H x 5.75" W
Material: 1/4" Plaskolite Non-Glare Clear Acrylic (P99)
Backpaint: Matthews MAP-LVS202 White
- 2. TACTILE APPLIQUÉ**
Material/Thickness: 1/32" Modified Acrylic
Font Height: 1 1/4"
Font Line Spacing: 150%
Fonts:
- DIN Medium
Font Color: 311-307 Charcoal Grey
- 3. BRAILLE**
Type: Clear Grade II Braille
- 4. MOUNTING**
Tape: 1/16" Thick Double Sided Foam Tape & RTV 108 Silicon Adhesive as needed

Questions

1. Verify lower level naming

FILE PATH Q:\UCR MRB1\20180426 UCR Contract\Renderings, Submittals & PDFs\Submittals\Archive\UCR MRB1_Interior Code Signs




| CONTACT | DRAWN BY | CLIENT / PROJECT | DATE | SHEET TITLE | SHEET |
|---|--|--|--|-------------------------------------|-----------|
| Albuquerque / Phoenix P 505.888.2901 ext 109 F 505.888.2902 csbsigns.com | Lawrence Spingola Lawrence.Spingola@csbsigns.com <small>This artwork and design is owned by Century Sign Builders unless expressly stated. Use of this document or the design shown here without permission is prohibited.</small> | Client / GC: Hensel Phelps Project: University of California, Riverside - MRB1 APPROVAL REQUIRED FOR PRODUCTION | Modification Date: July 24, 2018 4:03 PM SIGNATURE / DATE | Sign Type EJS Elevator Jamb Sign | 10 |

STAR OF LIFE

Sign Type: Elevator Sign - Star of Life

SIGN SPECIFICATIONS


- 1. SIGN PANEL SUBSTRATE**
 Finish Size: 5.75" H x 5.75" W
 Material: 1/4" Plaskolite Non-Glare
 Clear Acrylic (P99)
 Backpaint: Matthews MAP-LVS202 White
- 2. GRAPHICS**
 Direct Print - Front Applied
- 3. BRAILLE**
 N/A
- 4. MOUNTING**
 Tape: 1/16" Thick Double Sided Foam Tape
 & RTV 108 Silicon Adhesive as needed

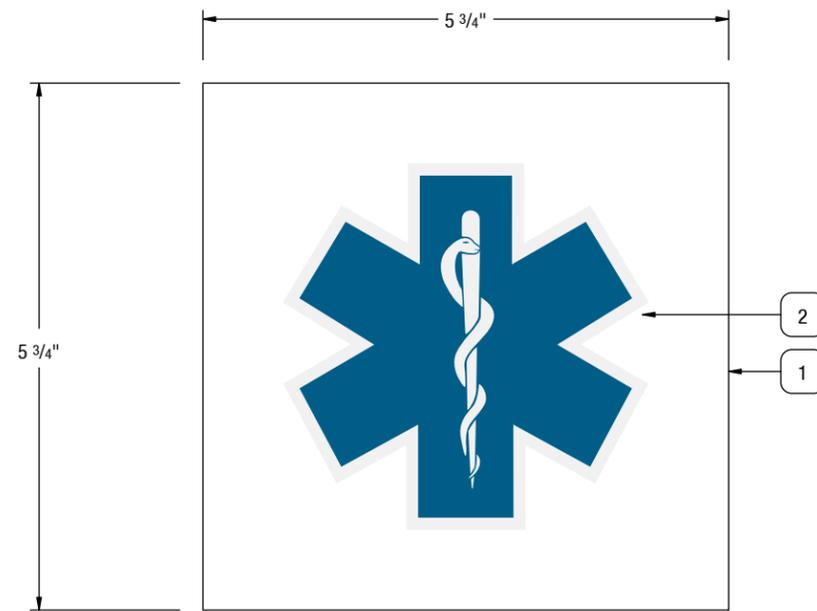

A SIGN FACE ELEVATION
SCALE: 1:2



B SIDE VIEW
SCALE: 1:2

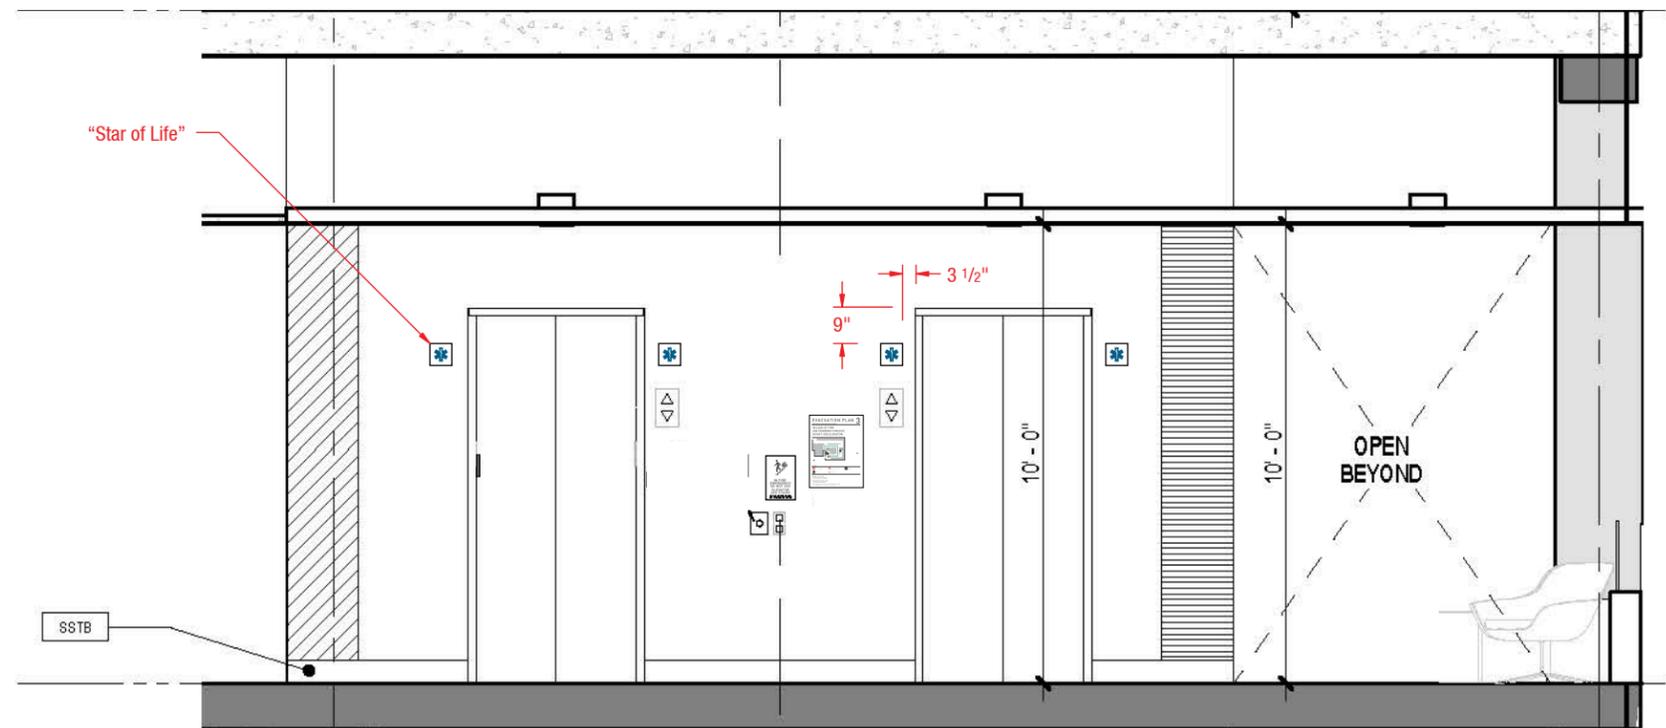

C INSTALLATION
SCALE: 1/4" = 1'

FILE PATH Q:\UCR MRB1\20180426 UCR Contract\Renderings, Submittals & PDFs\Submittals\Archive\UCR MRB1_Interior Code Signs

| CONTACT | DRAWN BY | CLIENT / PROJECT | DATE | SHEET TITLE | SHEET |
|---|--|--|--|-------------------------|-------|
| Albuquerque / Phoenix P 505.888.2901 ext 109 F 505.888.2902 csbsigns.com | Lawrence Spingola Lawrence Spingola@csbsigns.com <small>This artwork and design is owned by Century Sign Builders unless expressly stated. Use of this document or the design shown here without permission is prohibited.</small> | Client / GC: Hensel Phelps Project: University of California, Riverside - MRB1 APPROVAL REQUIRED FOR PRODUCTION | Modification Date: July 24, 2018 4:03 PM | Sign Type: Star of Life | 11 |
| | | SIGNATURE / DATE | | | |



B92

Sign Type: Wall Mounted Accessible ID

SIGN SPECIFICATIONS

1. SIGN PANEL SUBSTRATE

Finish Size: 5.75" H x 5.75" W
 Material: 1/4" Plaskolite Non-Glare
 Clear Acrylic (P99)
 Backpaint: Matthews MAP-LVS202 White

2. TACTILE APPLIQUÉ


Material/Thickness: 1/32" Modified Acrylic
 Color: 311-307 Charcoal Grey

3. BRAILLE


None

4. MOUNTING


Tape: 1/16" Thick Double Sided Foam Tape
 & RTV 108 Silicon Adhesive as needed

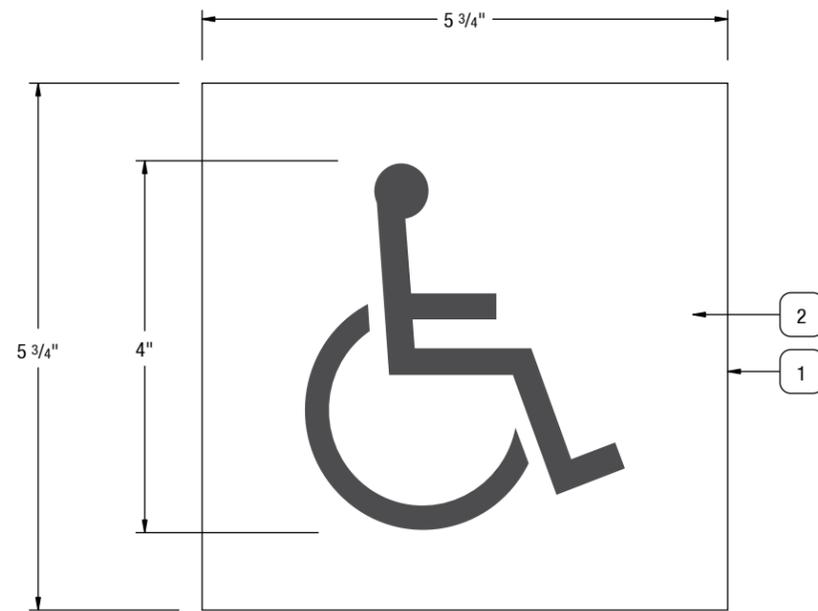

A SIGN FACE ELEVATION
 SCALE: 1:2

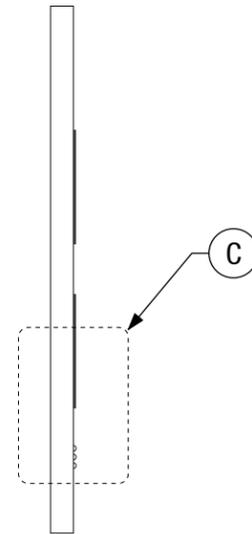

B SIDE VIEW
 SCALE: 1:2

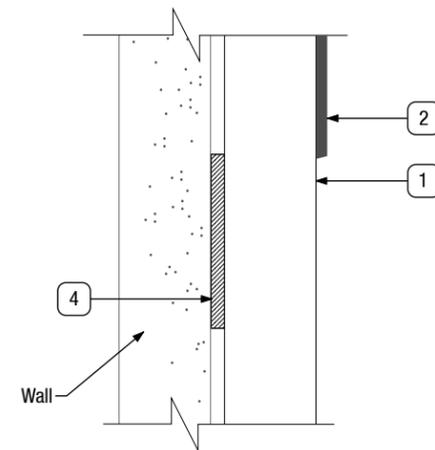

C DETAIL SECTION
 SCALE: 2:1

FILE PATH Q:\UCR MRB1\20180426 UCR Contract\Renderings, Submittals & PDFs\Submittals\Archive\UCR MRB1_Interior Code Signs

| CONTACT | DRAWN BY | CLIENT / PROJECT | DATE | SHEET TITLE | SHEET |
|---|--|--|--|---------------------------------|-------|
| Albuquerque / Phoenix P 505.888.2901 ext 109 F 505.888.2902 csbsigns.com | Lawrence Spingola Lawrence.Spingola@csbsigns.com <small>This artwork and design is owned by Century Sign Builders unless expressly stated. Use of this document or the design shown here without permission is prohibited.</small> | Client / GC: Hensel Phelps Project: University of California, Riverside - MRB1 APPROVAL REQUIRED FOR PRODUCTION | Modification Date: July 24, 2018 4:03 PM SIGNATURE / DATE | Sign Type B92 AAccessible ID | 12 |



B70

Sign Type: Room ID
Description: ADA Compliant Room Sign

SIGN SPECIFICATIONS

1. SIGN PANEL SUBSTRATE (FACES)

Finish Sizes:
- 2" H x 10" W (top piece)
- 4" H x 10" W (Bottom piece)
Material: 1/8" Plaskolite Non-Glare
Clear Acrylic (P99)
Backpaint: Matthews MAP-LVS202 White

2. TACTILE APPLIQUÉ

Material: Modified Acrylic
Font Height: 5/8" Tall
Font Depth: 1/32" Thick
Font: DIN Medium
Font Color: 311-307 Charcoal Grey

3. BRAILLE

Type: Clear Grade II Braille

4. DECORATIVE METAL BAR

Material: 6063 aluminum Square .25" x 10"
Finish: #4 brushed finish (horizontal grain)
Fastener: Thin DT tape

5. SIGN PANEL SUBSTRATE (BACKER)


Finish Size: 6 1/4" H x 10" W
Material: 1/8" Plaskolite Non-Glare
Clear Acrylic (P99)
Fasten to sign panel substrate (detail 1)
with thin DT tape

6. MOUNTING


Tape: 1/16" Thick Double Sided Foam Tape
& RTV 108 Silicon Adhesive as needed

INSTALLATION PLACEMENT


Top of Sign: 60" AFF
Placement: 9" OC of Tactile Characters
From Opening of Door
Location: Adjacent to Latch Side of Door
Refer to CSB Installation Standards

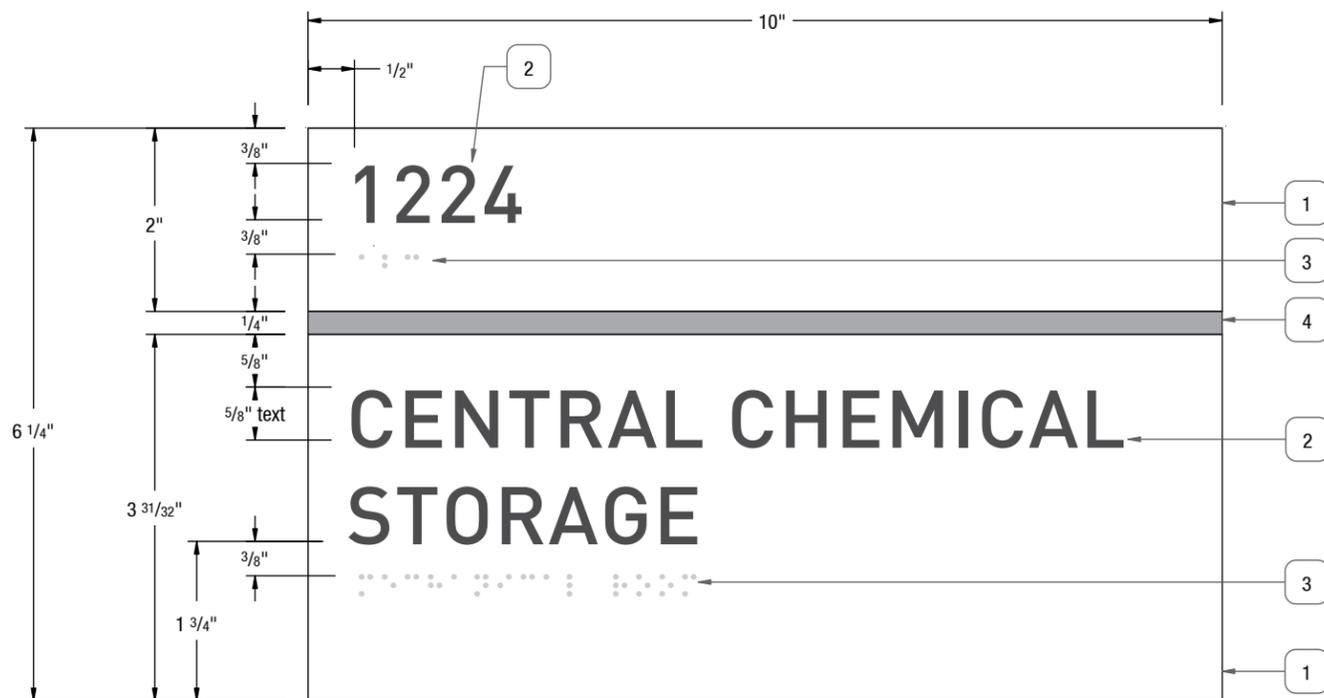


A ELEVATION
SCALE: 1:2

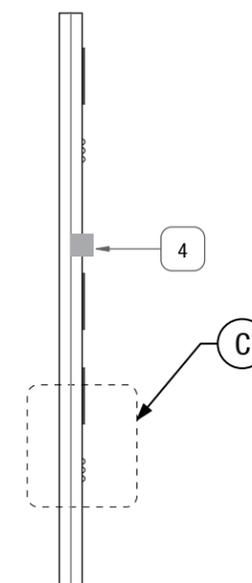

B SIDE VIEW
SCALE: 1:2

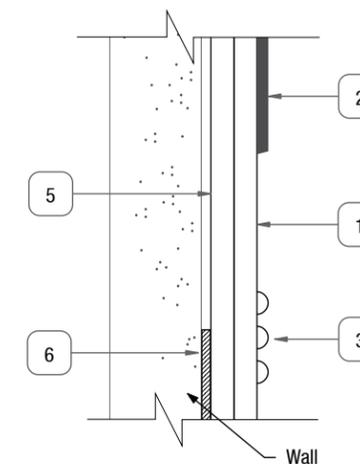

C DETAIL SECTION
SCALE: 1:1

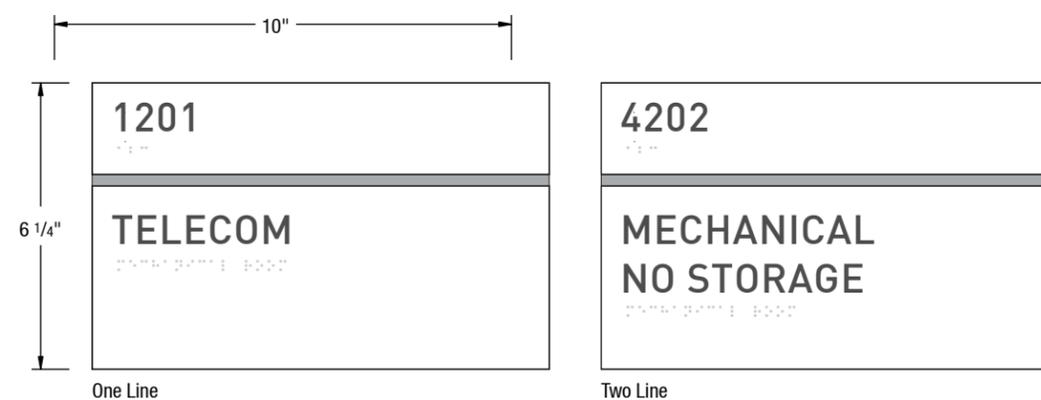

D VARIATIONS
SCALE: 1:4

FILE PATH Q:\UCR MRB1\20180426 UCR Contract\Renderings, Submittals & PDFs\Submittals\Archive\UCR MRB1_Interior Code Signs



CONTACT
Albuquerque / Phoenix
P 505.888.2901 ext 109
F 505.888.2902
csbsigns.com

DRAWN BY
Lawrence Spingola
Lawrence.Spingola@csbsigns.com

This artwork and design is owned by Century Sign Builders unless expressly stated. Use of this document or the design shown here without permission is prohibited.

CLIENT / PROJECT
Client / GC: Hensel Phelps
Project: University of California, Riverside - MRB1

APPROVAL REQUIRED FOR PRODUCTION

SIGNATURE / DATE


DATE
Modification Date: July 24, 2018 4:03 PM

SHEET TITLE


Sign Type B70
Room ID

SHEET


13

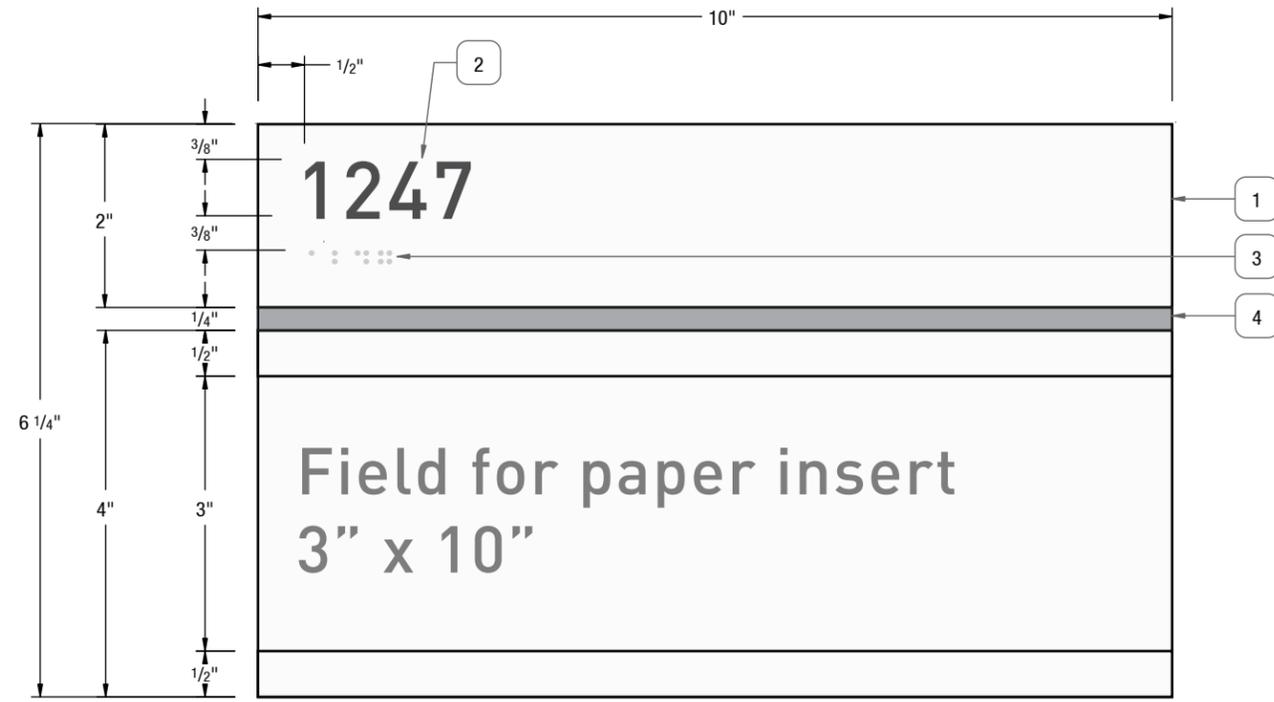


A ELEVATION
SCALE: 1:2

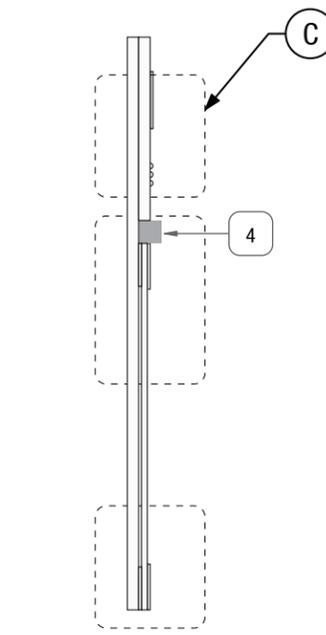


B SIDE VIEW
SCALE: 1:2

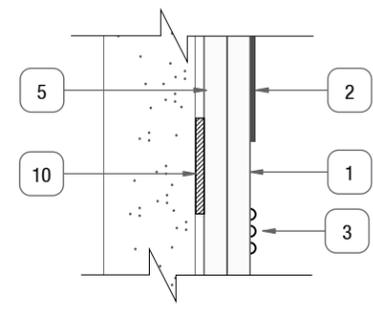


C DETAIL SECTION
SCALE: 1:1

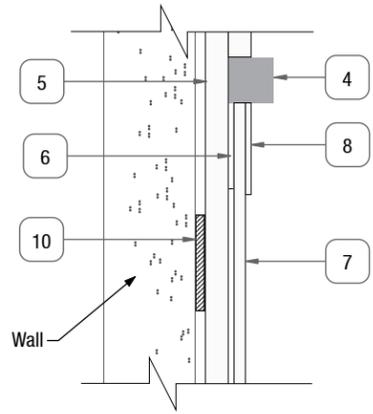


D DETAIL SECTION
SCALE: 1:1

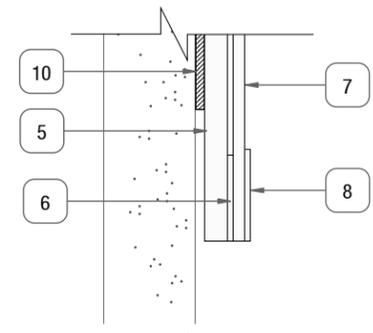

E DETAIL SECTION
SCALE: 1:1

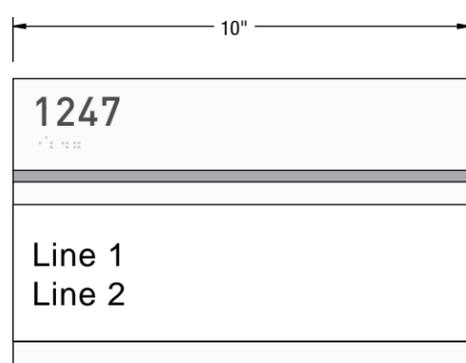

F VIEW WITH PAPER INSERT
SCALE: 1:4

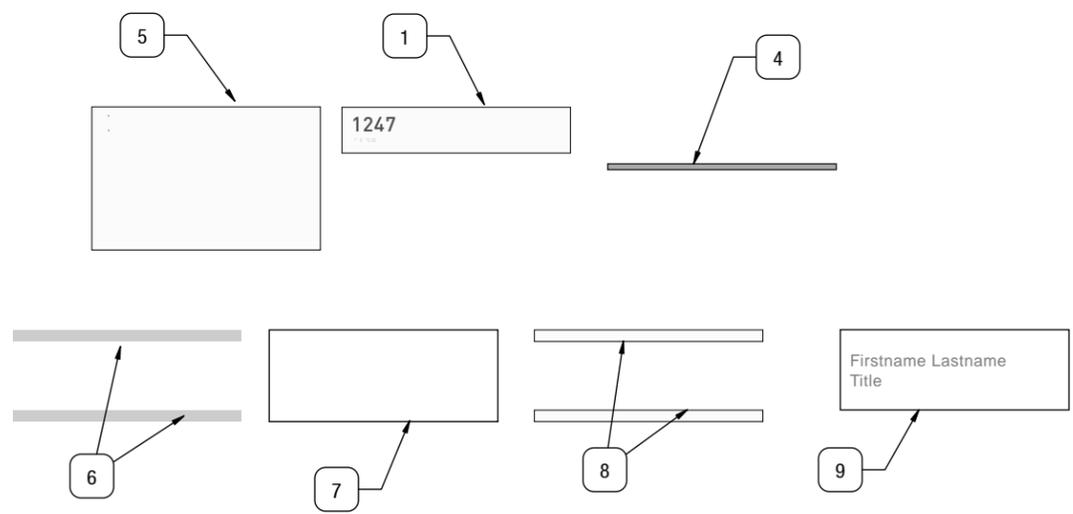

G COMPONENTS
SCALE: 1 1/2"=1'

B31

Sign Type: ADA Room Sign
Description: Wall Mounted Paper Holder Room ID

SIGN SPECIFICATIONS

- 1. SIGN PANEL SUBSTRATE (FACE)**
Finish Sizes:
- 2" H x 10" W (top piece)
Material: 1/8" Plaskolite Non-Glare Clear Acrylic (P99)
Backpaint: Matthews MAP-LVS202 White
 - 2. TACTILE APPLIQUÉ**
Material: Modified Acrylic
Font Height: 5/8" Tall
Font Depth: 1/32" Thick
Font: DIN Medium
Font Color: 311-305 Light Grey
 - 3. BRAILLE**
Type: Clear Grade II Braille
 - 4. DECORATIVE METAL BAR**
Material: 6063 aluminum Square .25" x 10"
Finish: #4 brushed finish (horizontal grain)
Fastener: Thin DT tape
 - 5. SIGN PANEL SUBSTRATE (BACKER)**
Finish Size: 6 1/4" H x 10" W
Material: 1/8" Clear Acrylic
 - 6. SPACERS**
Finish Size: 0.46875" H x 10" W (x2)
Material: 1/32" UM Clear 312-101
 - 7. LENS**
Finish Size: 4" H x 10" W
Material: 1/8" Plaskolite Non-Glare Clear Acrylic (P99)
 - 8. TRIM STRIPS**
Finish Size: 2" H x 10" W
Material: 1/32" UM White 312-201
 - 9. PAPER INSERT**
Finish Size: 3" H x 10" W
Material: Inkjet / laser printer paper
Font: 48pt. Arial
 - 10. ADHESIVE / TAPE FOR COMPONENTS**
Tape: Thin DT tape
 - 11. MOUNTING**
Tape: 1/16" Thick Double Sided Foam Tape & RTV 108 Silicon Adhesive as needed
- INSTALLATION PLACEMENT**
Top of Sign: 60" AFF
Placement: 9" OC of Tactile Characters From Opening of Door
Location: Adjacent to Latch Side of Door
Refer to CSB Installation Standards


FILE PATH Q:\UCR MRB1\20180426 UCR Contract\Renderings, Submittals & PDFs\Submittals\Archive\UCR MRB1_Interior Code Signs

| CONTACT | DRAWN BY | CLIENT / PROJECT | DATE | SHEET TITLE | SHEET |
|---|---|---|--|---|-------|
| Albuquerque / Phoenix P 505.888.2901 ext 109 F 505.888.2902 csbsigns.com | Lawrence Spingola Lawrence.Spingola@csbsigns.com This artwork and design is owned by Century Sign Builders unless expressly stated. Use of this document or the design shown here without permission is prohibited. | Client / GC: Hensel Phelps Project: University of California, Riverside - MRB1 | Modification Date: July 24, 2018 4:03 PM | Sign Type B31 Wall Mounted Paper Holder Room ID | 14 |
| | | APPROVAL REQUIRED FOR PRODUCTION | SIGNATURE / DATE | | |




To remove a paper insert:

1. Insert a “sticky note” between the window and the paper insert. Press down on top of the “sticky note” inside the border of the window.

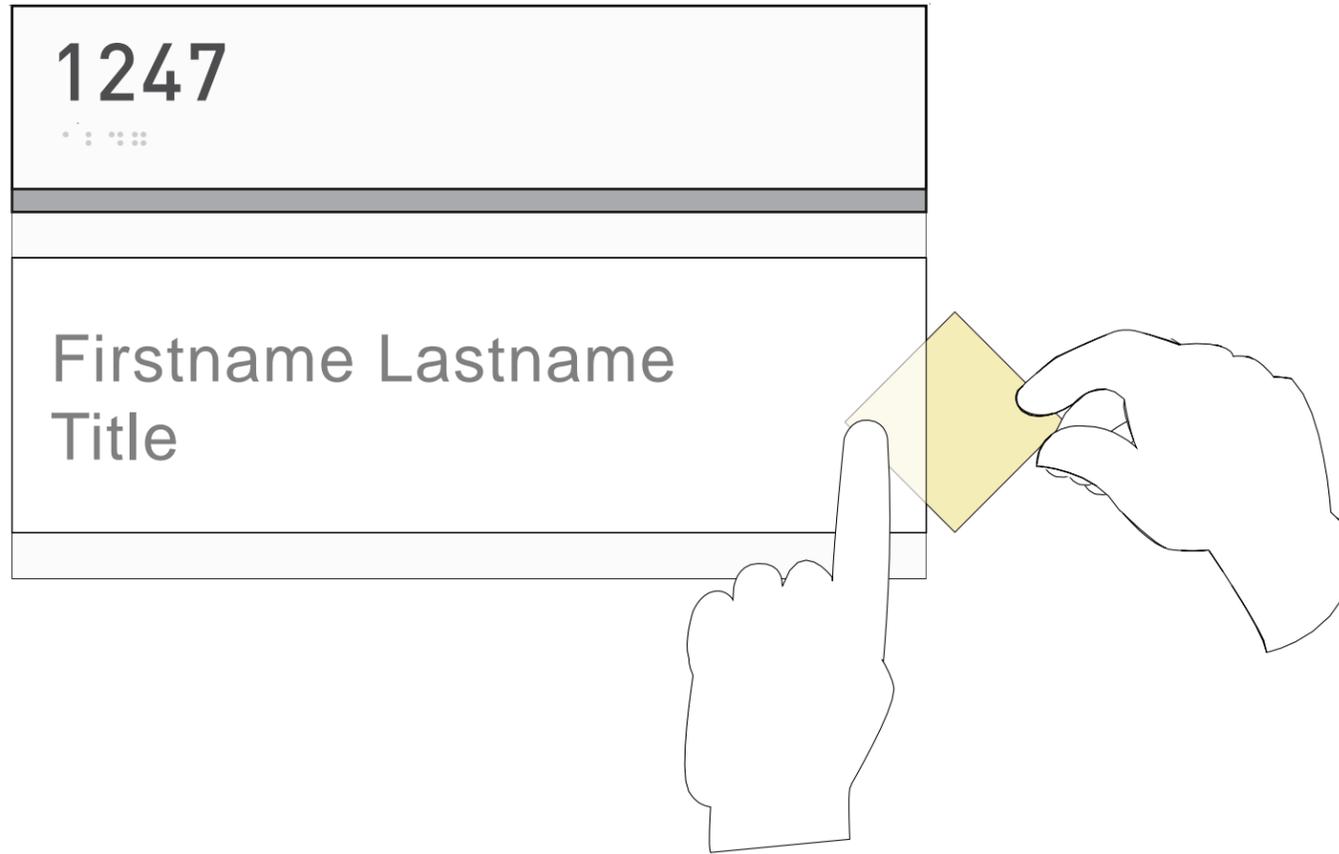

2. Once the “sticky note” adheres to the paper insert, remove your finger and pull the “Sticky note” back to the right.

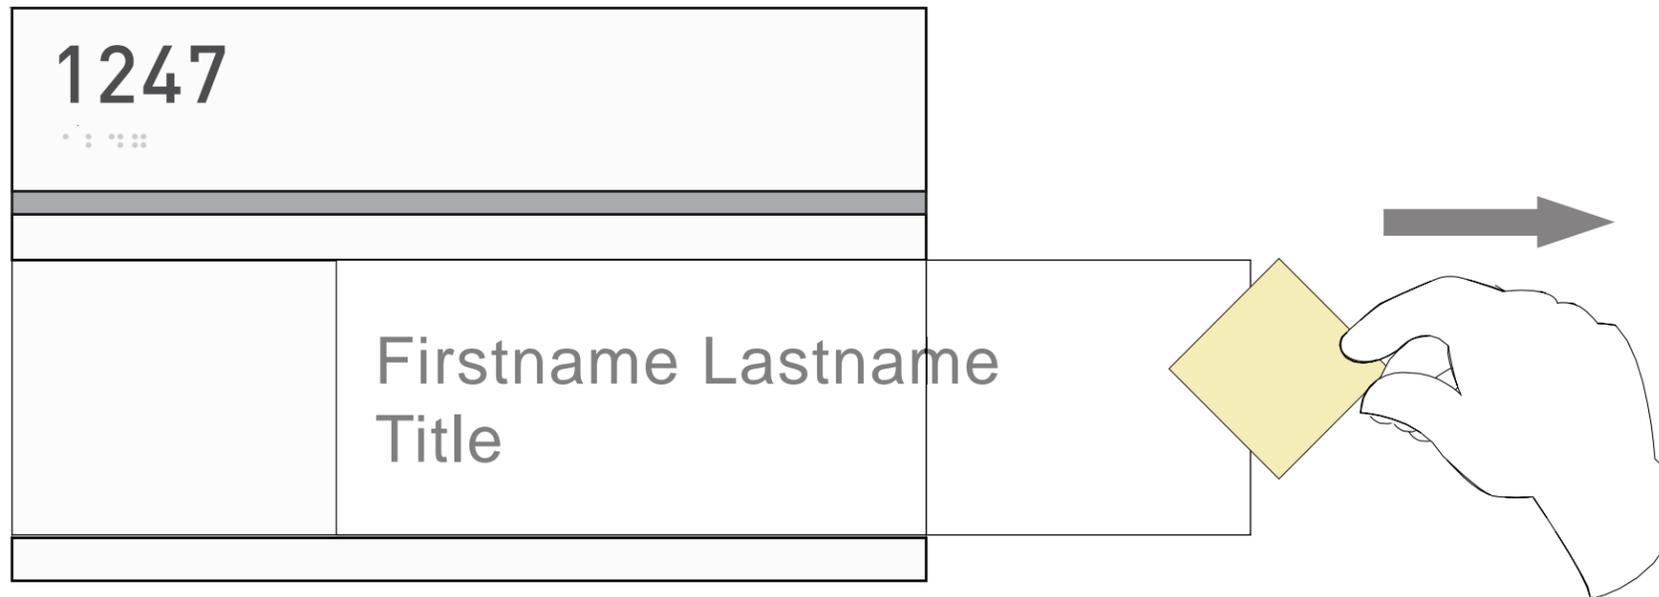

B31

Sign Type: ADA Room Sign
Description: Wall Mounted Paper Holder Room ID

SIGN SPECIFICATIONS

1. SIGN PANEL SUBSTRATE (FACE)

Finish Sizes:
- 2" H x 10" W (top piece)
Material: 1/8" Plaskolite Non-Glare Clear Acrylic (P99)
Backpaint: Matthews Paint
Backpaint Color: MP13915 Neptunian Grey

2. TACTILE APPLIQUÉ

Material: Modified Acrylic
Font Height: 5/8" Tall
Font Depth: 1/32" Thick
Font: DIN Medium
Font Color: 311-305 Light Grey

3. BRAILLE

Type: Clear Grade II Braille

4. DECORATIVE METAL BAR

Material: 6063 aluminum Square .25" x 10"
Finish: #4 brushed finish (horizontal grain)
Fastener: Thin DT tape

5. SIGN PANEL SUBSTRATE (BACKER)

Finish Size: 6 1/4" H x 10" W
Material: 1/8" Clear Acrylic
Backpaint: Matthews Paint
Backpaint Color: MP13915 Neptunian Grey

6. SPACERS

Finish Size: 0.46875" H x 10" W (x2)
Material: 1/32" UM Clear 312-101

7. LENS

Finish Size: 4" H x 10" W
Material: 1/8" Plaskolite Non-Glare Clear Acrylic (P99)

8. TRIM STRIPS

Finish Size: 2" H x 10" W
Material: 1/32" UM Clear 312-101
Backpaint: Matthews Paint
Backpaint Color: MP13915 Neptunian Grey

9. PAPER INSERT

Finish Size: 3" H x 10" W
Material: Inkjet / laser printer paper
Font: 48pt. Arial

10. ADHESIVE / TAPE FOR COMPONENTS

Tape: Thin DT tape

11. MOUNTING

Tape: 1/16" Thick Double Sided Foam Tape & RTV 108 Silicon Adhesive as needed

INSTALLATION PLACEMENT

Top of Sign: 60" AFF
Placement: 9" OC of Tactile Characters From Opening of Door
Location: Adjacent to Latch Side of Door
Refer to CSB Installation Standards

FILE PATH Q:\UCR MRB1\20180426 UCR Contract\Renderings, Submittals & PDFs\Submittals\Archive\UCR MRB1_Interior Code Signs



| CONTACT | DRAWN BY | CLIENT / PROJECT | DATE | SHEET TITLE | SHEET |
|---|---|--|--|---|-------|
| Albuquerque / Phoenix P 505.888.2901 ext 109 F 505.888.2902 csbsigns.com | Lawrence Spingola Lawrence Spingola@csbsigns.com This artwork and design is owned by Century Sign Builders unless expressly stated. Use of this document or the design shown here without permission is prohibited. | Client / GC: Hensel Phelps Project: University of California, Riverside - MRB1 APPROVAL REQUIRED FOR PRODUCTION | Modification Date: July 24, 2018 4:03 PM SIGNATURE / DATE | Sign Type B31 Wall Mounted Paper Holder Room ID | 15 |

B36

Sign Type: Wall Mounted Restroom ID
Description: ADA Compliant Restroom Sign

SIGN SPECIFICATIONS

1. SIGN PANEL SUBSTRATE (FACES)

Finish Sizes:
- 2" H x 8" W (top piece)
- 6" H x 8" W (Bottom piece)
Material: 1/8" Plaskolite Non-Glare
Clear Acrylic (P99)
Backpaint: Matthews MAP-LVS202 White

2. TACTILE APPLIQUÉ

Material: Modified Acrylic
Font Height: 5/8" Tall
Font Depth: 1/32" Thick
Font: DIN Medium
Font Color: 311-307 Charcoal Grey

3. BRAILLE

Type: Clear Grade II Braille

4. DECORATIVE METAL BAR

Material: 6063 aluminum Square .25" x 10"
Finish: #4 brushed finish (horizontal grain)
Fastener: Thin DT tape

5. SIGN PANEL SUBSTRATE (BACKER)


Finish Size: 8 1/4" H x 8" W
Material: 1/8" Plaskolite Non-Glare
Clear Acrylic (P99)
Fasten to sign panel substrate (detail 1)
with thin DT tape

6. MOUNTING


Tape: 1/16" Thick Double Sided Foam Tape
& RTV 108 Silicon Adhesive as needed

INSTALLATION PLACEMENT


Top of Sign: 60" AFF
Placement: 9" OC of Tactile Characters
From Opening of Door
Location: Adjacent to Latch Side of Door
Refer to CSB Installation Standards

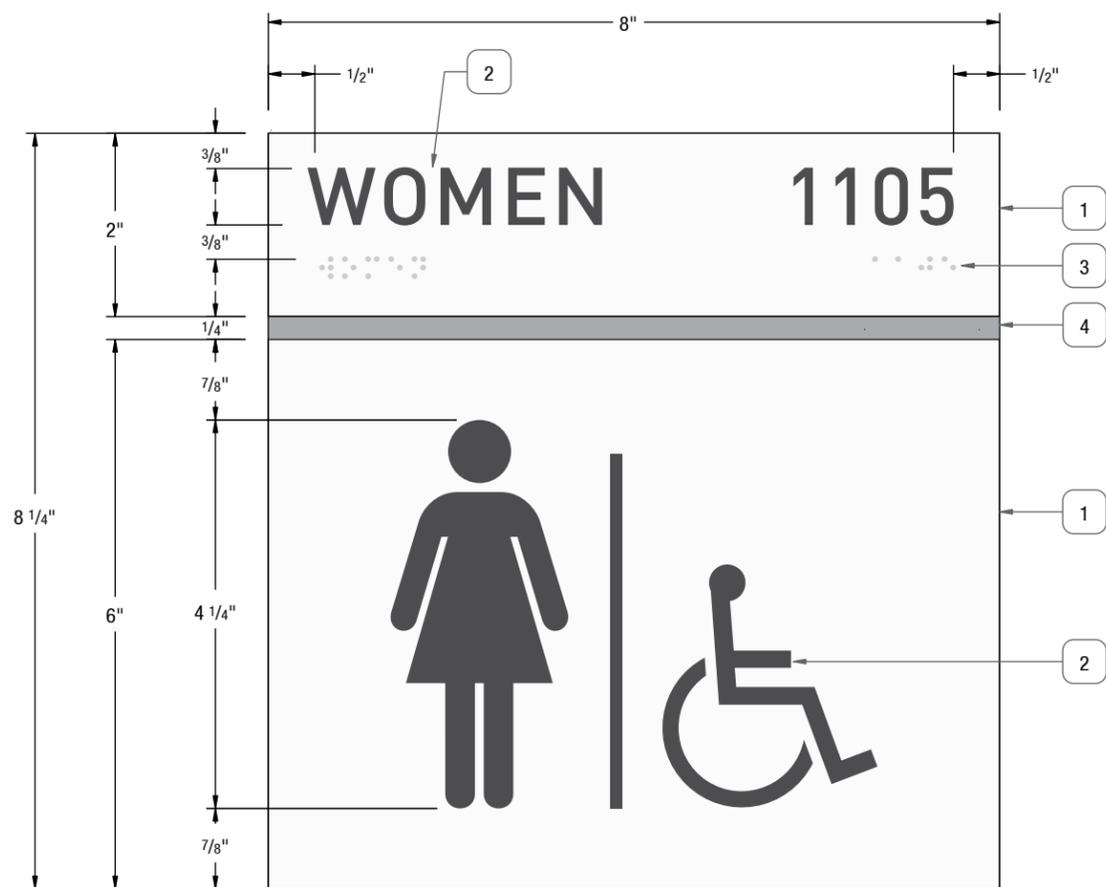


A ELEVATION
SCALE: 1:2

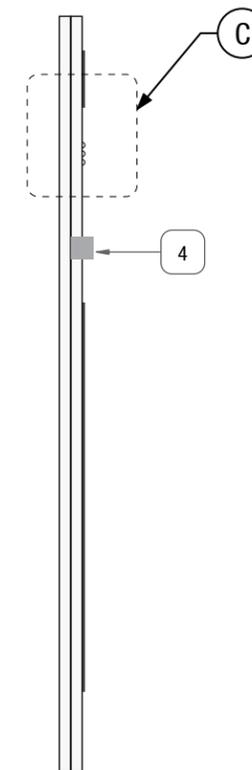

B SIDE VIEW
SCALE: 1:2

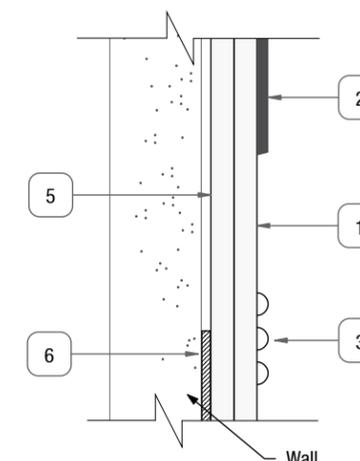

C DETAIL SECTION
SCALE: 1:2

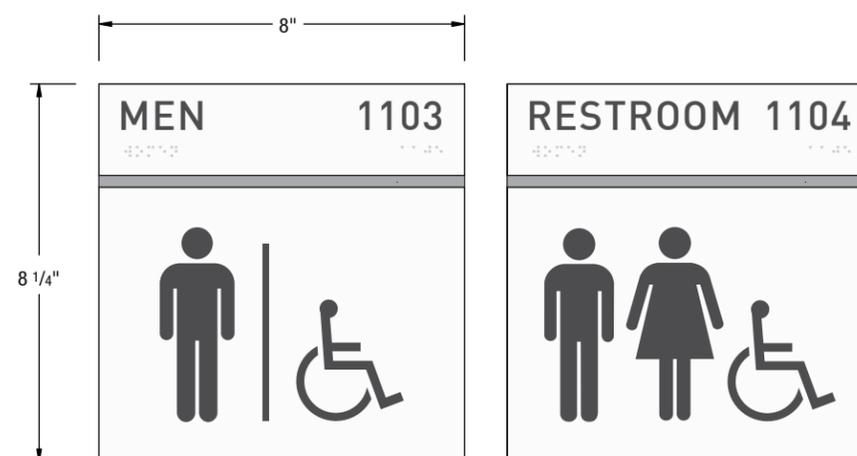

D VARIATIONS
SCALE: 1:4

FILE PATH Q:\UCR MRB1\20180426 UCR Contract\Renderings, Submittals & PDFs\Submittals\Archive\UCR MRB1_Interior Code Signs



CONTACT
Albuquerque / Phoenix
P 505.888.2901 ext 109
F 505.888.2902
csbsigns.com

DRAWN BY
Lawrence Spingola
Lawrence.Spingola@csbsigns.com

This artwork and design is owned by Century Sign Builders unless expressly stated. Use of this document or the design shown here without permission is prohibited.

CLIENT / PROJECT
Client / GC: Hensel Phelps
Project: University of California, Riverside - MRB1


APPROVAL REQUIRED FOR PRODUCTION

SIGNATURE / DATE


DATE
Modification Date: July 24, 2018 4:03 PM

SHEET TITLE
Sign Type B36
Wall Mounted Restroom ID


SHEET
16

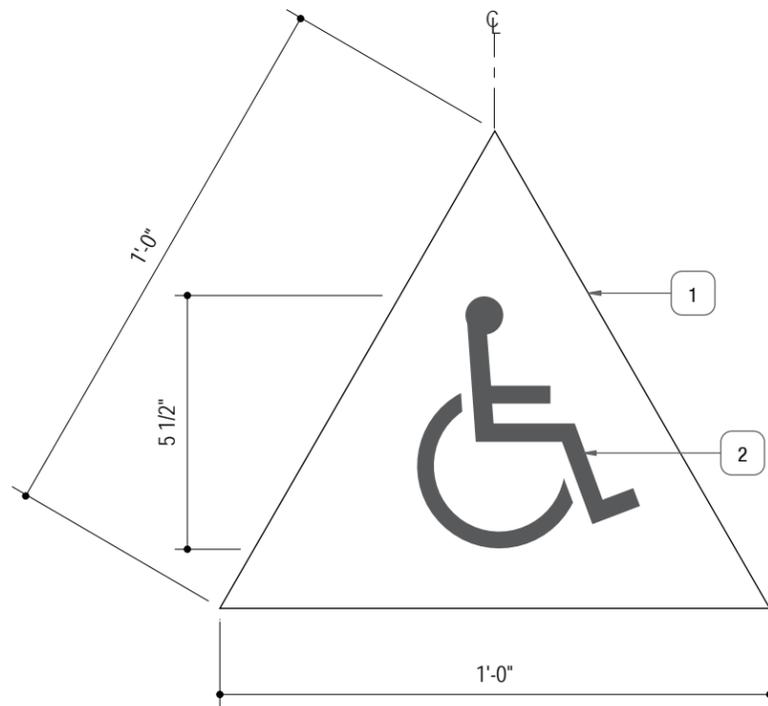


A MEN ELEVATION
SCALE: 3" = 1'

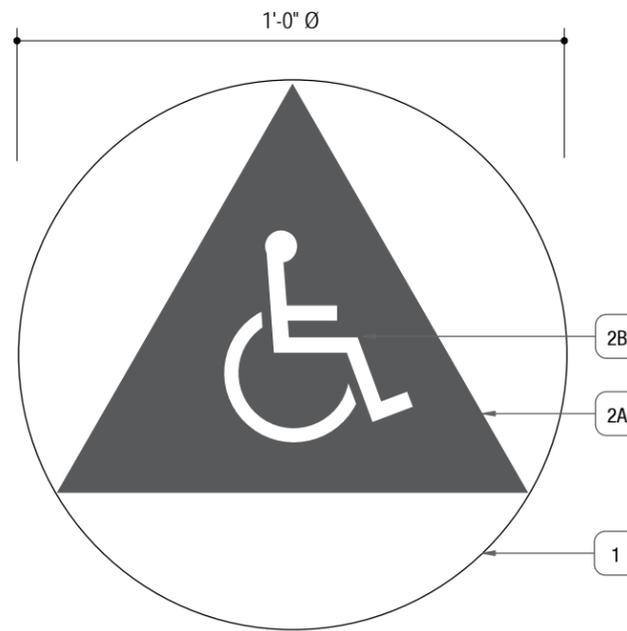


B UNISEX ELEVATION
SCALE: 3" = 1'

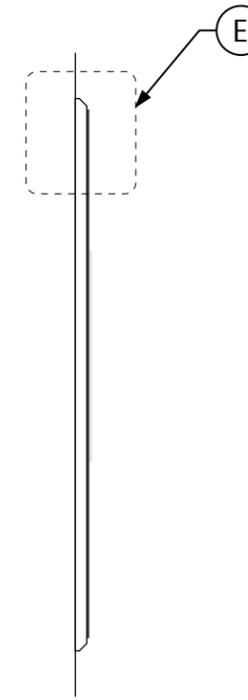


C SIDE ELEVATION
SCALE: 3" = 1'

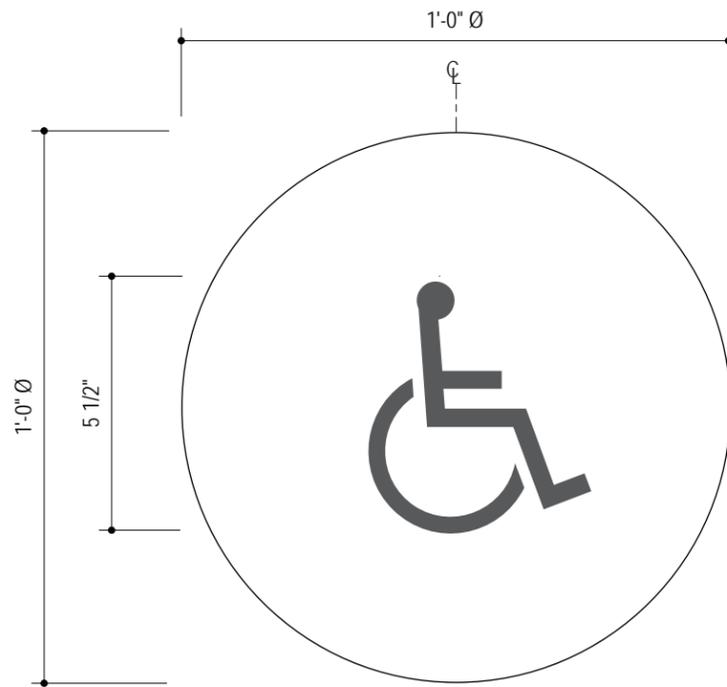

D WOMEN ELEVATION
SCALE: 3" = 1'

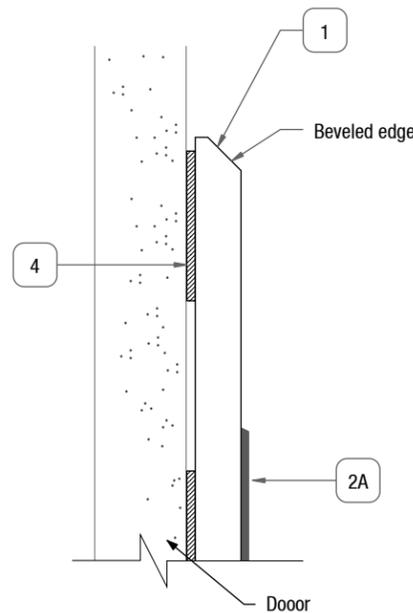

E DETAIL SECTION
SCALE 1:1

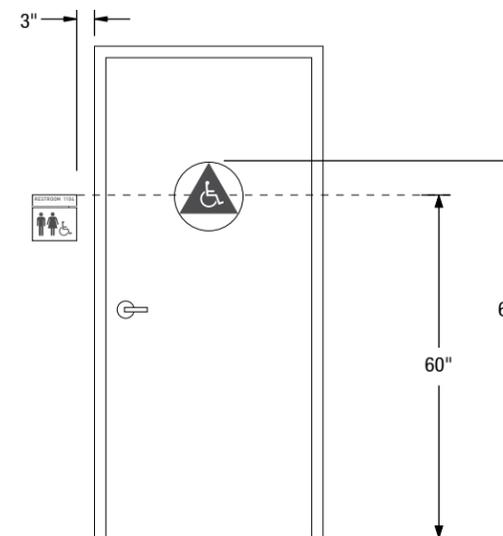

F INSTALLATION
SCALE: 3/8" = 1'

B80

Sign Type: Door Mounted Restroom ID
Description: CA. Compliant Restroom Sign

SIGN SPECIFICATIONS

1. SIGN PANEL SUBSTRATE (FACES)

Finish Size:
- 12" Triangle, 12" Diameter Circle
Material: 1/4" Plaskolite Non-Glare Clear Acrylic (P99)
Backpaint: Matthews MAP-LVS202 White
Edge: Bevel

2A. TACTILE APPLIQUÉ

Material: Modified Acrylic
Depth: 1/32" Thick
Color: 311-307 Charcoal Grey

2B. TACTILE APPLIQUÉ

Material: Modified Acrylic
Depth: 1/32" Thick
Color: 312-201 UM Matte White

3. BRAILLE

None

4. MOUNTING

Tape: 1/16" Thick Double Sided Foam Tape & RTV 108 Silicon Adhesive as needed

INSTALLATION PLACEMENT

Top of Sign: 60" AFF
Placement: 9" OC of Tactile Characters
From Opening of Door
Location: Adjacent to Latch Side of Door
Refer to CSB Installation Standards

FILE PATH Q:\UCR MRB1\20180426 UCR Contract\Renderings, Submittals & PDFs\Submittals\Archive\UCR MRB1_Interior Code Signs



CONTACT

Albuquerque / Phoenix
P 505.888.2901 ext 109
F 505.888.2902
csbsigns.com

DRAWN BY

Lawrence Spingola
Lawrence.Spingola@csbsigns.com

This artwork and design is owned by Century Sign Builders unless expressly stated. Use of this document or the design shown here without permission is prohibited.

CLIENT / PROJECT

Client / GC: Hensel Phelps
Project: University of California, Riverside - MRB1

APPROVAL REQUIRED FOR PRODUCTION

SIGNATURE / DATE

DATE

Modification Date: July 24, 2018 4:03 PM

SHEET TITLE


Sign Type B80
Door Mounted Restroom ID

SHEET

17




A SIGN FACE ELEVATION - EXIT LEVEL
SCALE: 1:5

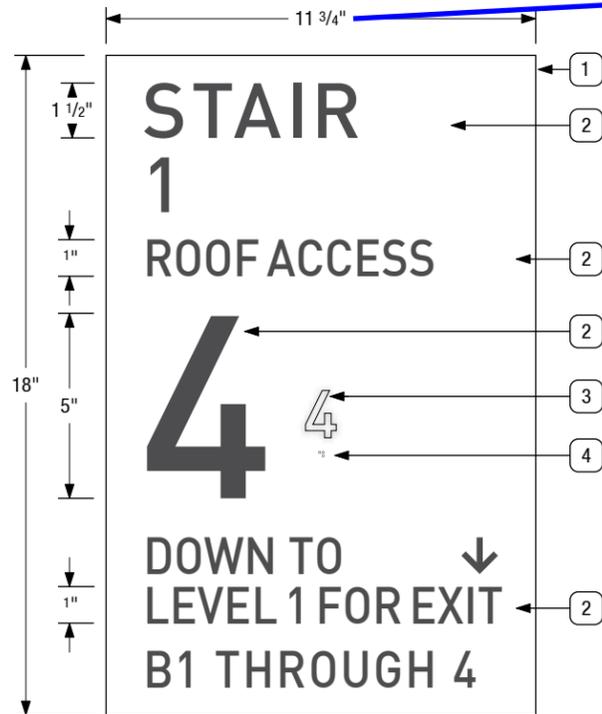


B SIGN FACE ELEVATION
SCALE: 1:5

Signage is required to be 18" by 12" per CBC 1023.9. Update accordingly.

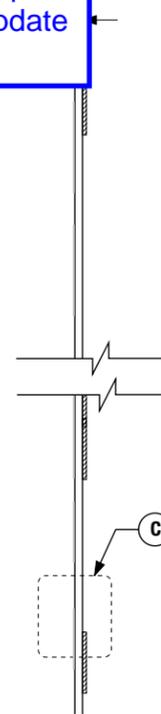

C SIDE VIEW
SCALE: 1:3

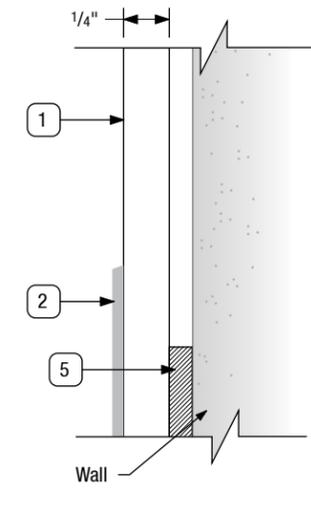

D DETAIL SECTION
SCALE: 2:1

B82


Sign Type: Wall Mounted Stair ID
Description: Stairwell Landing

SIGN SPECIFICATIONS

- SIGN PANEL SUBSTRATE**
Finish Size: 18" H x 11.75" W
Material: Plaskolite Non-Glare Clear Acrylic (P99)
Thickness: 1/4"
Backpaint: Matthews MAP-LVS202 White
- TACTILE APPLIQUÉ**
Material/Thickness: 1/32" Modified Acrylic
Font Heights: -1", 1 1/2", 5"
Font Line Spacing: 150%
Fonts:
- Din Medium
- Din Medium @90% horizontal scale
- Din Medium Condensed
Font Color: 311-307 Charcoal Grey
- TACTILE APPLIQUÉ**
Material/Thickness: 1/32" Modified Acrylic
Font Line Spacing: 150%
Font: Helvetica Neue LT Std - 57 Condensed
Color: 311-101 Clear
- BRAILLE**
Type: Clear Grade II Braille
- MOUNTING**
Tape: 1/16" Thick Double Sided Foam Tape & RTV 108 Silicon Adhesive as needed

Questions

1. Verify roof access
2. Verify stairway label (Stair 1 vs. Stair A)

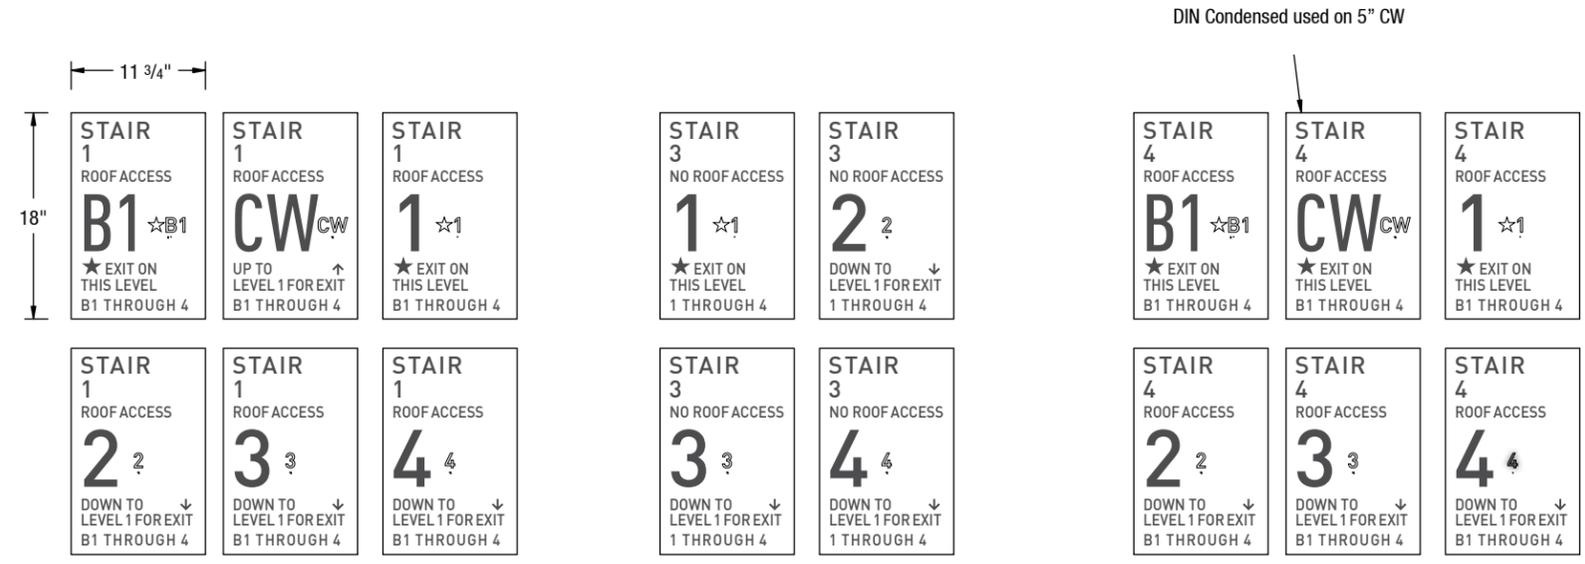

D VARIATIONS
SCALE: 3/4"=1'

tk1sc

NO EXCEPTIONS NOTED REJECTED RESUBMIT AS REQUIRED
 FURNISH AS CORRECTED REVISE & RESUBMIT

BY smiller DATE 8/2/2018


This review is only for general conformance with the design concept of the project and general compliance with the information included in the Contract Documents. Any action shown is subject to the requirements of the drawings and specifications. No action shown here shall in anyway relieve the contractor of the responsibility of providing complete and operating systems as shown on the Contract Documents. Contractor is responsible for correlating and confirming dimensions at the job site; choice of fabrication processes and techniques of construction; coordination of his work with that of other trades; and performing the work in a safe and satisfactory manner.

FILE PATH Q:\UCR MRB1\20180426 UCR Contract\Renderings, Submittals & PDFs\Submittals\Archive\UCR MRB1_Interior Code Signs






A ELEVATION
SCALE: 1:2

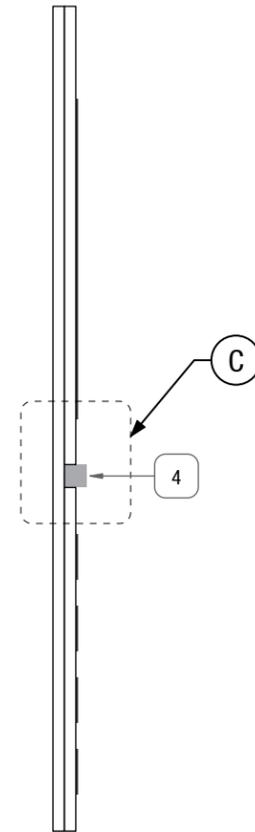

B SIDE VIEW
SCALE: 1:2

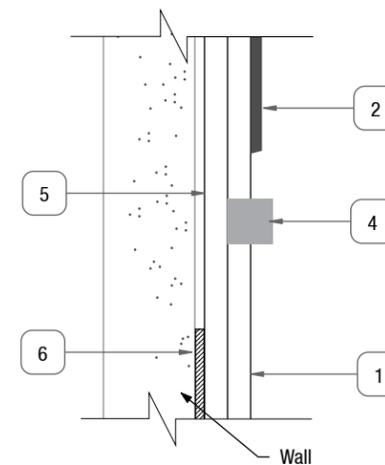

C DETAIL SECTION
SCALE: 1:1

B60

Description:
Wall Mounted Secondary Information

SIGN SPECIFICATIONS

1. SIGN PANEL SUBSTRATE (FACES)

Finish Sizes:
- 5" H x 7.5" W (top piece)
- 3.75" H x 7.5" W (Bottom piece)
Material: 1/8" Plaskolite Non-Glare
Clear Acrylic (P99)
Backpaint: Matthews MAP-LVS202 White

2. TACTILE APPLIQUÉ

Material: Modified Acrylic
Font Height: 5/8" Tall
Font Depth: 1/32" Thick
Font: DIN Medium
Font Color: 311-307 Charcoal Grey

3. BRAILLE

None

4. DECORATIVE METAL BAR

Material: 6063 aluminum Square .25" x 7.5"
Finish: #4 brushed finish (horizontal grain)
Fastener: Thin DT tape

5. SIGN PANEL SUBSTRATE (BACKER)

Finish Size: 9" H x 7.5" W
Material: 1/8" Plaskolite Non-Glare
Clear Acrylic (P99)
Fasten to sign panel substrate (detail 1)
with thin DT tape

6. MOUNTING

Tape: 1/16" Thick Double Sided Foam Tape
& RTV 108 Silicon Adhesive as needed

INSTALLATION PLACEMENT

Top of Sign: 60" AFF
Placement: 9" OC of Tactile Characters
From Opening of Door
Location: Adjacent to Latch Side of Door
Refer to CSB Installation Standards

Questions

1. Verify install location and location of ALD

FILE PATH Q:\UCR MRB1\20180426 UCR Contract\Renderings, Submittals & PDFs\Submittals\Archive\UCR MRB1_Interior Code Signs



CONTACT
Albuquerque / Phoenix
P 505.888.2901 ext 109
F 505.888.2902
csbsigns.com

DRAWN BY
Lawrence Spingola
Lawrence Spingola@csbsigns.com

This artwork and design is owned by Century Sign Builders unless expressly stated. Use of this document or the design shown here without permission is prohibited.

CLIENT / PROJECT
Client / GC: Hensel Phelps
Project: University of California, Riverside - MRB1

APPROVAL REQUIRED FOR PRODUCTION

SIGNATURE / DATE

DATE
Modification Date: July 24, 2018 4:03 PM

SHEET TITLE

Sign Type B60
Wall Mounted Secondary Info

19

B32

Description: Wall Mounted Paper Holder Room ID

SIGN SPECIFICATIONS

1. HEADER/FOOTER TRIM SUBSTRATE

Size: 2" H x 8-1/2" W
 Material: 1/8" Plaskolite Non-Glare Clear Acrylic (P99)
 Backpaint: Matthews MAP-LVS202 White

2. SPACER SUBSTRATE

Size for Portrait: 1 7/8" H x 8-1/2" W
 Material/Thickness: 1/32" Modified Acrylic
 Color: Ultra Matte Clear (312-101)

3. FRONT LENS SUBSTRATE

Size for Portrait: 13-3/16" H x 8-1/2" W
 Material/Thickness: 1/16" Non Glare Acrylic

4. INSERT

Size for Portrait: 11" H x 8-1/2" W
 Media: Sihl 3408

5. BACK LENS SUBSTRATE

Size for Portrait: 14" H x 8-1/2" W
 Material/Thickness: 1/16" Clear Acrylic

6. TACTILE APPLIQUÉ

Material: Modified Acrylic
 Font Height: 5/8" Tall
 Font Depth: 1/32" Thick
 Font: DIN Medium
 Font Color: 311-307 Charcoal Grey

7. BRAILLE


Type: Clear Grade II Braille

8. DECORATIVE METAL BAR


Material: 6063 aluminum Square .25" x 7.5"
 Finish: #4 brushed finish (horizontal grain)
 Fastener: Thin DT tape

9. MOUNTING

Tape: 1/16" Thick Double Sided Foam Tape & RTV 108 Silicon Adhesive as needed

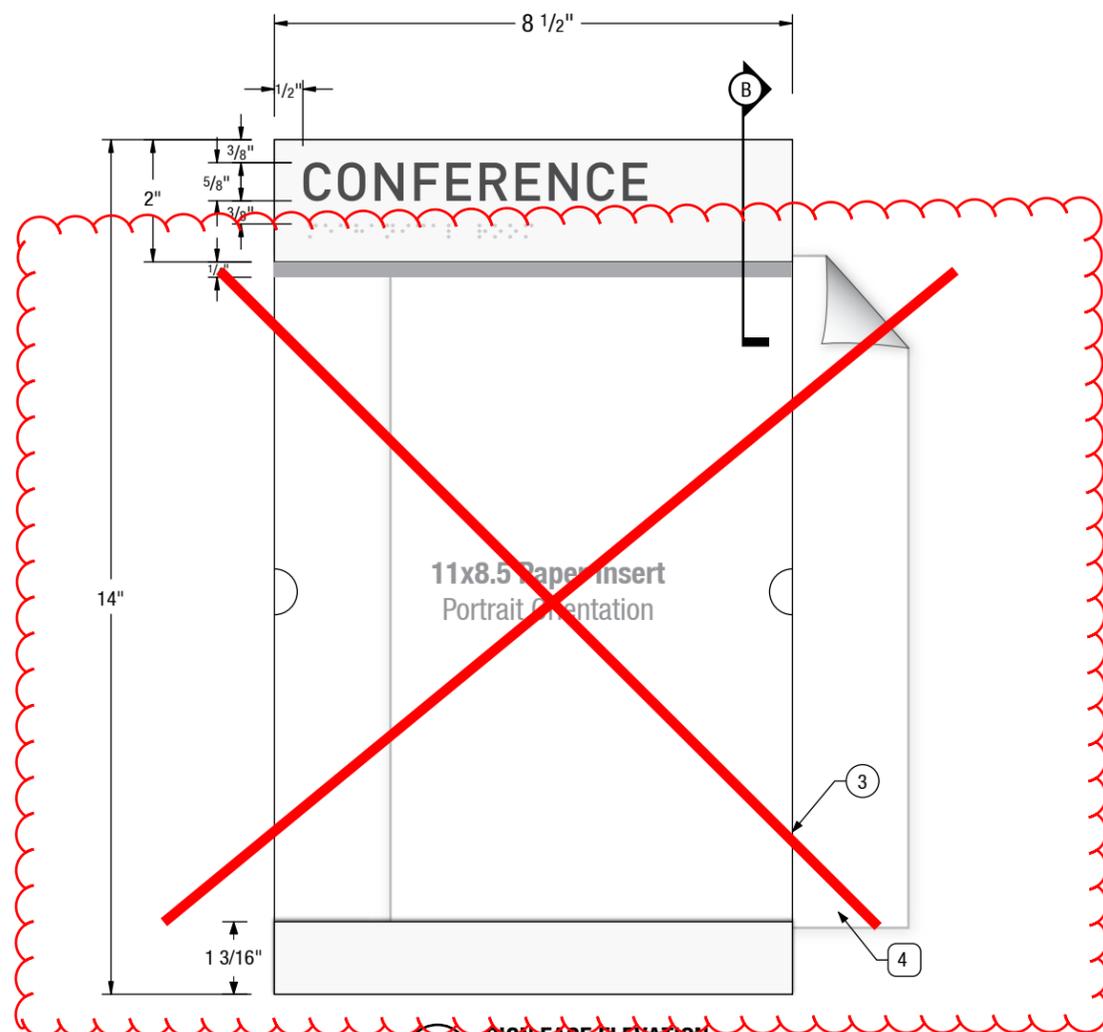

A SIGN FACE ELEVATION
 SCALE: 1:3

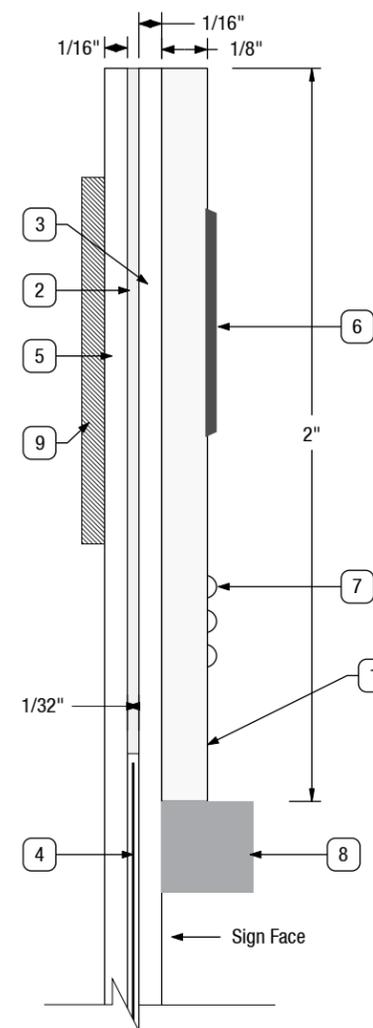

B DETAIL SECTION
 SCALE: 2:1

FILE PATH Q:\UCR MRB1\20180426 UCR Contract\Renderings, Submittals & PDFs\Submittals\Archive\UCR MRB1_Interior Code Signs



CONTACT
 Albuquerque / Phoenix
 P 505.888.2901 ext 109
 F 505.888.2902
 csbsigns.com

DRAWN BY
 Lawrence Spingola
 Lawrence Spingola@csbsigns.com
 This artwork and design is owned by Century Sign Builders unless expressly stated. Use of this document or the design shown here without permission is prohibited.

CLIENT / PROJECT
 Client / GC: Hensel Phelps
 Project: University of California, Riverside - MRB1

APPROVAL REQUIRED FOR PRODUCTION
 SIGNATURE / DATE

DATE
 Modification Date: July 24, 2018 4:03 PM

SHEET TITLE
 Sign Type B32
 Wall Mounted Paper Holder
 Room ID



SHEET
 20

LAB BENCH


Description: Lab Bench / Lab Safety Sign
End-User Updateable

SIGN SPECIFICATIONS

- 1. FRAME**
JRS 28, Satin Silver
1 1/8" x 1/16" x 6" Frame
- 2. LENS**
Material: 1/16" Thick Modified Acrylic
Color: 322-101 Clear
- 3. UPDATABLE TRANSPARENCY**
Material: Clear transparency film
Font: 36 pt. Arial
- 4. MOUNTING**
Tape: 1/16" Thick Double Sided Foam Tape
& RTV 108 Silicon Adhesive as needed

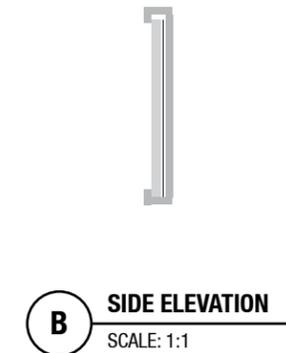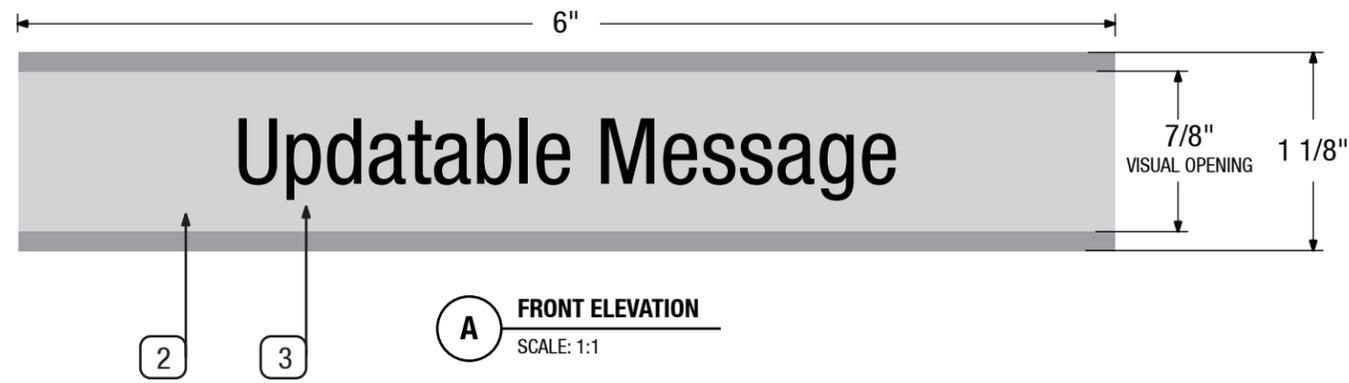

BACK VIEW

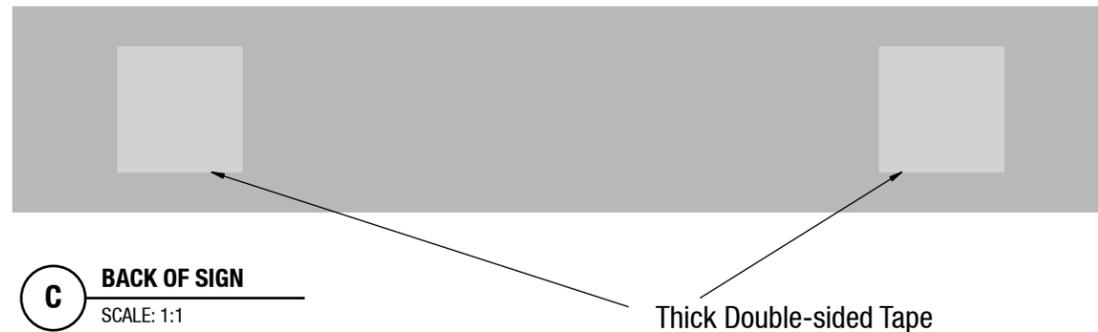


D PHOTO EXAMPLE OF SIGN TYPE
SCALE: NTS


FILE PATH Q:\UCR MRB1\20180426 UCR Contract\Renderings, Submittals & PDFs\Submittals\Archive\UCR MRB1_Interior Code Signs




| CONTACT | DRAWN BY | CLIENT / PROJECT | DATE | SHEET TITLE | SHEET |
|---|--|--|--|--|-------|
| Albuquerque / Phoenix P 505.888.2901 ext 109 F 505.888.2902 csbsigns.com | Lawrence Spingola Lawrence Spingola@csbsigns.com <small>This artwork and design is owned by Century Sign Builders unless expressly stated. Use of this document or the design shown here without permission is prohibited.</small> | Client / GC: Hensel Phelps Project: University of California, Riverside - MRB1 APPROVAL REQUIRED FOR PRODUCTION | Modification Date: July 24, 2018 4:03 PM SIGNATURE / DATE | Lab Bench Lab Bench / Lab Safety Sign | 21 |

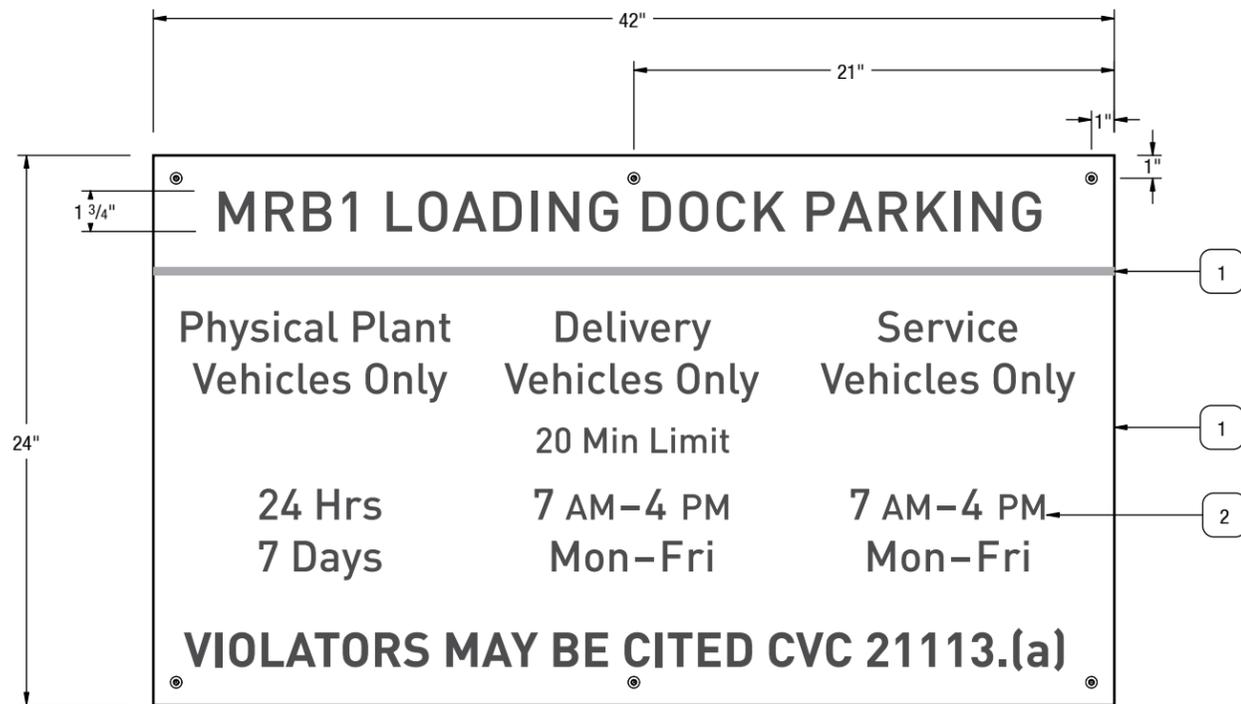


A **LOADING DOCK SIGN**
SCALE: 1:3

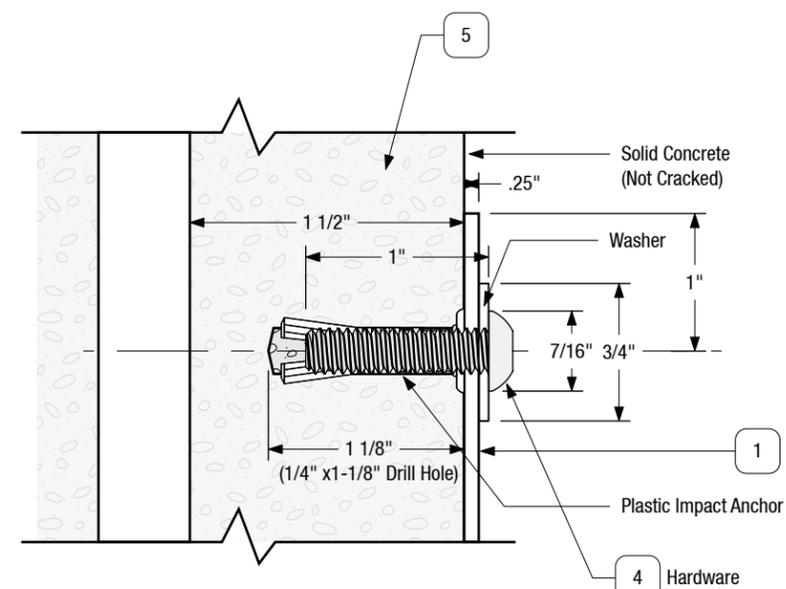

B **SECTION DETAIL - HARDWARE**
SCALE: 1:1

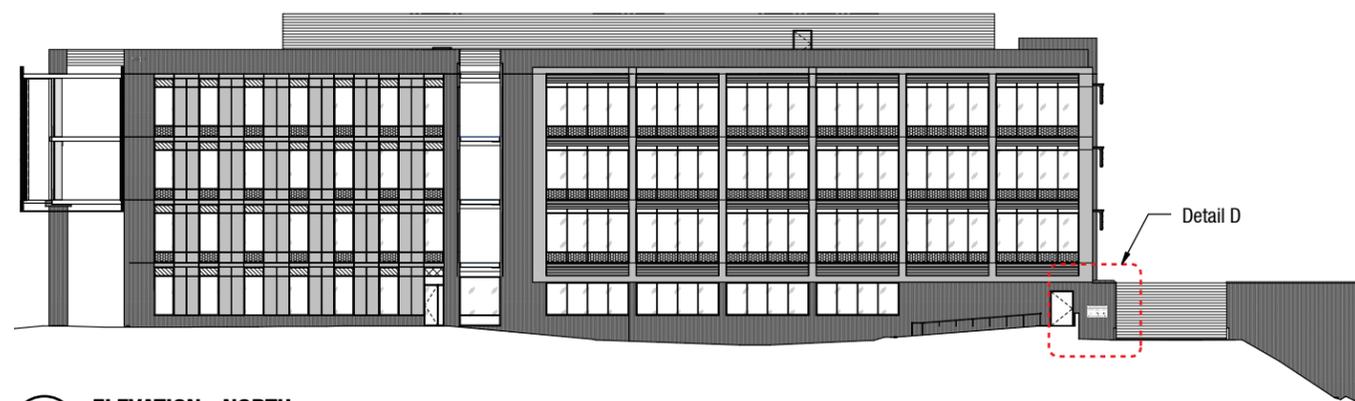

C **ELEVATION - NORTH**
SCALE: 1/32" = 1'

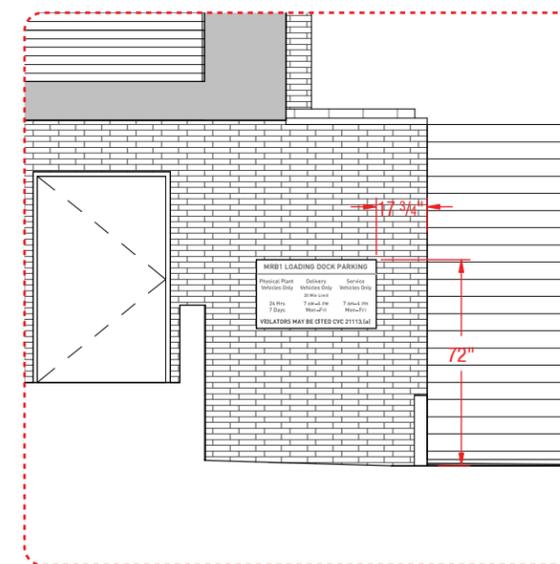

D **INSTALLATION DETAIL**
SCALE: 3/16" = 1'

B95

Sign Type: Wall Mounted Loading Dock
Parking Regulatory Info

SIGN SPECIFICATIONS

1. SIGN PANEL SUBSTRATE

Finish Size: 24" H x 42" W
Material: 6mm Alupanel
Thickness: .23"
Paint: Matthews Paint
Color: Matthews MAP-LVS202 White
Finish: Satin

2. GRAPHICS

3M Scotchcal Series 7125 Vinyl
Vinyl Types:
- Dark Grey 41 (Gerber 220-41)
- 3M Satin Aluminum 120 (Gerber 225-120)
Font: Din Medium
Visibility: 37'

3. LAMINATE

Media: 3M Scotchcal Matte Overlaminat
8520CP

4. MOUNTING

(2) 1/4", 1" L. Expansion Plastic Anchor
(2) 18-8 Stainless Steel Pin-in-Hex Button
Socket Cap Screw 1/4"-20 Thread, 1" Length
(Part No 95635A542 McMaster-Car) or EQ
(2) Washer, .625" dia, .265" Thru Hole
Tape: 1/16" Thick Double Sided Foam Tape
& RTV 108 Silicon Adhesive as needed
Paint to match sign face

Notes

1. Verify / provide content

FILE PATH Q:\UCR MRB1\20180426 UCR Contract\Renderings, Submittals & PDFs\Submittals\Archive\UCR MRB1_Interior Code Signs



CONTACT
Albuquerque / Phoenix
P 505.888.2901 ext 109
F 505.888.2902
csbsigns.com

DRAWN BY
Lawrence Spingola
Lawrence.Spingola@csbsigns.com

This artwork and design is owned by Century Sign Builders unless expressly stated. Use of this document or the design shown here without permission is prohibited.

CLIENT / PROJECT
Client / GC: Hensel Phelps
Project: University of California, Riverside - MRB1

APPROVAL REQUIRED FOR PRODUCTION

SIGNATURE / DATE

DATE
Modification Date: July 24, 2018 4:03 PM

SHEET TITLE
Sign Type B95
Wall Mounted Loading Dock

SHEET
22

2WC

Sign Type: 2WC
Description: Two Way Communication Instructions

SIGN SPECIFICATIONS

1. SIGN PANEL FACE SUBSTRATE

Finish Size: 18" H x 11.75" W
Material: 1/8" Plaskolite Non-Glare Clear Acrylic (P99)
Backpaint: Matthews MAP-LVS202 White

2. PRINTED TEXT GRAPHICS


Print: Direct to Substrate UV Digital Print
Font Size: 3/4" and 5/8"
Font: DIN Medium
Color Match:
- Rowmark ADA Charcoal Grey (PMS 7 Black CV)
- Note: Color matching accurate 7/19/2018

3. MOUNTING


Tape: 1/16" Thick Double Sided Foam Tape & RTV 108 Silicon Adhesive as needed

Questions

1. Is this sign in Century Sign Builders' scope?
2. Please provide cut sheet and specifications of the 2 way communication device if needed.

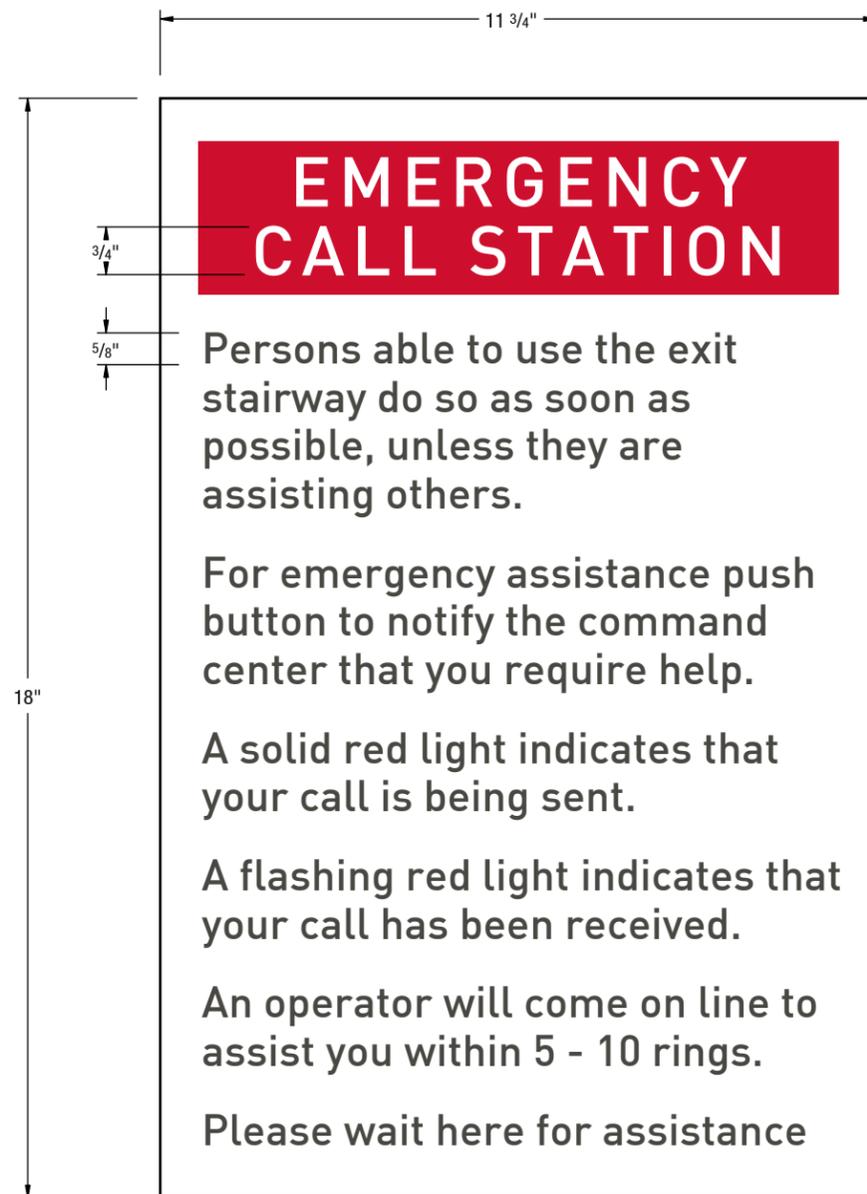

A 2 WAY COMM DEVICE ELEVATION
SCALE 1:3

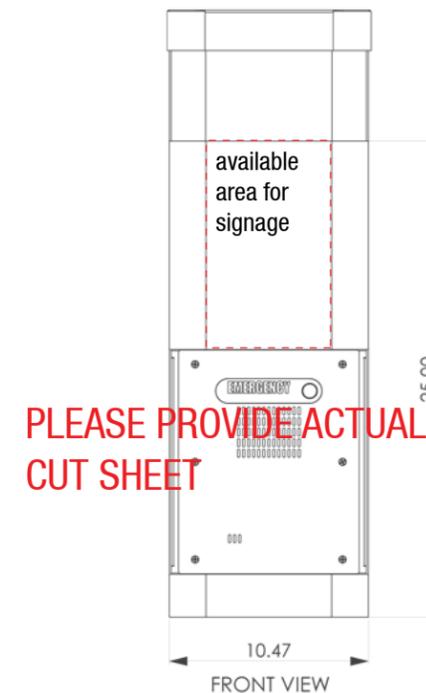

B 2 WAY COMM INSTRUCTION
SCALE: 1:5

FILE PATH Q:\UCR MRB1\20180426 UCR Contract\Renderings, Submittals & PDFs\Submittals\Archive\UCR MRB1_Interior Code Signs



CONTACT
Albuquerque / Phoenix
P 505.888.2901 ext 109
F 505.888.2902
csbsigns.com

DRAWN BY
Lawrence Spingola
Lawrence Spingola@csbsigns.com
This artwork and design is owned by Century Sign Builders unless expressly stated. Use of this document or the design shown here without permission is prohibited.

CLIENT / PROJECT
Client / GC: Hensel Phelps
Project: University of California, Riverside - MRB1

APPROVAL REQUIRED FOR PRODUCTION

SIGNATURE / DATE

DATE
Modification Date: July 24, 2018 4:03 PM

SHEET TITLE
Sign Type 2WC
2 Way Communication Device Instructions

SHEET

23


FDC Sign FACP Sign

SPECIFICATIONS


- SIGN PANEL SUBSTRATE**
Material: .080 Aluminum Sign Blank
Size: 18" x 12"
Cladding: 3M Reflective White Vinyl 3430 (EG)
Corner Rounds: 1.5" Radius
- GRAPHICS**
Print: Direct to Substrate UV Digital Print
Font Size: 6" and 2"
Font: DIN Medium
Visibility: 150'
- PROTECTIVE LAMINATE**
Media: 3M Scotchcal Matte Overlamine
8520CP
- MECHANICAL ANCHORING SYSTEM**
(2) 1/4", 1" L. Expansion Plastic Anchor
(2) 18-8 Stainless Steel Pin-in-Hex Button
Socket Cap Screw 1/4"-20 Thread, 1" Length
(Part No 95635A542 McMaster-Car) or EQ
(2) Washer, .625" dia, .265" Thru Hole
- MOUNTING SURFACE**
Exterior Column: Concrete / Panel System
- REQUIRED MOUNTING EQUIPMENT**
Ladder: Required
Drill Bit: Drill Bit 1/4" for Concrete
Clean Tool: Hilti Blow-out pump (60579)
Drive Tool: 5/32" Tamper-Hex



A ELEVATION
SCALE: 1:4

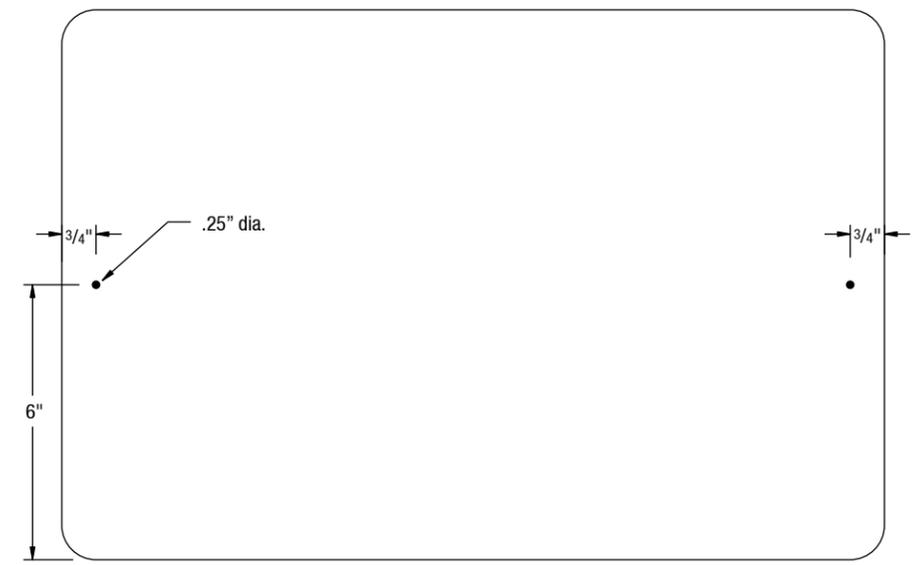

B HARDWARE LOCATION
SCALE: 1:4

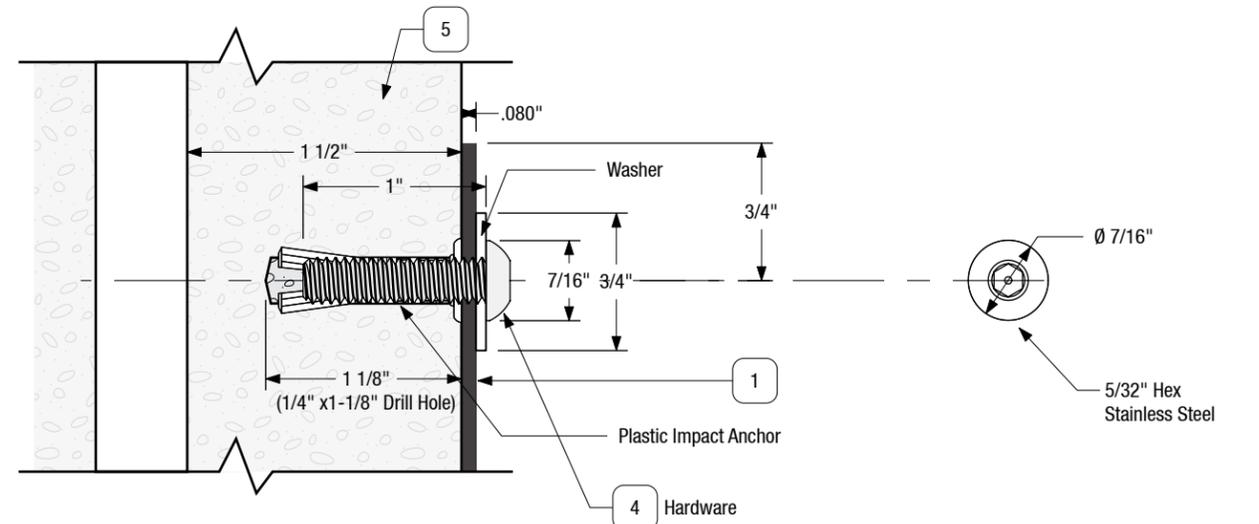

C SECTION DETAIL - HARDWARE
SCALE: 1:1

D TAMPER RESISTANT BOLT HEAD
SCALE: 1:1



E VARIATION
SCALE: 1:4

Questions

1. Verify / provide install locations for mounting hardware and placement plan

FILE PATH Q:\UCR MRB1\20180426 UCR Contract\Renderings, Submittals & PDFs\Submittals\Archive\UCR MRB1_Interior Code Signs

| CONTACT | DRAWN BY | CLIENT / PROJECT | DATE | SHEET TITLE | SHEET |
|---|--|--|--|---|-------|
| Albuquerque / Phoenix P 505.888.2901 ext 109 F 505.888.2902 csbsigns.com | Lawrence Spingola Lawrence Spingola@csbsigns.com <small>This artwork and design is owned by Century Sign Builders unless expressly stated. Use of this document or the design shown here without permission is prohibited.</small> | Client / GC: Hensel Phelps Project: University of California, Riverside - MRB1 APPROVAL REQUIRED FOR PRODUCTION | Modification Date: July 24, 2018 4:03 PM | Sign Type FDC Fire Department Connection | 24 |
| | | SIGNATURE / DATE | | | |



25

Interior Sign Installation Guidelines

General Contractor: Hensel Phelps
Project: UCR MRB1
Developed By: Century Sign Builders

2010 ADA Standards for Accessible Design


703.4 Installation Height and Location. Signs with tactile characters shall comply with 703.4.

703.4.1 Height Above Finish Floor or Ground. Tactile characters on signs shall be located 48 inches (1220 mm) minimum above the finish floor or ground surface, measured from the baseline of the lowest tactile character and 60 inches (1525 mm) maximum above the finish floor or ground surface, measured from the baseline of the highest tactile character.


703.4.2 Location. Where a tactile sign is provided at a door, the sign shall be located alongside the door at the latch side. Where a tactile sign is provided at double doors with one active leaf, the sign shall be located on the inactive leaf. Where a tactile sign is provided at double doors with two active leaves, the sign shall be located to the right of the right hand door. Where there is no wall space at the latch side of a single door or at the right side of double doors, signs shall be located on the nearest adjacent wall. Signs containing tactile characters shall be located so that a clear floor space of 18 inches (455 mm) minimum by 18 inches (455 mm) minimum, centered on the tactile characters, is provided beyond the arc of any door swing between the closed position and 45 degree open position. EXCEPTION: Signs with tactile characters shall be permitted on the push side of doors with closers and without hold-open devices.

Century Sign Builders Installation Standard Placement


1. Tactile characters on signs shall be placed a minimum of 9" OC from the door swing on the latch side.
2. All though not required for doors that open in, CSB will install signs in the same location as shown in Illustration 1, for consistency.

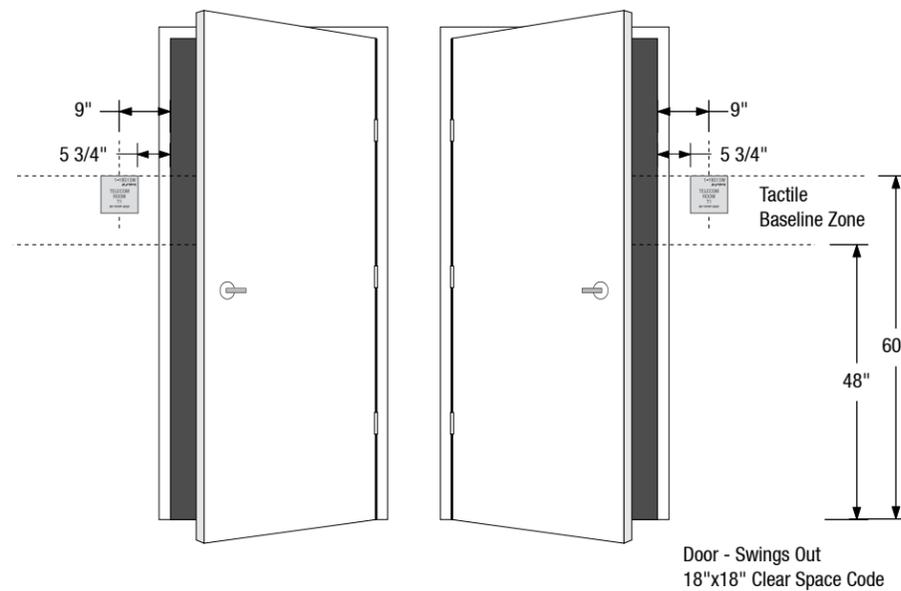

A DOOR ELEVATIONS
SCALE: 3/8" = 1'

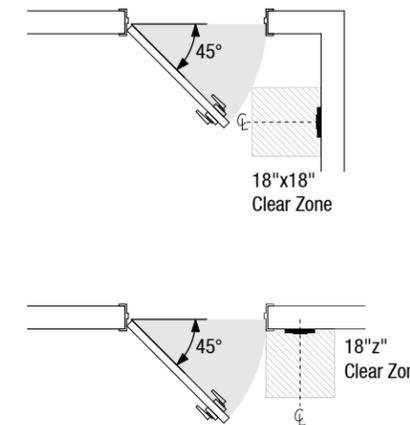

B PLAN VIEW - CLEAR ZONE
SCALE: 1/4" = 1'

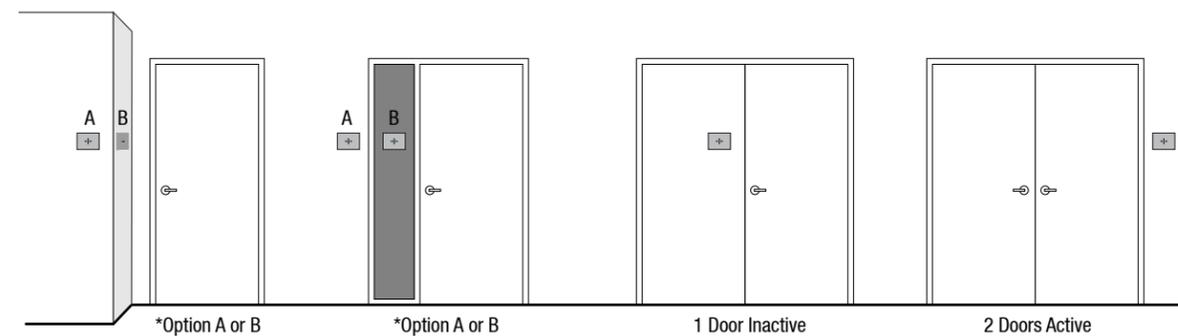

C OTHER CONDITIONS
SCALE: 3/16" = 1'

*Placement A or B Considerations:
Clear Zone Code & Consistency

FILE PATH Q:\UCR MRB1\20180426 UCR Contract\Renderings, Submittals & PDFs\Submittals\Archive\UCR MRB1_Interior Code Signs



CONTACT
Albuquerque / Phoenix
P 505.888.2901 ext 109
F 505.888.2902
csbsigns.com

DRAWN BY
Lawrence Spingola
Lawrence Spingola@csbsigns.com
This artwork and design is owned by Century Sign Builders unless expressly stated. Use of this document or the design shown here without permission is prohibited.

CLIENT / PROJECT
Client / GC: Hensel Phelps
Project: University of California, Riverside - MRB1

APPROVAL REQUIRED FOR PRODUCTION

SIGNATURE / DATE

DATE
Modification Date: July 24, 2018 4:03 PM


SHEET TITLE **SHEET**

Install Guidelines
ADA sign installation

26


Sign installation instructions based on the following 2013 and 2016 California Building Code:

- 11B-703.4 Installation Height and Location
- 11B-703.4.1 Height Above Finish Floor or Ground
- 11B-703.4.2 Location
- 1115B.5.1 Tactile Restroom Identification (2007 CBC)
- 1023.9 Stairway identification signs

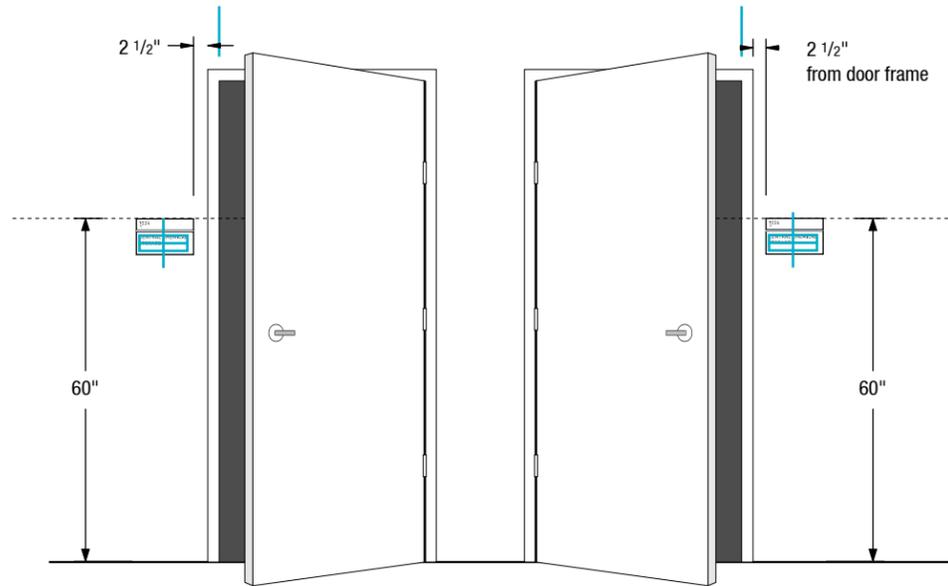


B SIGN TYPE B70
SCALE: 3/8" = 1'

Door - Swings Out
18"x18" Clear Space Code

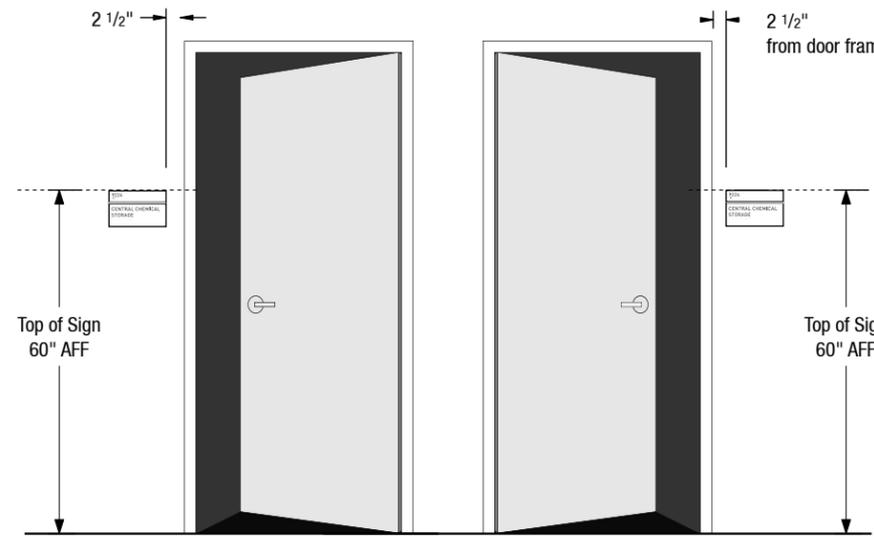


C SIGN TYPE B70
SCALE: 3/8" = 1'

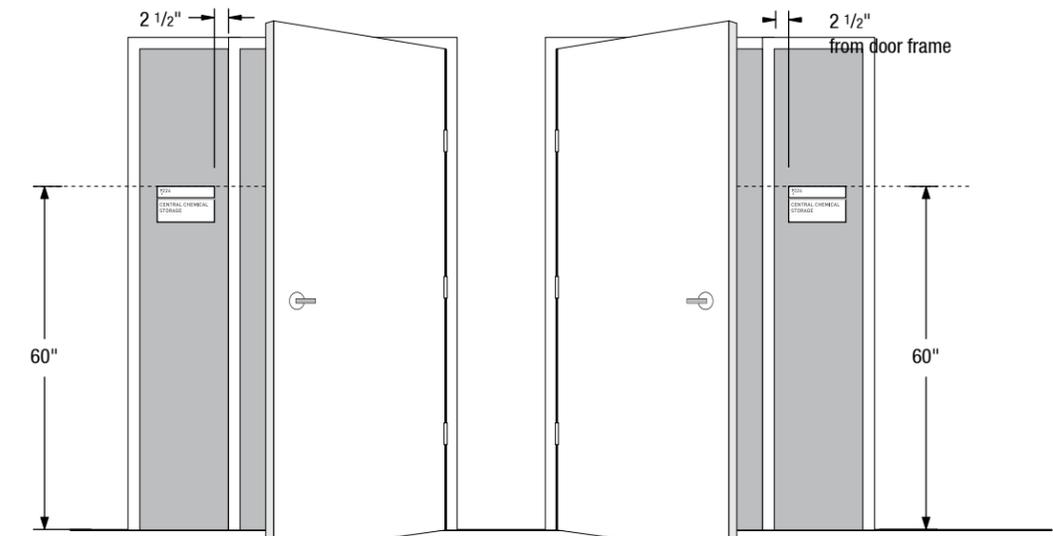


D SIGN TYPE B70 SIDELIGHT
SCALE: 3/8" = 1'

Door - Swings Out
18"x18" Clear Space Code

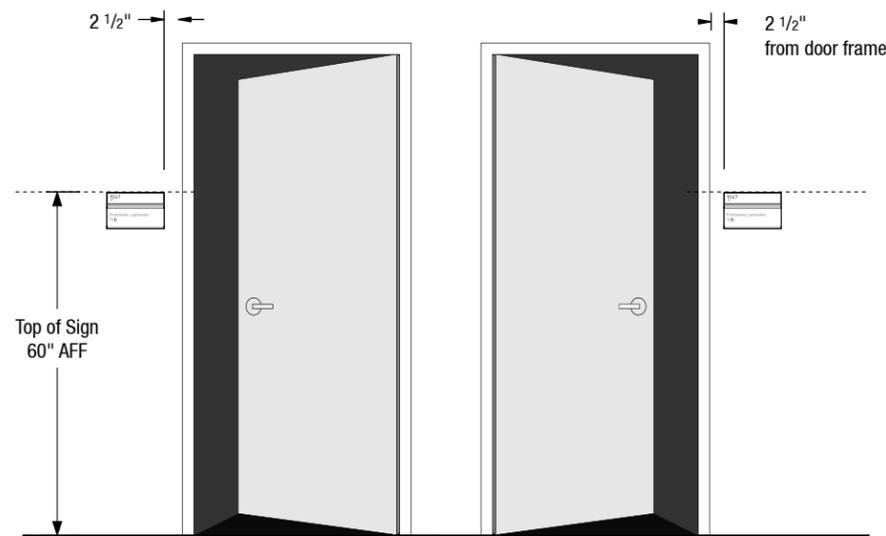

E SIGN TYPE B31
SCALE: 3/8" = 1'

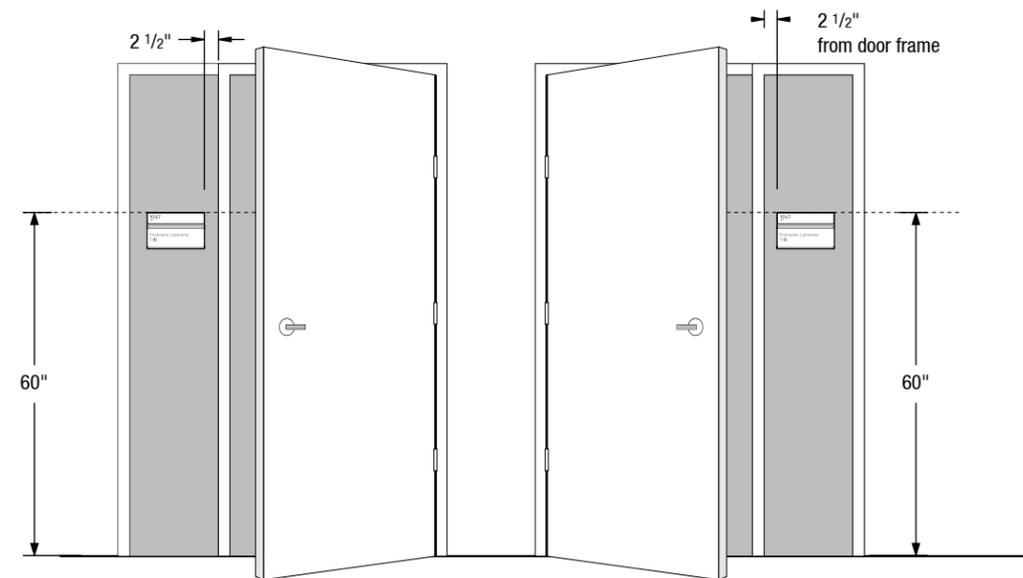

F SIGN TYPE B70 SIDELIGHT
SCALE: 3/8" = 1'

Door - Swings Out
18"x18" Clear Space Code

FILE PATH Q:\UCR MRB1\20180426 UCR Contract\Renderings, Submittals & PDFs\Submittals\Archive\UCR MRB1_Interior Code Signs



CONTACT
Albuquerque / Phoenix
P 505.888.2901 ext 109
F 505.888.2902
csbsigns.com

DRAWN BY
Lawrence Spingola
Lawrence.Spingola@csbsigns.com

This artwork and design is owned by Century Sign Builders unless expressly stated. Use of this document or the design shown here without permission is prohibited.

CLIENT / PROJECT
Client / GC: Hensel Phelps
Project: University of California, Riverside - MRB1

APPROVAL REQUIRED FOR PRODUCTION


SIGNATURE / DATE

DATE
Modification Date: July 24, 2018 4:03 PM

SHEET TITLE **SHEET**

Install Guidelines
Room Signs, Office Signs


27

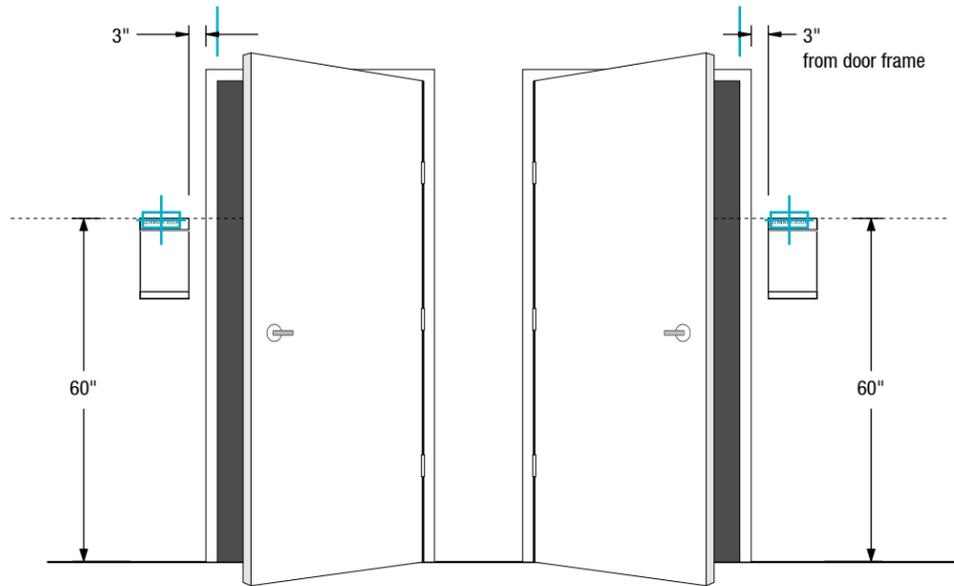


A **SIGN TYPE B32**
 Door - Swings Out
 18"x18" Clear Space Code
 SCALE: 3/8" = 1'




B **SIGN TYPE B32**
 SCALE: 3/8" = 1'

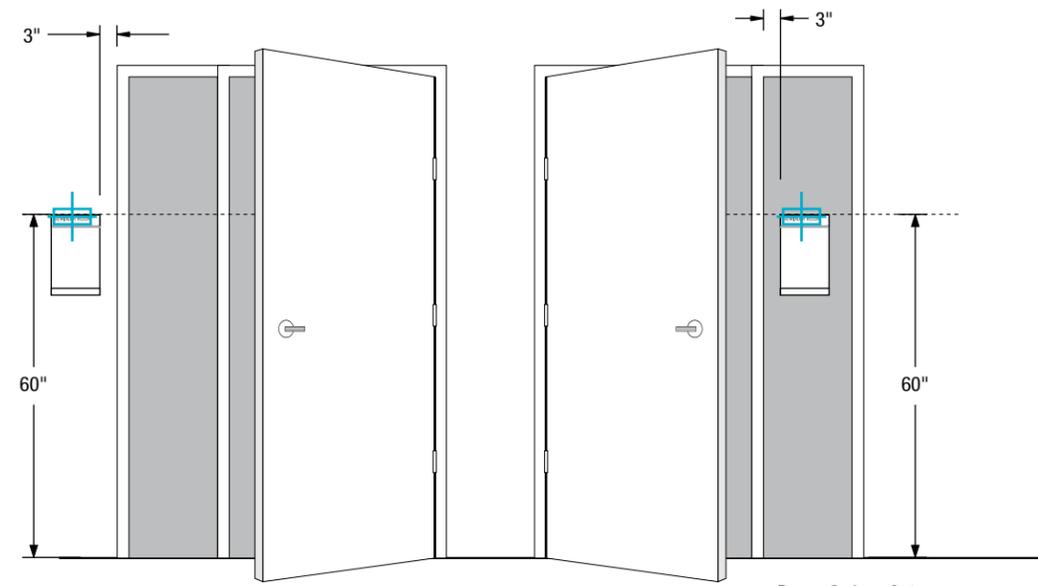


C **SIGN TYPE B32 SIDELIGHT**
 Door - Swings Out
 18"x18" Clear Space Code
 SCALE: 3/8" = 1'

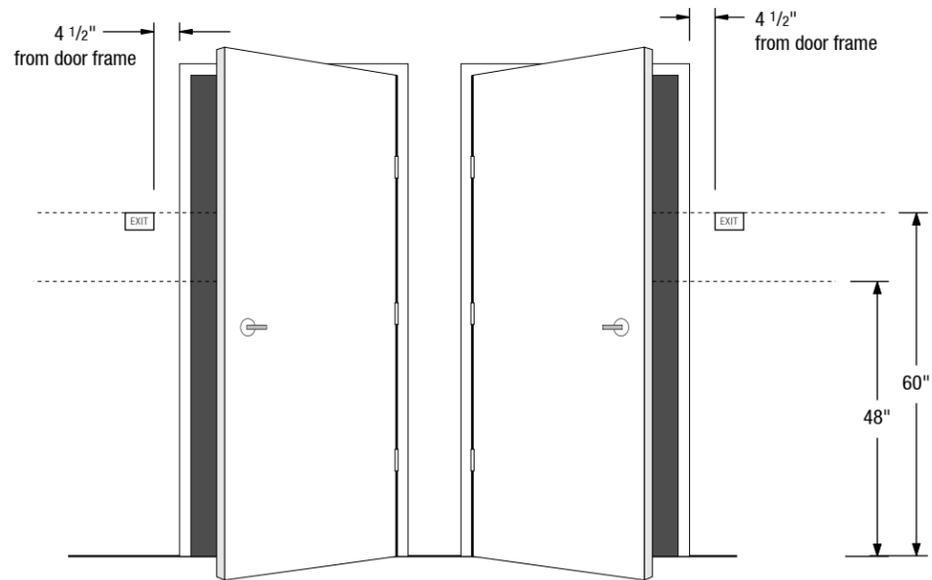

D **EXIT SIGN - SIGN TYPE E**
 Door - Swings Out
 18"x18" Clear Space Code
 SCALE: 3/8" = 1'

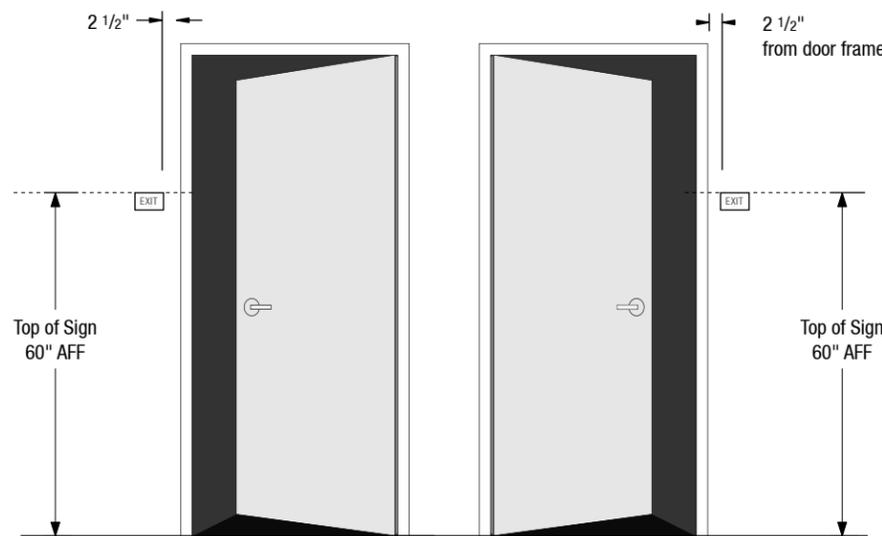

E **EXIT SIGN - SIGN TYPE E**
 SCALE: 3/8" = 1'

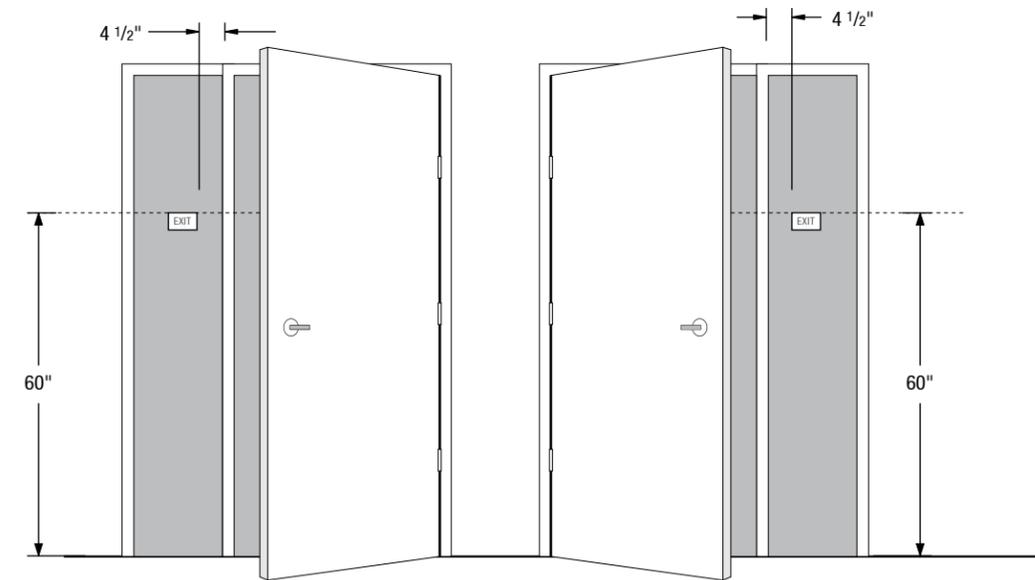

F **SIGN TYPE E SIDELIGHT**
 Door - Swings Out
 18"x18" Clear Space Code
 SCALE: 3/8" = 1'

FILE PATH Q:\UCR MRB1\20180426 UCR Contract\Renderings, Submittals & PDFs\Submittals\Archive\UCR MRB1_Interior Code Signs



CONTACT
 Albuquerque / Phoenix
 P 505.888.2901 ext 109
 F 505.888.2902
 csbsigns.com

DRAWN BY
 Lawrence Spingola
 Lawrence Spingola@csbsigns.com

This artwork and design is owned by Century Sign Builders unless expressly stated. Use of this document or the design shown here without permission is prohibited.

CLIENT / PROJECT
 Client / GC: Hensel Phelps
 Project: University of California, Riverside - MRB1

APPROVAL REQUIRED FOR PRODUCTION


SIGNATURE / DATE

DATE
 Modification Date: July 24, 2018 4:03 PM

SHEET TITLE


Install Guidelines
 Conference Room, Exit Signs

SHEET
 28

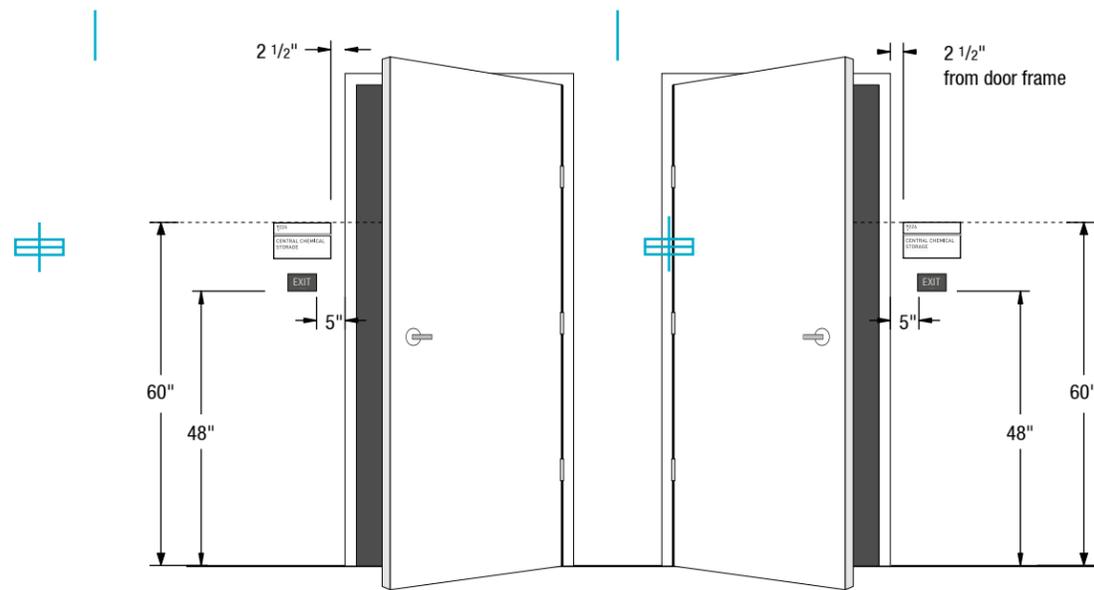

Door - Swings Out
18"x18" Clear Space Code

A **DUAL SIGN - B70 AND EXIT**
SCALE: 3/8" = 1'

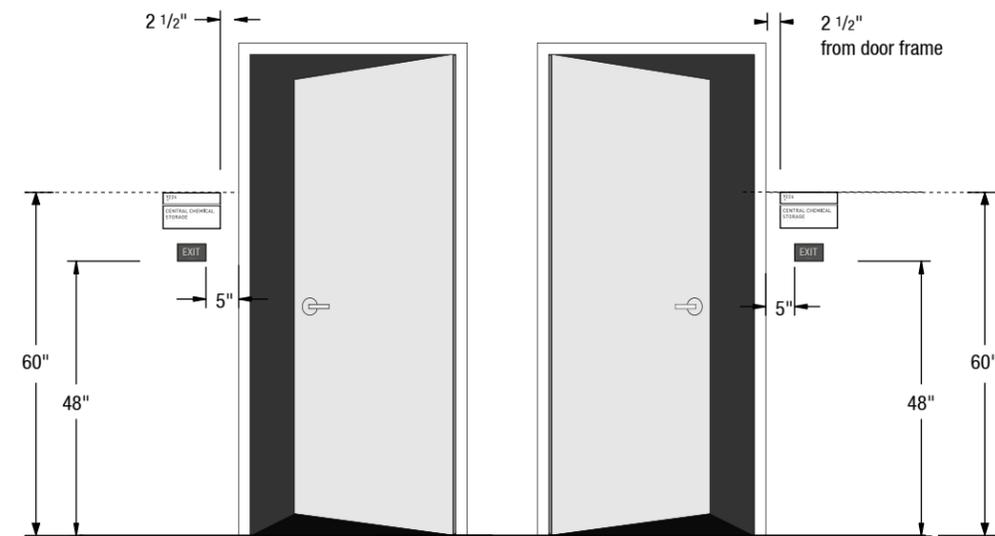


B **DUAL SIGN - B70 AND EXIT**
SCALE: 3/8" = 1'


FILE PATH Q:\UCR MRB1\20180426 UCR Contract\Renderings, Submittals & PDFs\Submittals\Archive\UCR MRB1_Interior Code Signs

| CONTACT | DRAWN BY | CLIENT / PROJECT | DATE | SHEET TITLE | SHEET |
|---|--|--|--|---|-------|
| Albuquerque / Phoenix P 505.888.2901 ext 109 F 505.888.2902 csbsigns.com | Lawrence Spingola Lawrence Spingola@csbsigns.com <small>This artwork and design is owned by Century Sign Builders unless expressly stated. Use of this document or the design shown here without permission is prohibited.</small> | Client / GC: Hensel Phelps Project: University of California, Riverside - MRB1 APPROVAL REQUIRED FOR PRODUCTION | Modification Date: July 24, 2018 4:03 PM SIGNATURE / DATE | Install Guidelines Dual ADA Room Signs | 29 |




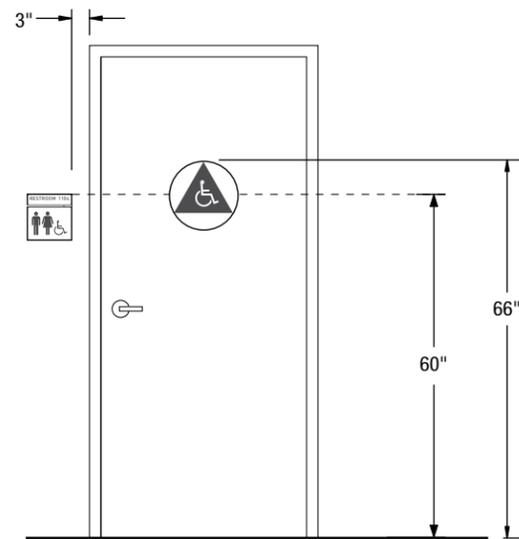


A RESTROOM DOOR - SIGN TYPE ST36 AND ST80
SCALE: 3/8" = 1'

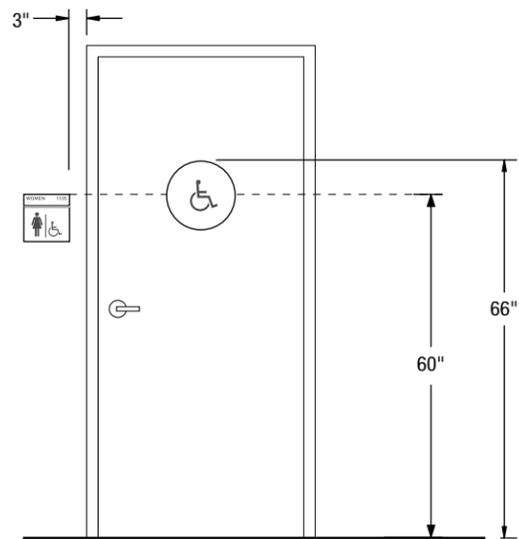


B WOMENS RESTROOM DOOR - SIGN TYPE ST36 AND ST80
SCALE: 3/8" = 1'

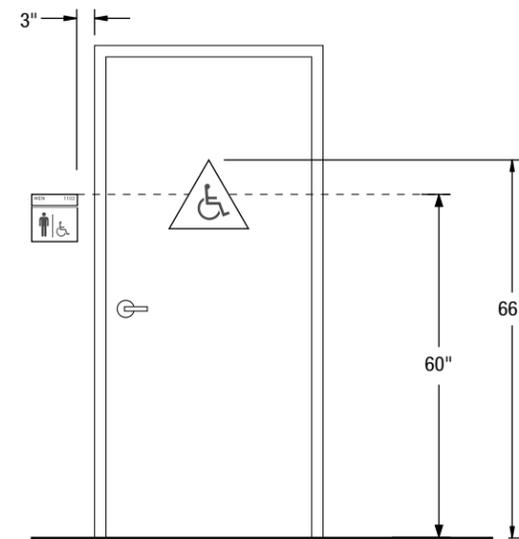


C MENS RESTROOM DOOR - SIGN TYPE ST36 AND ST80
SCALE: 3/8" = 1'

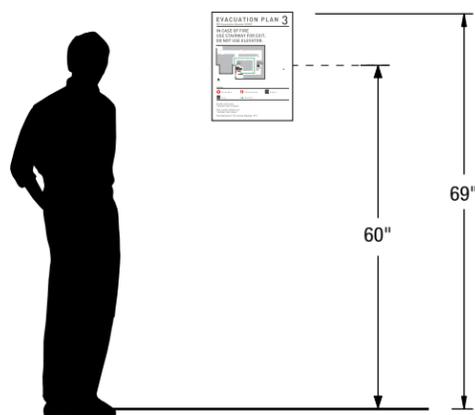

D EVACUATION MAP - SIGN TYPE B75
SCALE: 3/8" = 1'

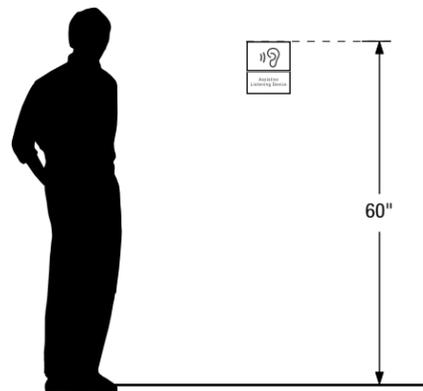

E ASSISTIVE LISTENING DEVICE - SIGN TYPE B60
SCALE: 3/8" = 1'

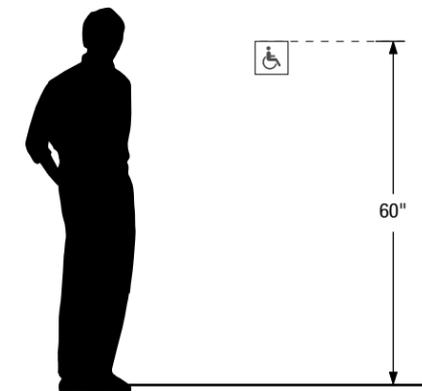

F ACCESSIBLE ID - SIGN TYPE B92
SCALE: 3/8" = 1'

FILE PATH Q:\UCR MRB1\20180426 UCR Contract\Renderings, Submittals & PDFs\Submittals\Archive\UCR MRB1_Interior Code Signs



CONTACT
Albuquerque / Phoenix
P 505.888.2901 ext 109
F 505.888.2902
csbsigns.com

DRAWN BY
Lawrence Spingola
Lawrence.Spingola@csbsigns.com
This artwork and design is owned by Century Sign Builders unless expressly stated. Use of this document or the design shown here without permission is prohibited.

CLIENT / PROJECT
Client / GC: Hensel Phelps
Project: University of California, Riverside - MRB1



APPROVAL REQUIRED FOR PRODUCTION
SIGNATURE / DATE

DATE
Modification Date: July 24, 2018 4:03 PM


SHEET TITLE
Install Guidelines
Restrooms, Evac Maps, ALD,
Accessible ID

SHEET
30

TYPICAL STAIRWELL SIGNAGE

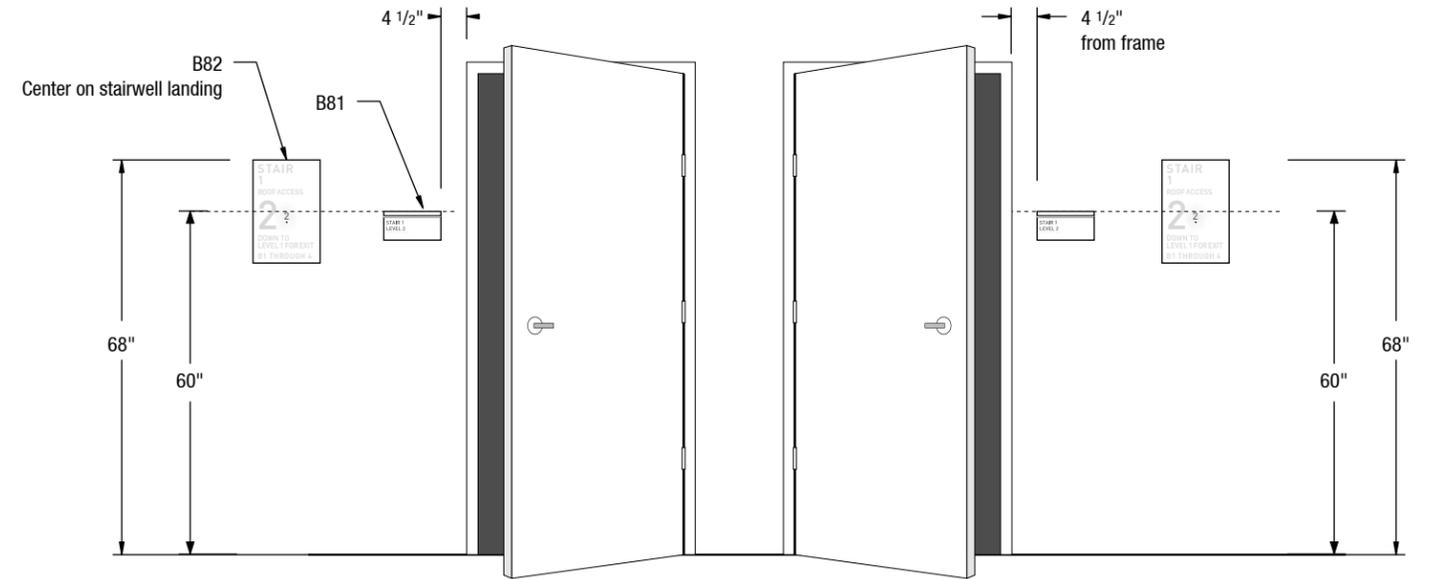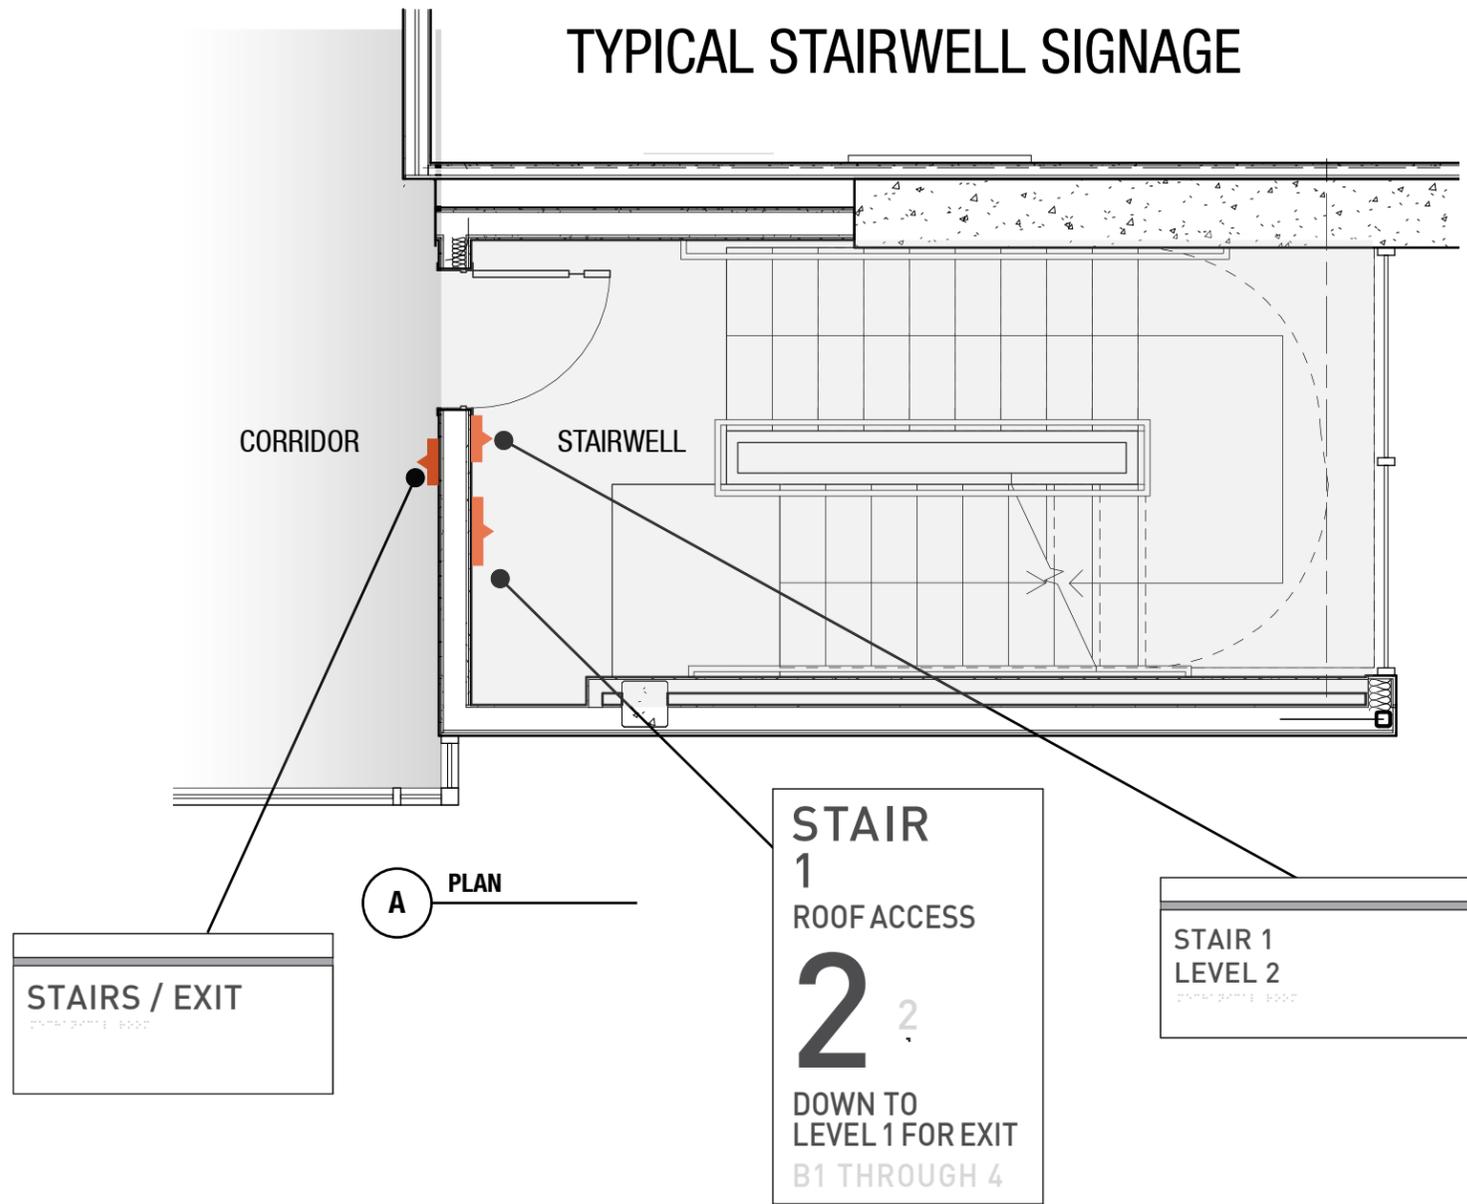

B STAIRWELL LANDING - SIGN TYPE B81 AND B82
SCALE: 3/8" = 1'

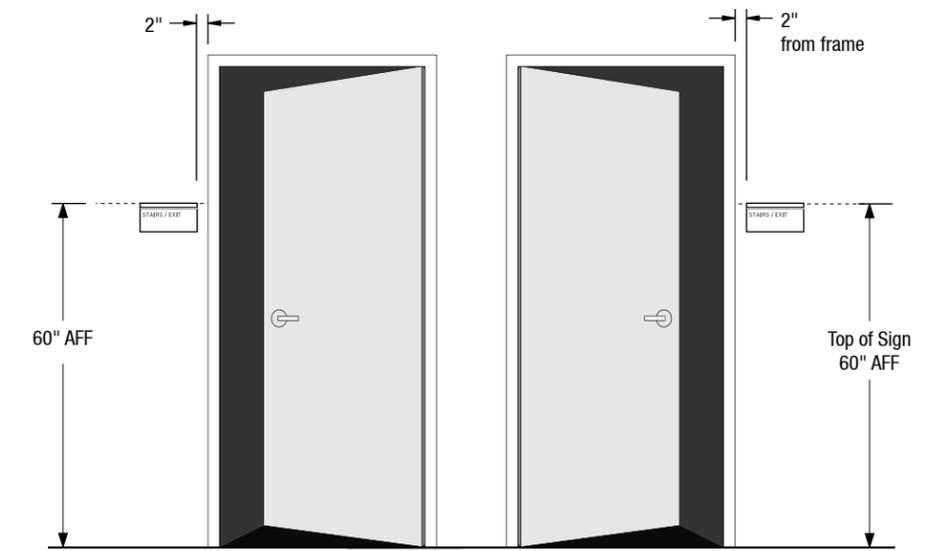


C SIGN TYPE B81 -STAIR DOOR
SCALE: 3/8" = 1'

FILE PATH Q:\UCR MRB1\20180426 UCR Contract\Renderings, Submittals & PDFs\Submittals\Archive\UCR MRB1_Interior Code Signs

| CONTACT | DRAWN BY | CLIENT / PROJECT | DATE | SHEET TITLE | SHEET |
|---|---|--|--|-----------------------------------|-----------|
| Albuquerque / Phoenix P 505.888.2901 ext 109 F 505.888.2902 csbsigns.com | Lawrence Spingola Lawrence Spingola@csbsigns.com This artwork and design is owned by Century Sign Builders unless expressly stated. Use of this document or the design shown here without permission is prohibited. | Client / GC: Hensel Phelps Project: University of California, Riverside - MRB1 APPROVAL REQUIRED FOR PRODUCTION | Modification Date: July 24, 2018 4:03 PM | Install Guidelines Stair Signs | 31 |
| | | SIGNATURE / DATE | | | |



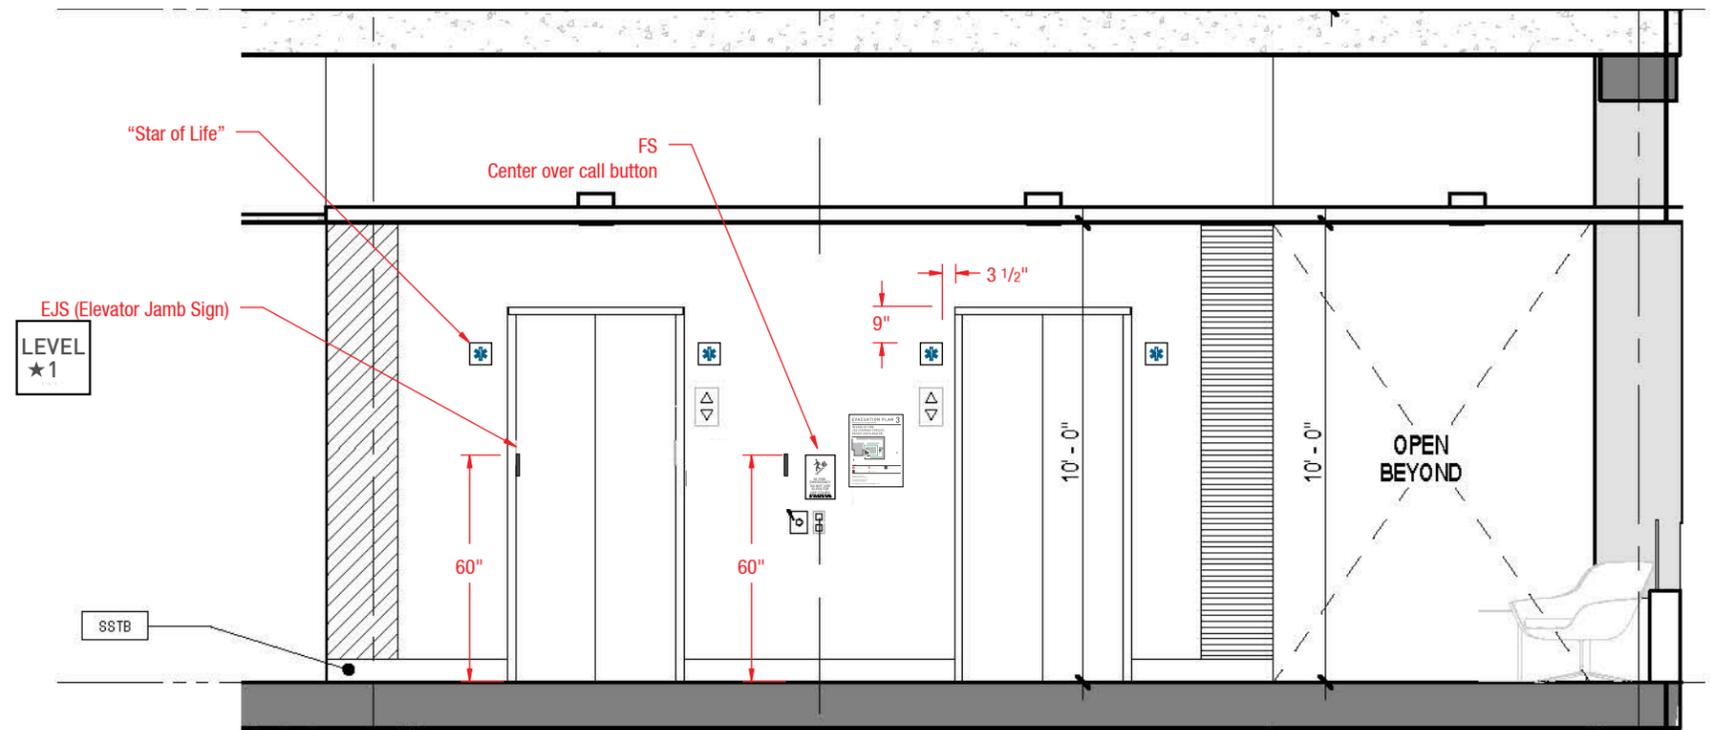


A **ELEVATOR BAY SIGNS - SIGN TYPE FS (FIRE SAFETY), EJS (ELEVATOR JAMB), B75 EVAC MAP, STAR OF LIFE**
 SCALE: 1/4" = 1'

FILE PATH Q:\UCR MRB1\20180426 UCR Contract\Renderings, Submittals & PDFs\Submittals\Archive\UCR MRB1_Interior Code Signs

| CONTACT | DRAWN BY | CLIENT / PROJECT | DATE | SHEET TITLE | SHEET |
|---|--|--|--|---|-----------|
| Albuquerque / Phoenix P 505.888.2901 ext 109 F 505.888.2902 csbsigns.com | Lawrence Spingola Lawrence Spingola@csbsigns.com <small>This artwork and design is owned by Century Sign Builders unless expressly stated. Use of this document or the design shown here without permission is prohibited.</small> | Client / GC: Hensel Phelps Project: University of California, Riverside - MRB1 APPROVAL REQUIRED FOR PRODUCTION | Modification Date: July 24, 2018 4:03 PM SIGNATURE / DATE | Install Guidelines Elevator Bay | 32 |




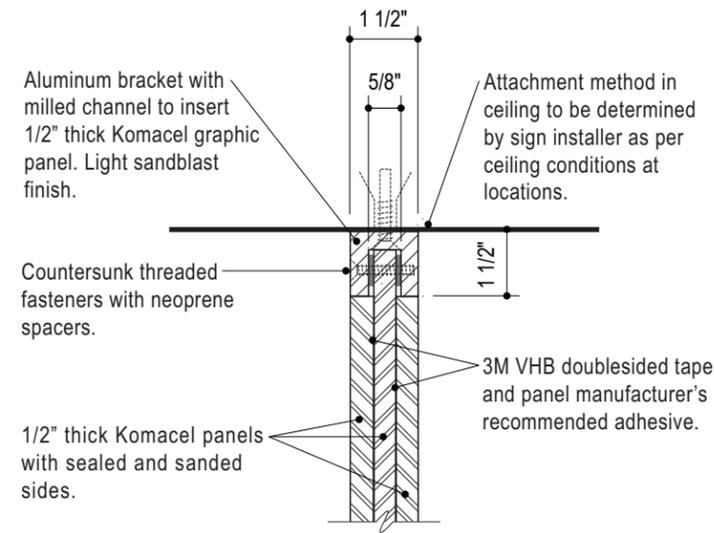

(A) SECTION | 3"=1'-0"


GENERAL NOTES:

1. Copy shown as typical layouts only, actual layouts to be determined and or verified prior to fabrication.
2. Sign installer to verify existing mounting conditions and use appropriate attachment method as per condition.

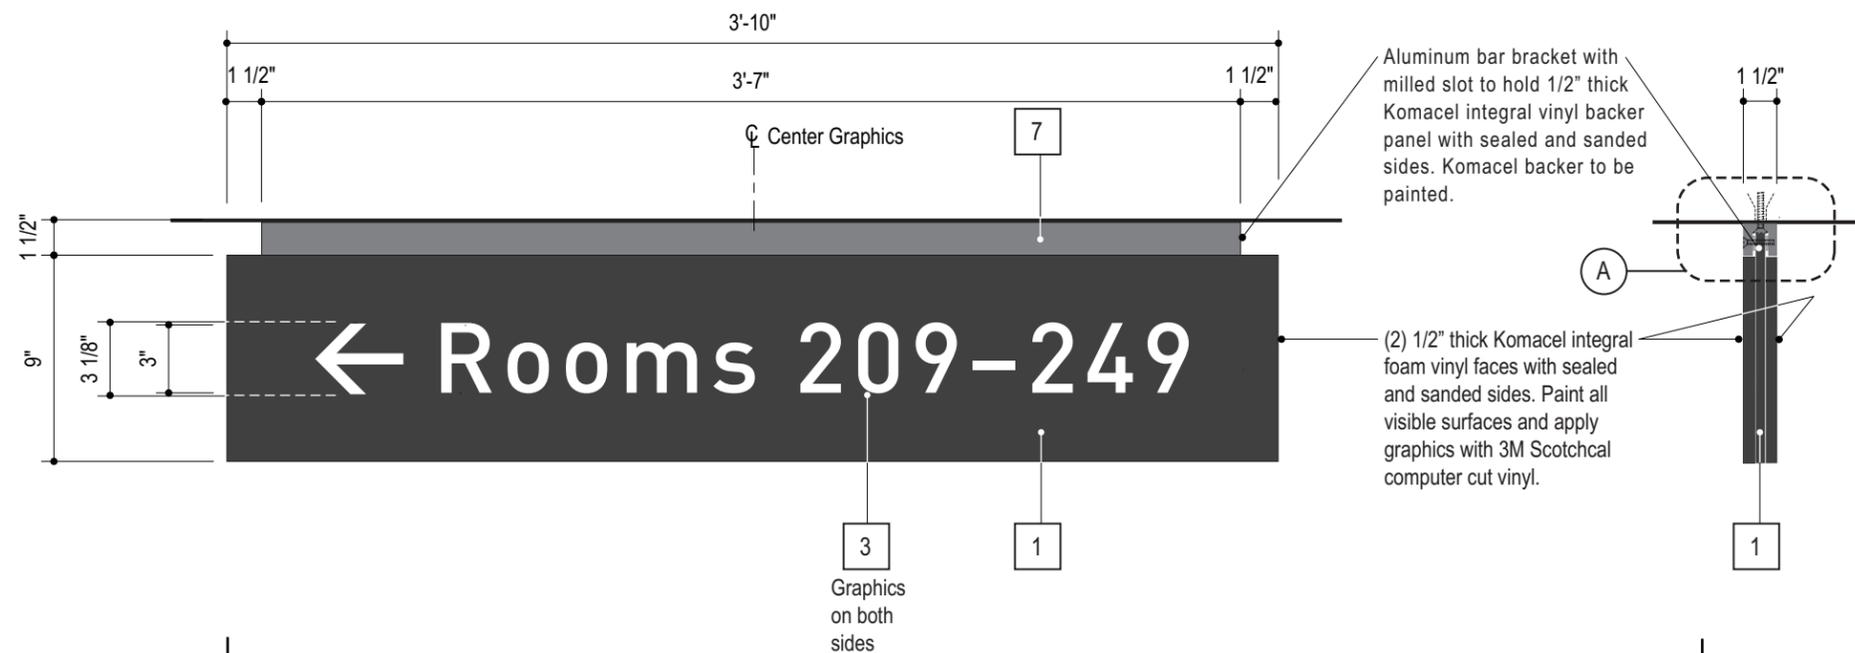


ELEVATION | 1 1/2"=1'-0"

SIDE VIEW | 1 1/2"=1'-0"

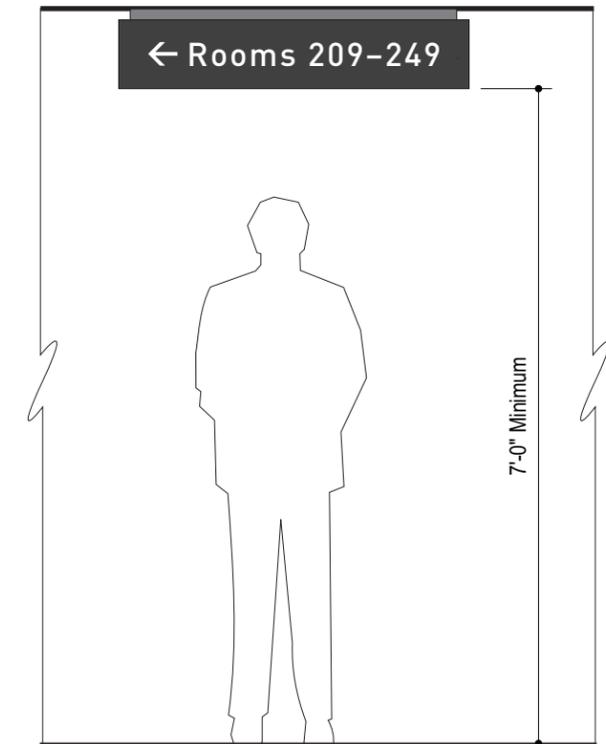

LOCATION ELEVATION | 1/2"=1'-0"

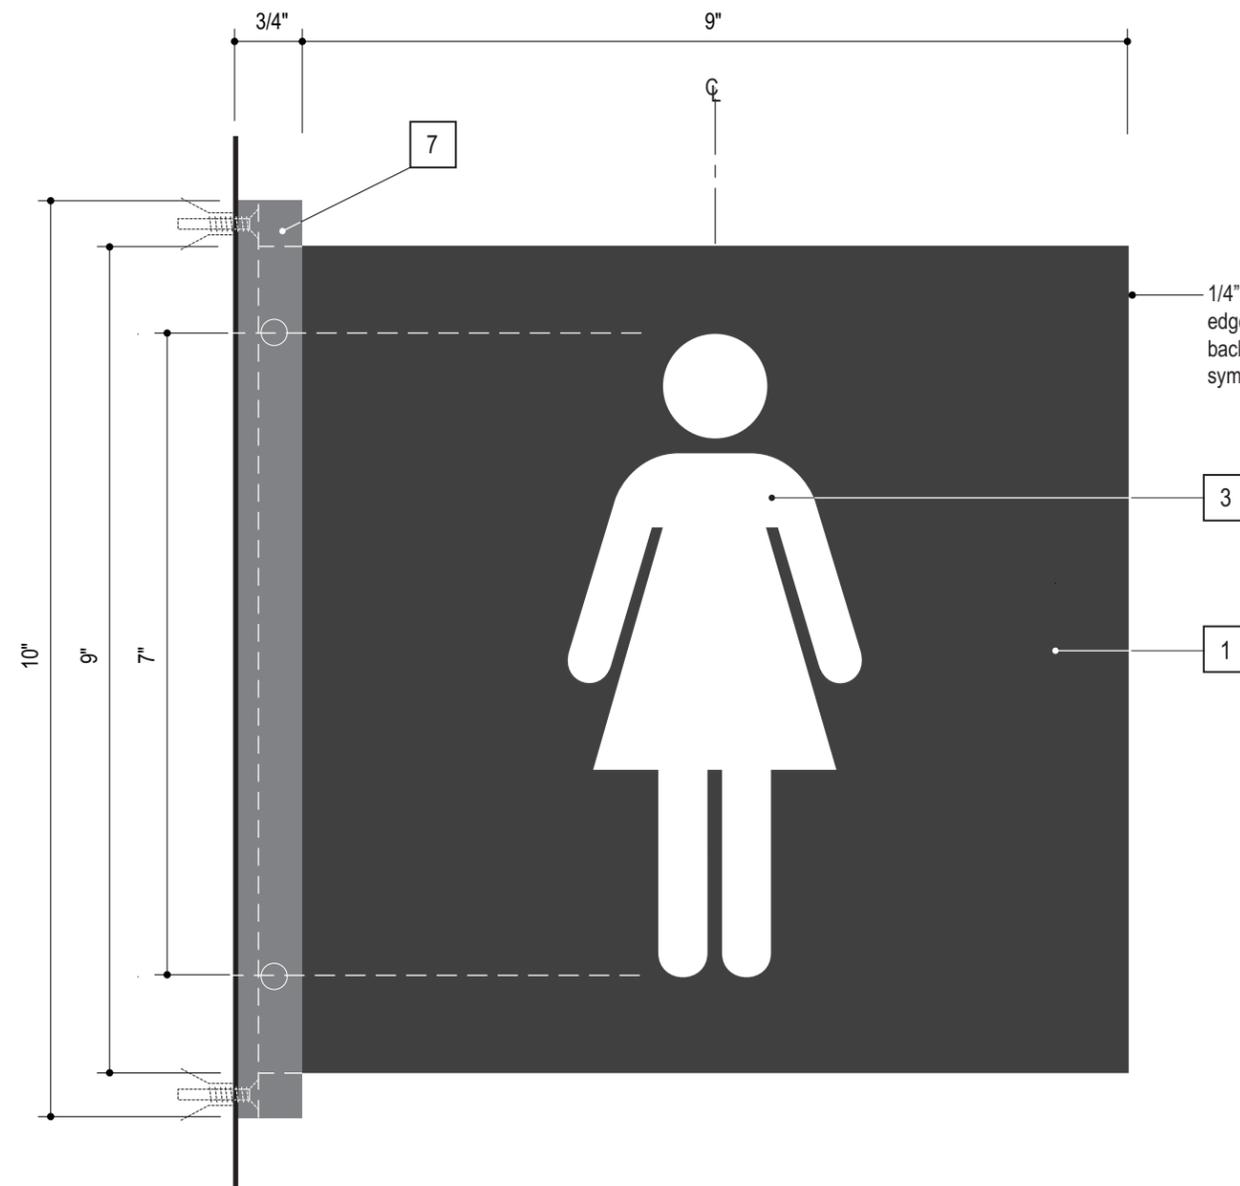


ELEVATION | HALF SIZE

1/4" thick acrylic sanded edges. Surface painted background and 3M vinyl symbol.

3 Symbol on both sides

1

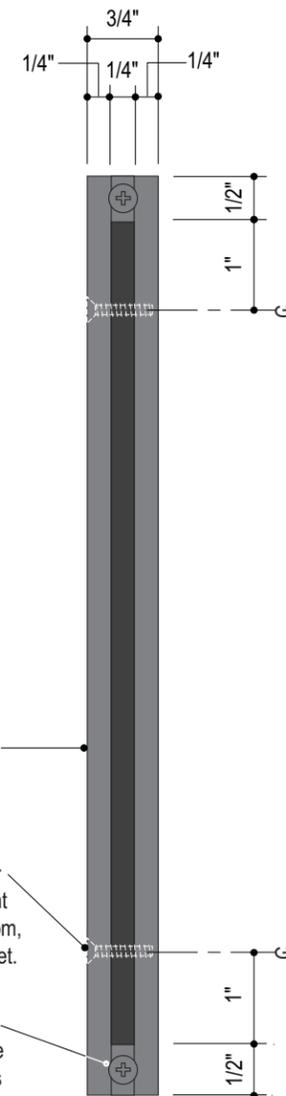

Aluminum bracket with milled channel to insert acrylic graphic panel.


Drill and tap bracket for countersunk attachment screws at top and bottom, painted to match bracket.

Countersunk mounting screws with appropriate expansion wall anchors located at top and bottom of bracket.

SIDE VIEW | HALF SIZE

GENERAL NOTES:


1. Copy shown as typical layouts only, actual layouts to be determined and or verified prior to fabrication.
2. Sign installer to verify existing mounting conditions and use appropriate attachment method as per condition.

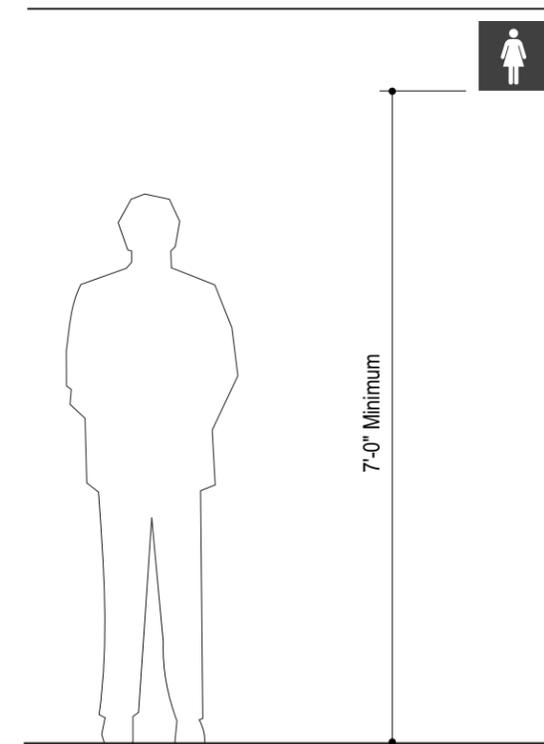


LOCATION ELEVATION | 1/2"=1'-0"

GENERAL NOTES:


1. Copy shown as typical layouts only, actual layouts to be determined and or verified prior to fabrication.
2. Sign installer to verify existing mounting conditions and use appropriate attachment method as per condition.
3. Braille shall be Calif Grade 2 (Contracted Braille).
4. An inverted "L" shall precede all numbers in Braille.

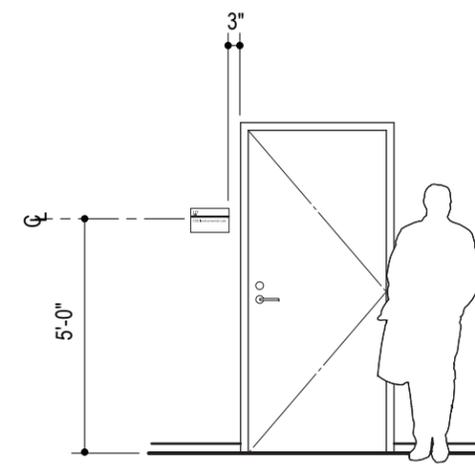

LOCATION ELEVATION | 1/4"=1'-0"

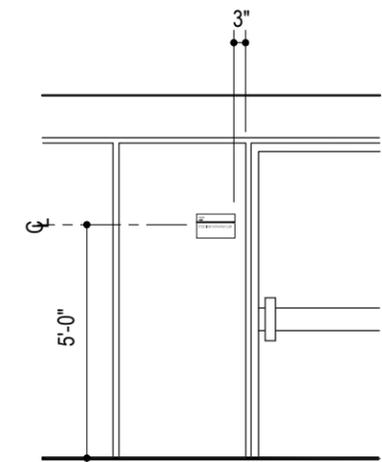

ALTERNATE GLASS MOUNTING | 1/4"=1'-0"

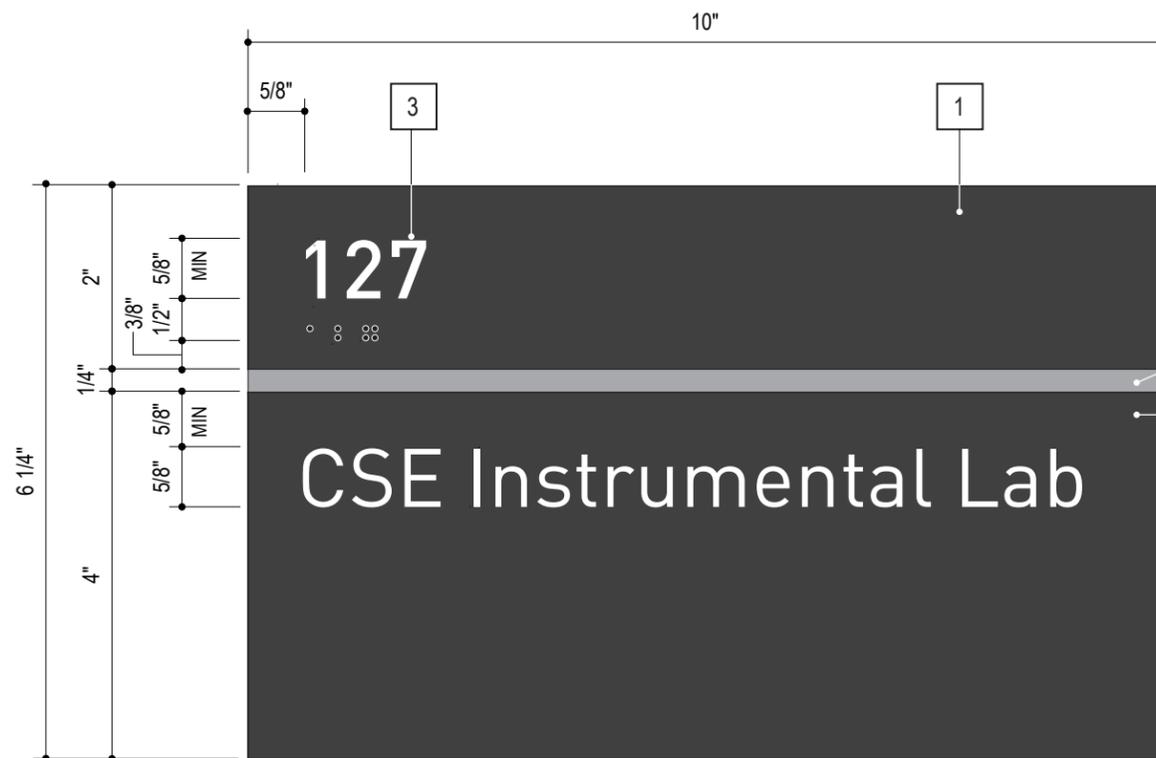


ELEVATION | HALF SIZE

1/4" thick photopolymer etched panel with 1/32" raised copy, California grade 2 braille.

1/4" x 1/4" square aluminum bar raised 1/8" above etched background and eased edges. Attached with concealed fasteners threaded and taped from back light sandblast finish.


Separate changeable bottom panel 1/16" thick New Hermes Gravoply II panel laminated to 1/8" acrylic panel. Copy to be engraved and panel sides to be painted to match slate gray.

1/16" thick acrylic backer panel permanently mounted to wall with 3M VHB tape and silicone. Paint sides to match adjacent sides.

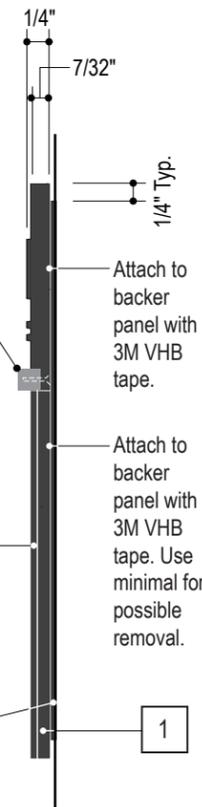

SIDE VIEW | HALF SIZE

Separate changeable bottom panel 1/16" thick New Hermes Gravoply II panel laminated to 1/8" acrylic panel. Copy to be engraved and panel sides to be painted to match slate gray.

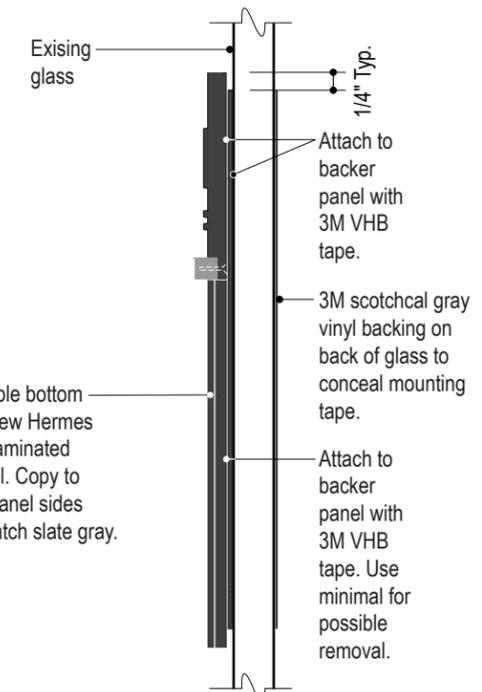

SIDE VIEW (GLASS MOUNT) | HALF SIZE


Updated 11/02/09

SUPERSEDED


**Refer to INTERIOR SIGNAGE PROGRAM for
Multidisciplinary Research Building (MRB)**

GENERAL NOTES:


1. Copy shown as typical layouts only, actual layouts to be determined and or verified prior to fabrication.
2. Sign installer to verify existing mounting conditions and use appropriate attachment method as per condition.
3. Braille shall be Calif Grade 2 (Contracted Braille)
4. An inverted "L" shall precede all numbers in Braille.

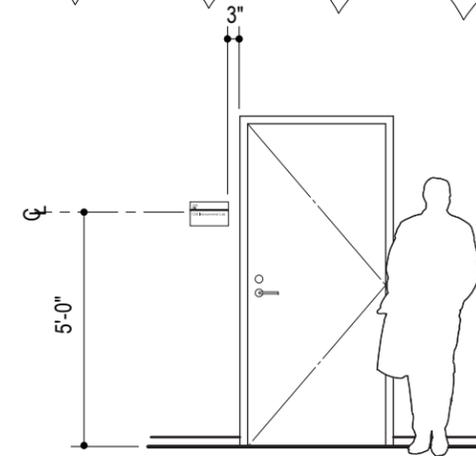


LOCATION ELEVATION | 1/4"=1'-0"

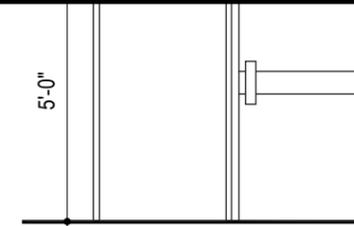


ALTERNATE GLASS MOUNTING | 1/4"=1'-0"

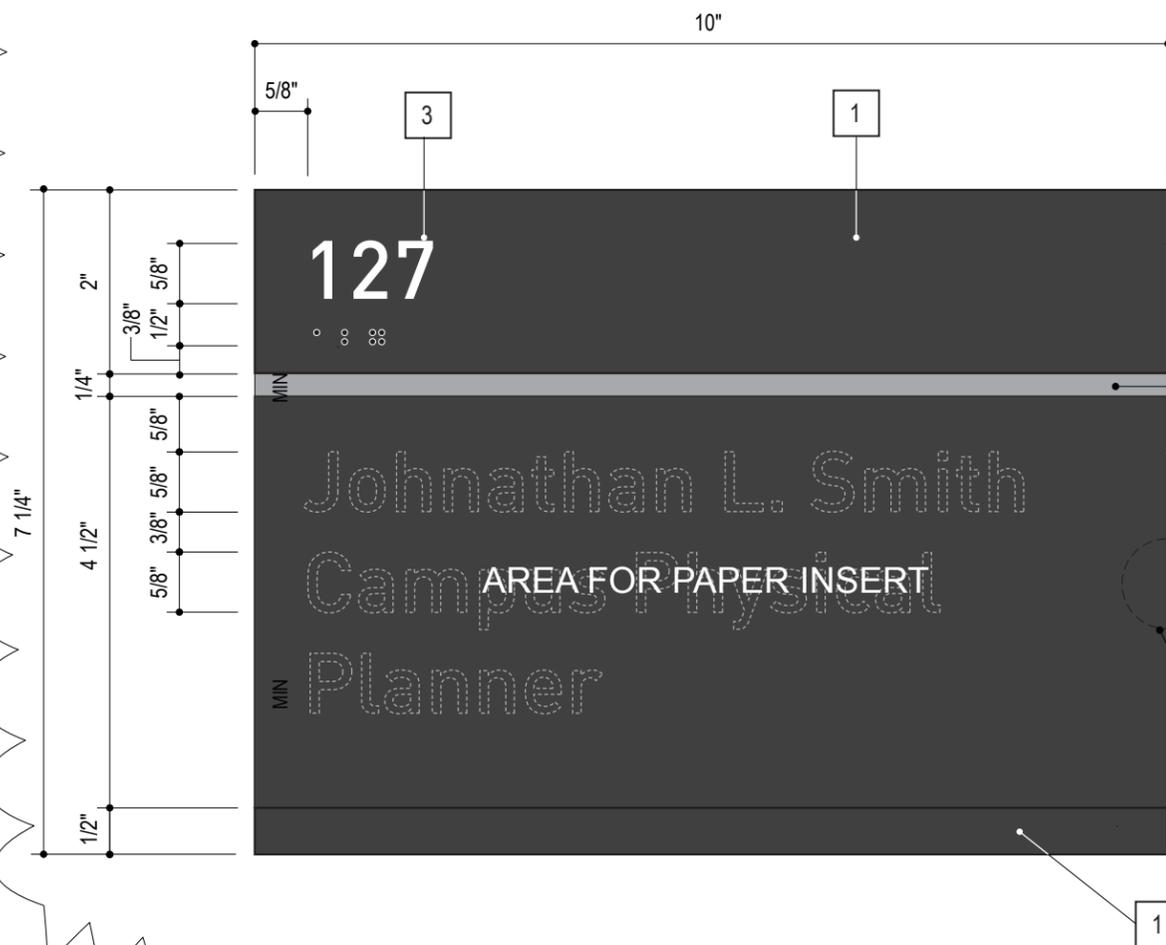


ELEVATION | HALF SIZE

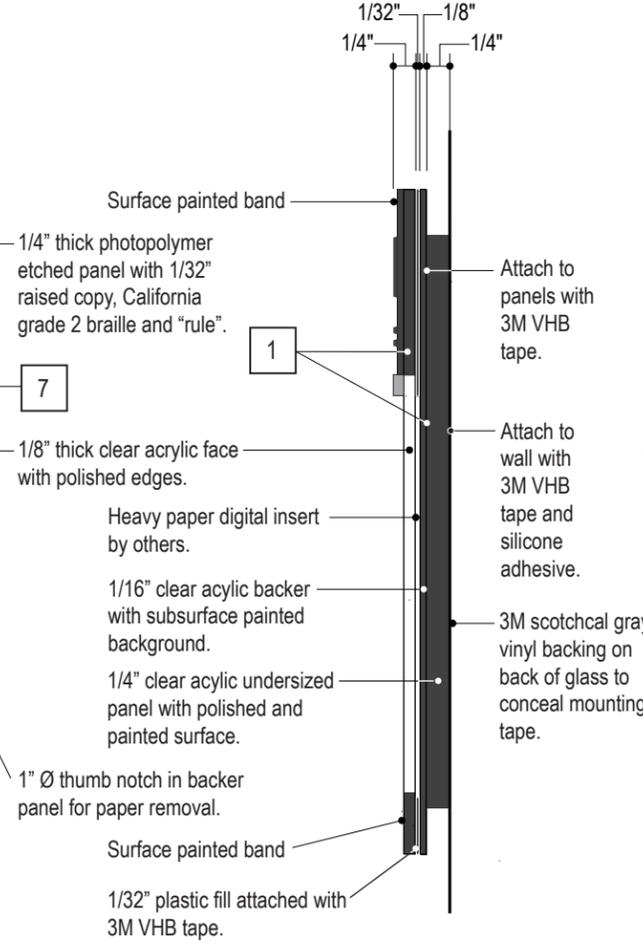

SIDE VIEW | HALF SIZE

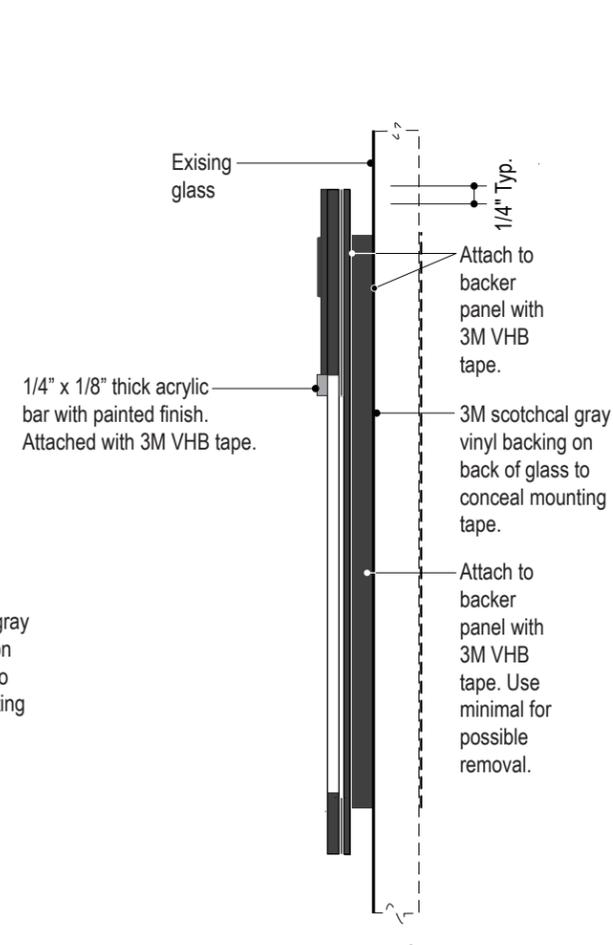

SIDE VIEW (GLASS MOUNT) | HALF SIZE

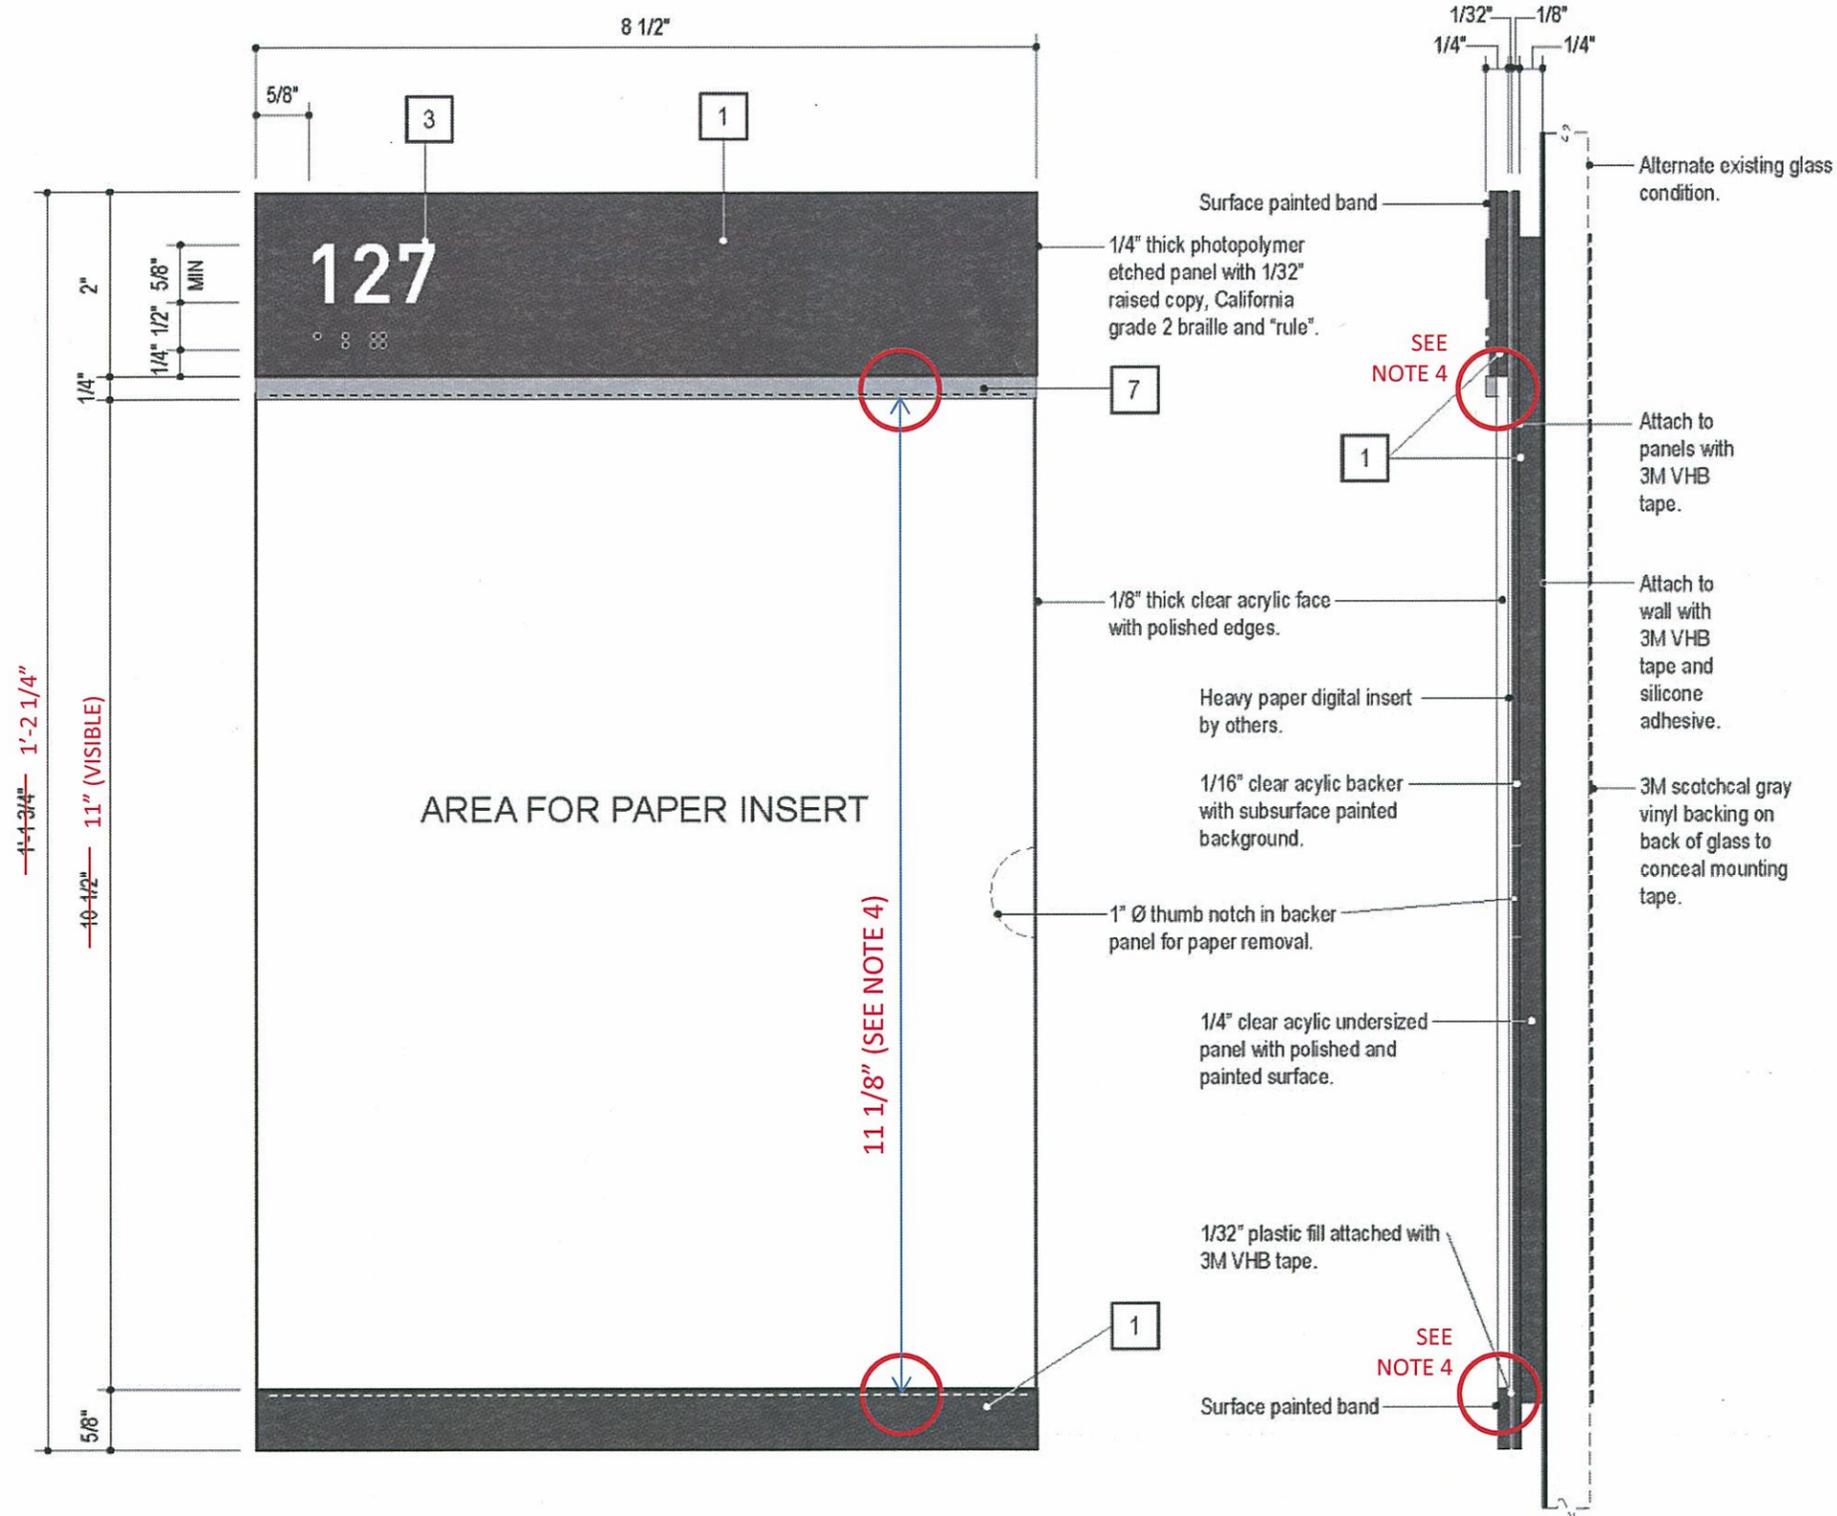

ELEVATION HALF SIZE


SIDE VIEW HALF SIZE

SUPERSEDED

Refer to INTERIOR SIGNAGE PROGRAM for Multidisciplinary Research Building (MRB)


appropriate attachment method as per condition.

- 3. Braille shall be Calif Grade 2 (Contracted Braille).
- 4. 1/16" tolerance provided at top and bottom for paper insert

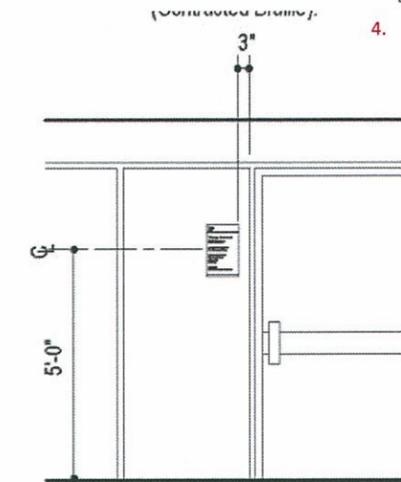

ALTERNATE GLASS MOUNTING 1/4"=1'-0"

- 5. An inverted "L" shall precede all numbers in Braille.

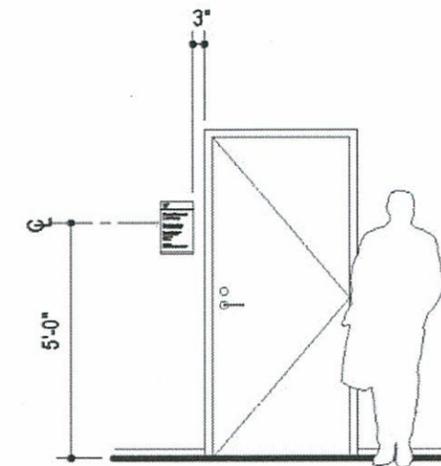


LOCATION ELEVATION 1/4"=1'-0"

CORRECTION TO CAMPUS SIGN PROGRAM
DRAWING 1.63X (REPLACES DRAWING 1.63)

AUTHORIZED BY:

Timothy Ralston
JULY 12, 2011

TIMOTHY RALSTON
ASSOCIATE VICE CHANCELLOR
CAPITAL RESOURCE MANAGEMENT
UNIVERSITY OF CALIFORNIA, RIVERSIDE

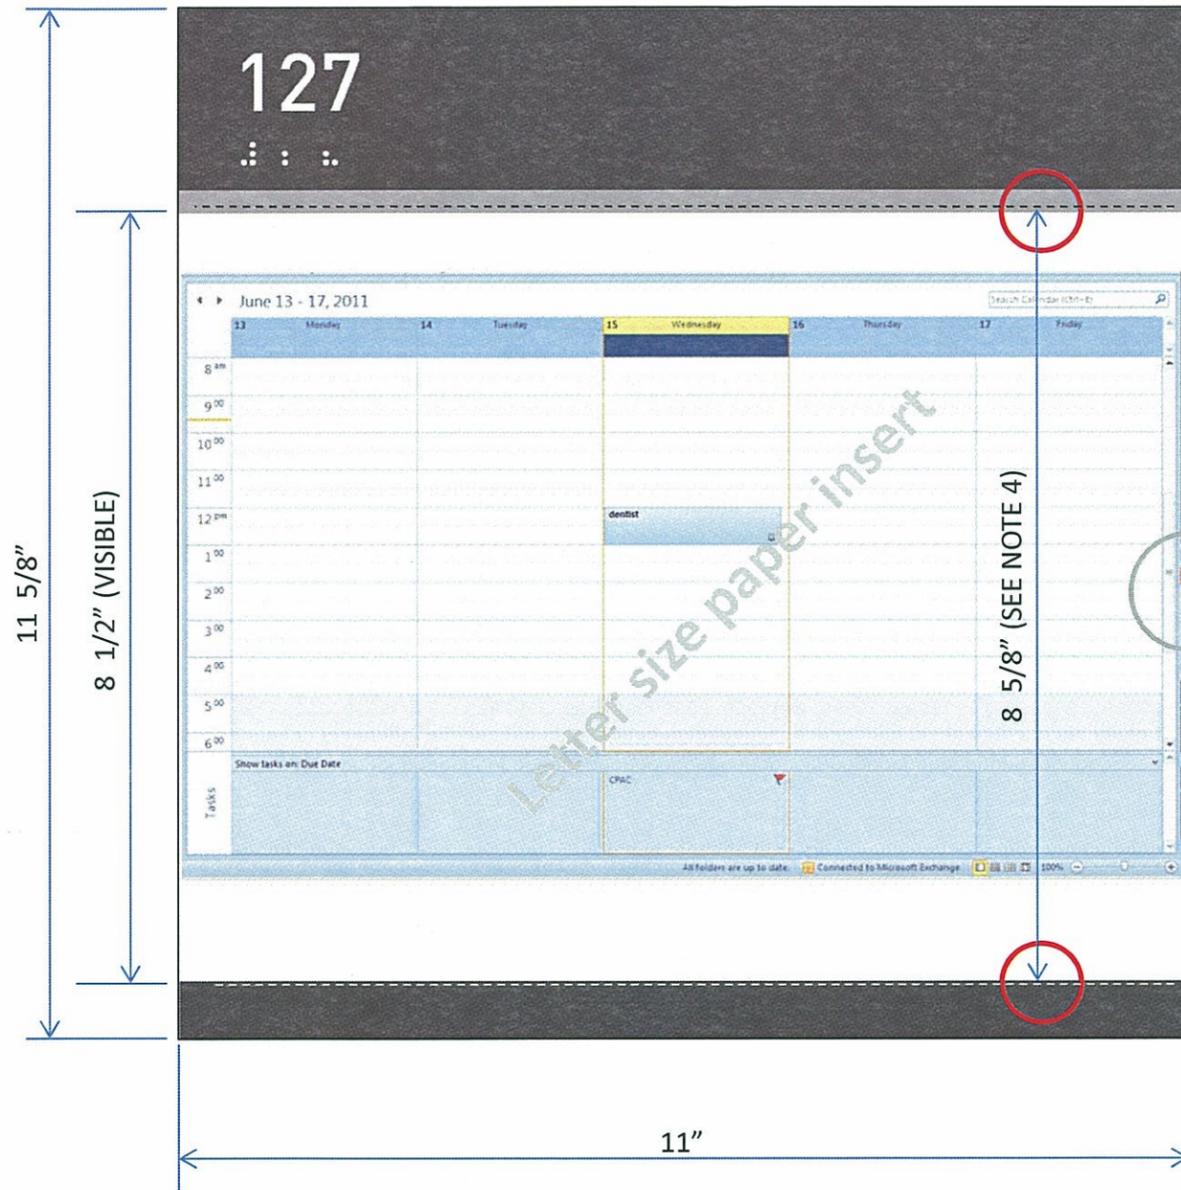

GENERAL NOTES:

1. This sign is to be fabricated identical to sign type B32 in all respects with the exception of the following:
 - a. Overall width will be 11"
 - b. Overall height will be 11 5/8"
2. For all additional details refer to DWG. 1.63X of the 2008 CAMPUS SIGN PROGRAM

ELEVATION | HALF SIZE

AMENDMENT TO CAMPUS SIGN PROGRAM
 DRAWING 1.63A FOR SIGN TYPE B32A

AUTHORIZED BY:

Timothy Ralston
 JULY 12, 2011



TIMOTHY RALSTON
 ASSOCIATE VICE CHANCELLOR
 CAPITAL RESOURCE MANAGEMENT
 UNIVERSITY OF CALIFORNIA, RIVERSIDE

GENERAL NOTES:

1. Copy shown as typical layouts only, actual layouts to be determined and or verified prior to fabrication.
2. Sign installer to verify existing mounting conditions and use appropriate attachment method as per condition.
3. Braille shall be Calif Grade 2 (Contracted Braille).
4. An inverted "L" shall precede all numbers in Braille.


SUPERSEDED

Refer to INTERIOR SIGNAGE PROGRAM for Multidisciplinary Research Building (MRB)

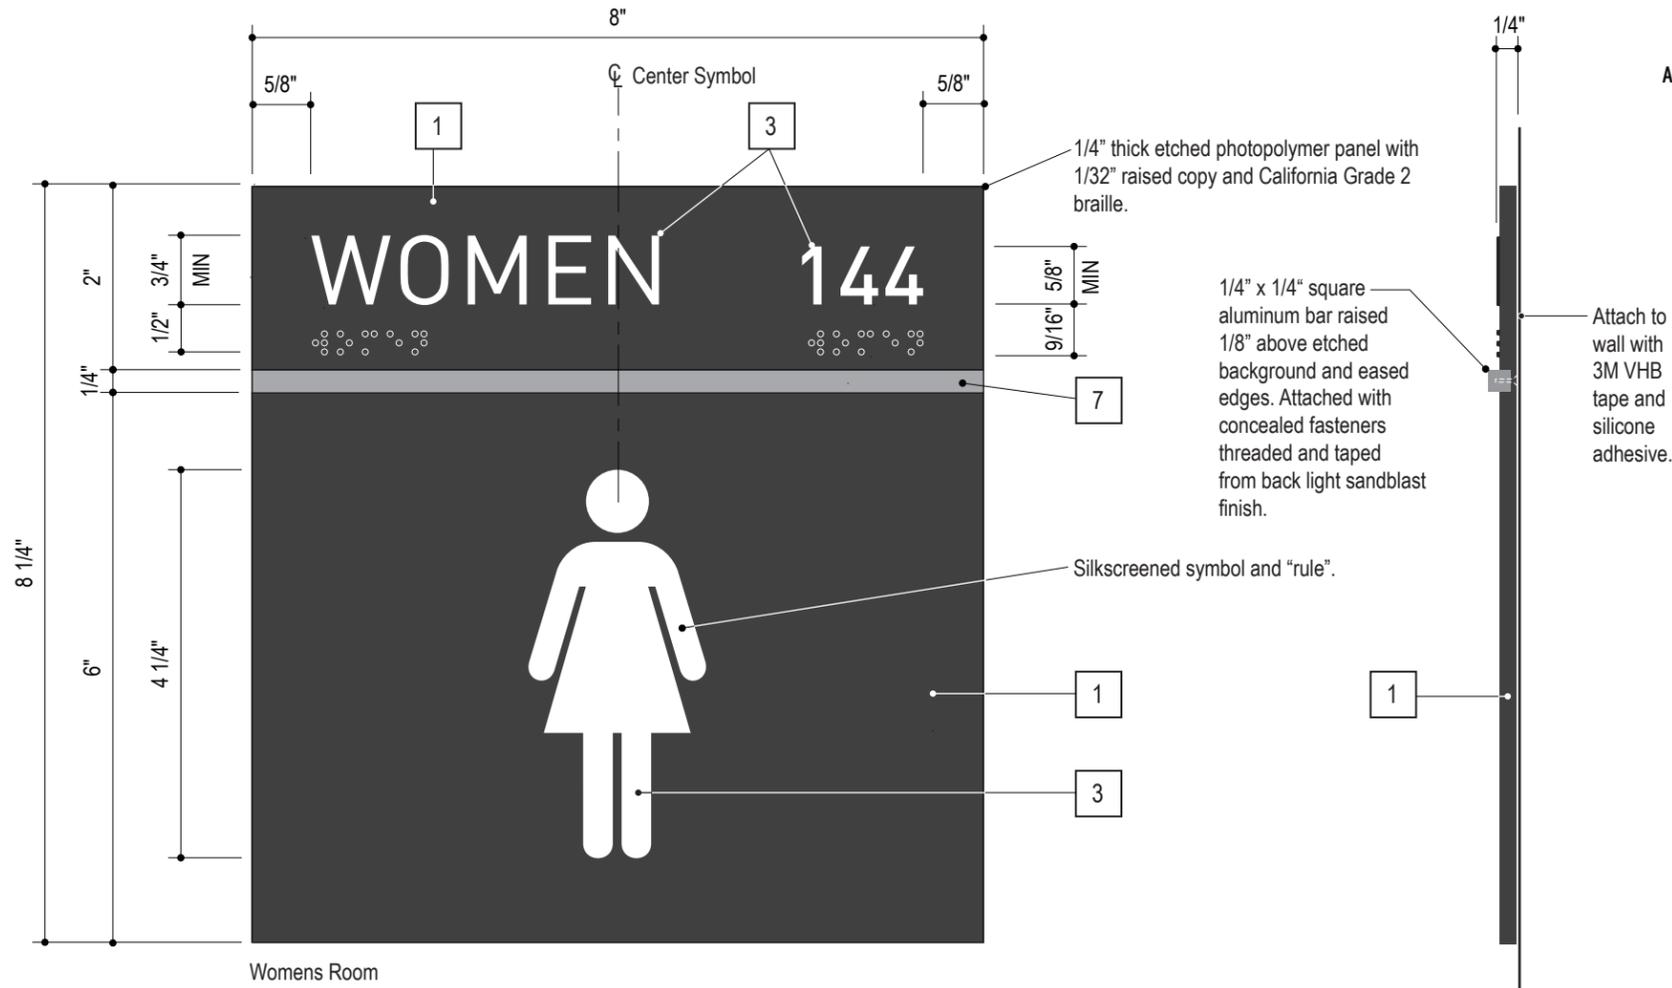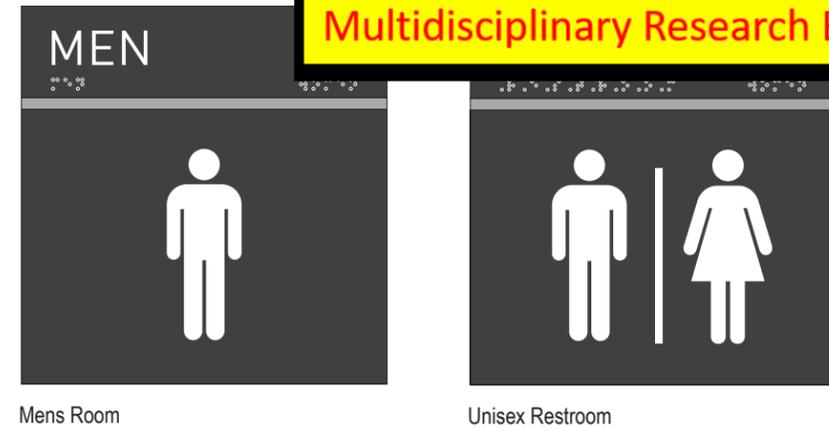


ADDITIONAL LAYOUTS

3"=1'-0"

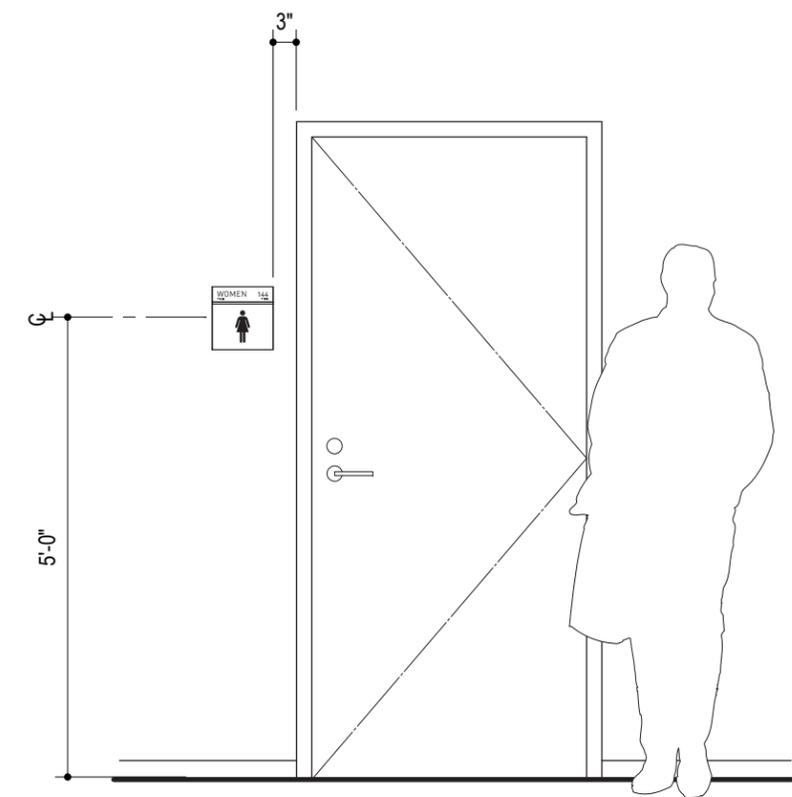


GENERAL NOTES:


1. Copy shown as typical layouts only, actual layouts to be determined and or verified prior to fabrication.
2. Sign installer to verify existing mounting conditions and use appropriate attachment method as per condition.

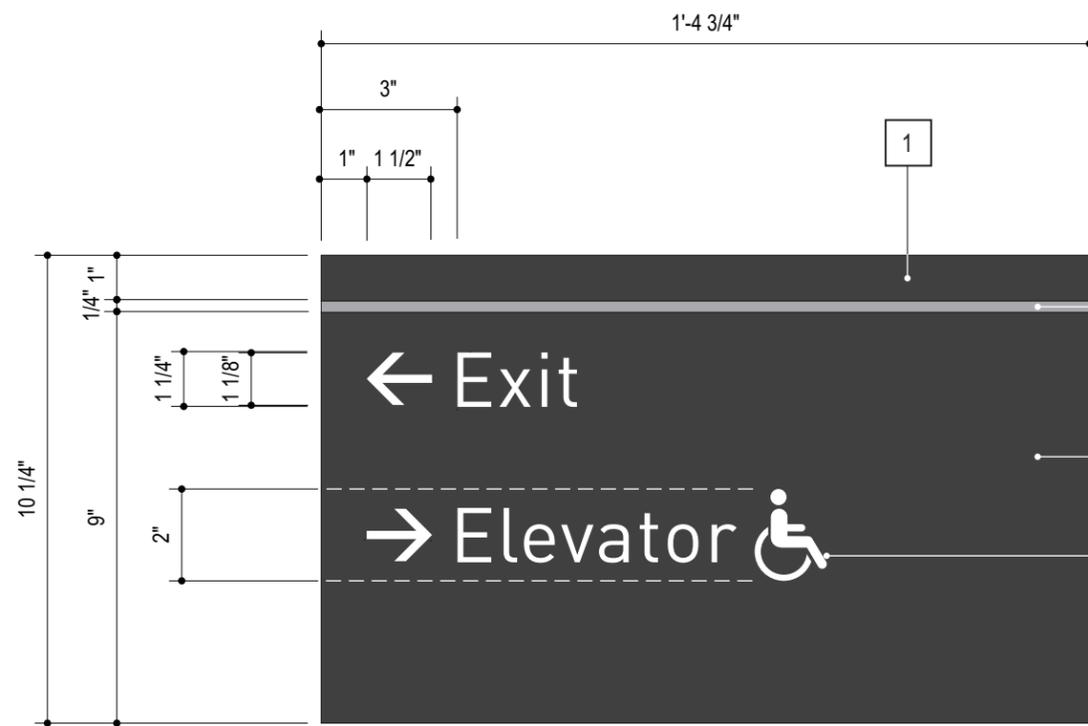

ELEVATION | 3"=1'-0"

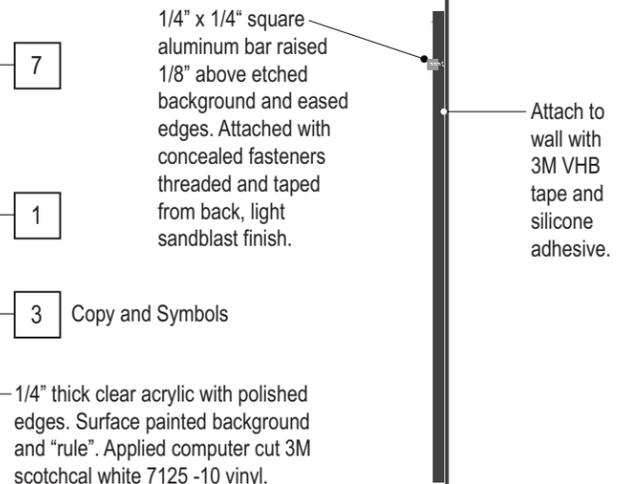

SIDE VIEW | 3"=1'-0"

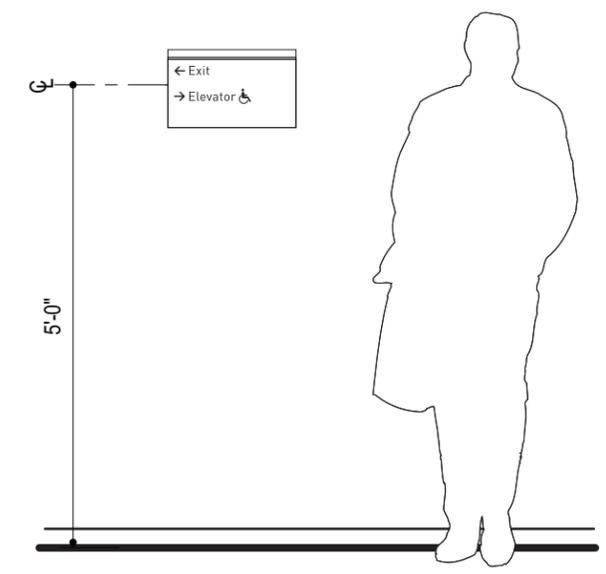

LOCATION ELEVATION | 1/2"=1'-0"


1/4" x 1/4" square aluminum bar raised 1/8" above etched background and eased edges. Attached with concealed fasteners threaded and taped from back, light sandblast finish.

Attach to wall with 3M VHB tape and silicone adhesive.

1

3 Copy and Symbols

1/4" thick clear acrylic with polished edges. Surface painted background and "rule". Applied computer cut 3M scotchcal white 7125 -10 vinyl.

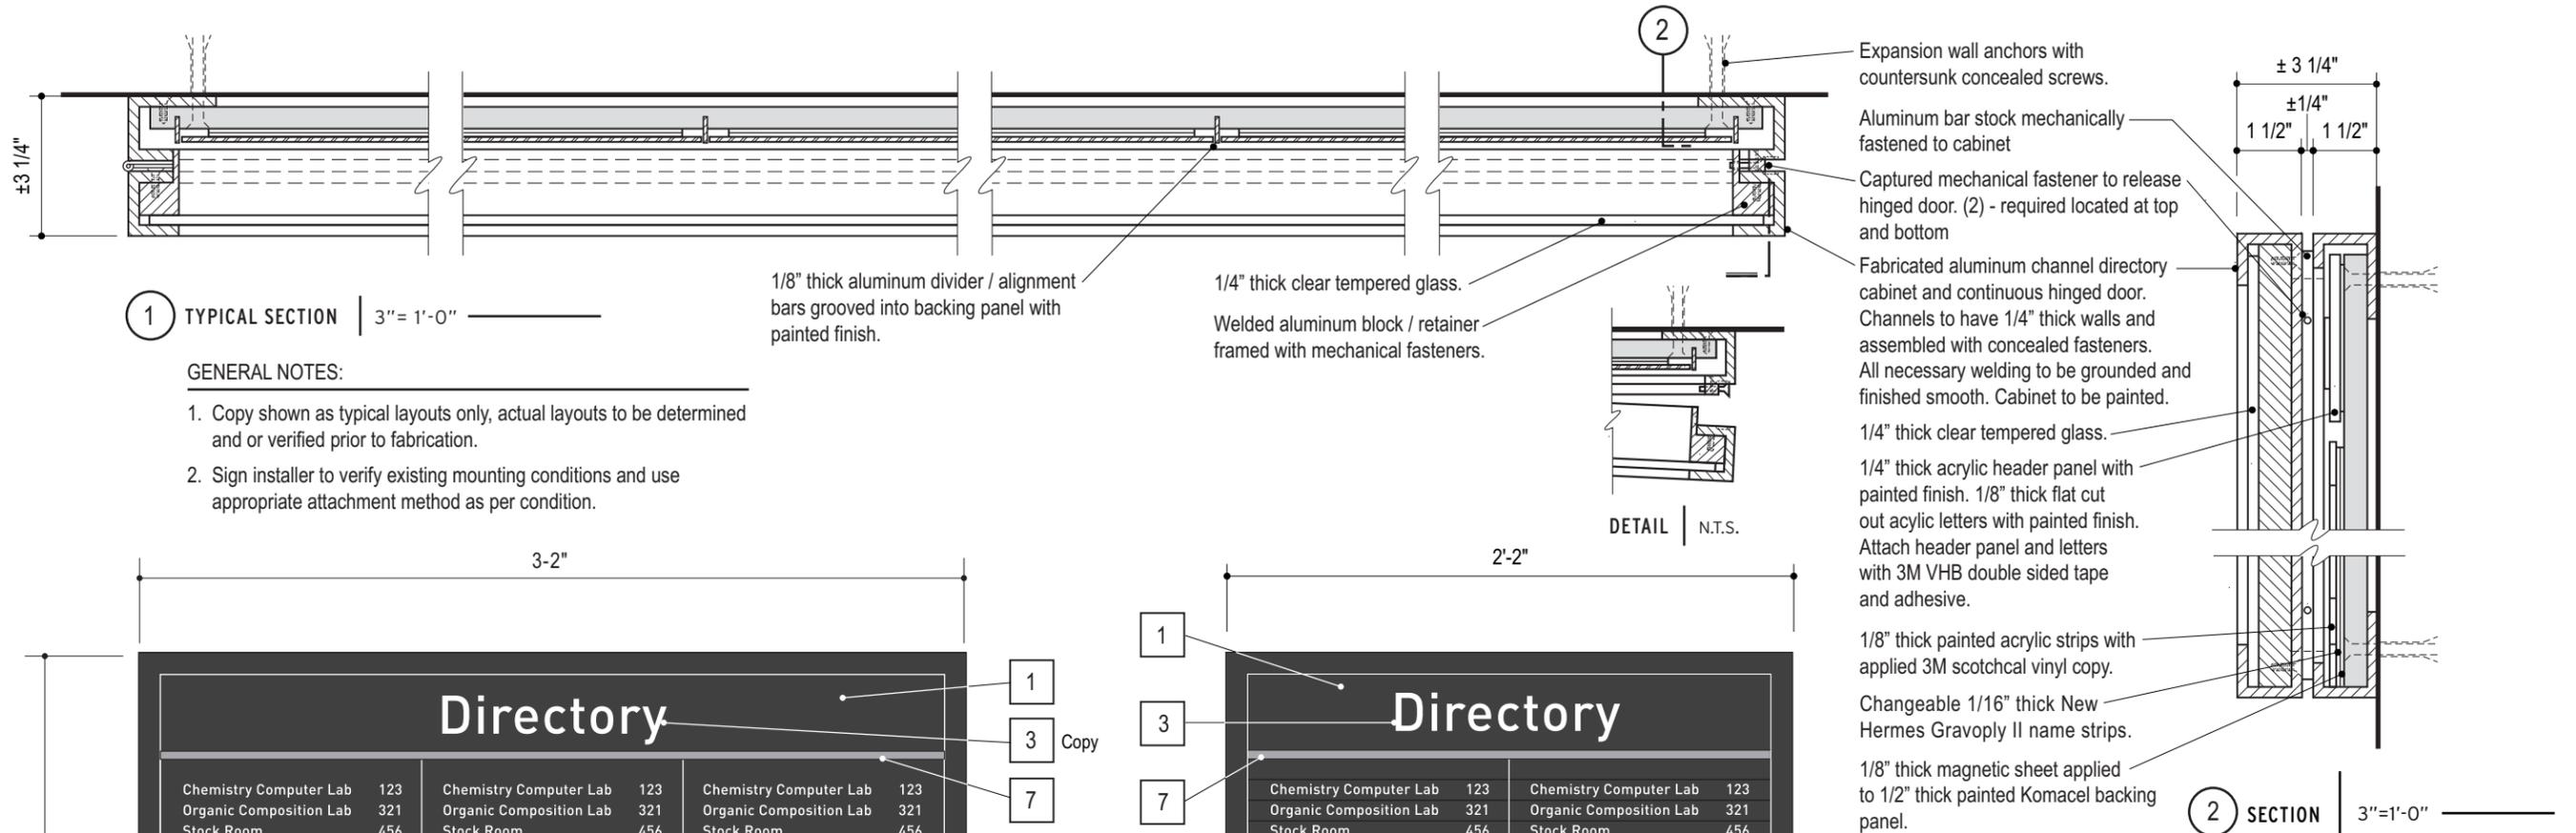

1

3'-2"

1

3'-2"

1

3

7

7

1

6

Fabricated aluminum cabinet with clear tempered glass face. Hinged door to be locked mechanically with concealed captured screws/pins top and bottom on side of cabinet. Cabinet to be painted on all visible surfaces.

Changeable New Hermes Gravoply II name strips.

| | | | | | |
|--------------------------|-----|--------------------------|-----|--------------------------|-----|
| Chemistry Computer Lab | 123 | Chemistry Computer Lab | 123 | Chemistry Computer Lab | 123 |
| Organic Composition Lab | 321 | Organic Composition Lab | 321 | Organic Composition Lab | 321 |
| Stock Room | 456 | Stock Room | 456 | Stock Room | 456 |
| Graduate Students Office | 654 | Graduate Students Office | 654 | Graduate Students Office | 654 |
| Instrumentation Room | 415 | Instrumentation Room | 415 | Instrumentation Room | 415 |
| Chemistry Computer Lab | 123 | Chemistry Computer Lab | 123 | Chemistry Computer Lab | 123 |
| Organic Composition Lab | 321 | Organic Composition Lab | 321 | Organic Composition Lab | 321 |
| Stock Room | 456 | Stock Room | 456 | Stock Room | 456 |
| Graduate Students Office | 654 | Graduate Students Office | 654 | Graduate Students Office | 654 |
| Instrumentation Room | 415 | Instrumentation Room | 415 | Instrumentation Room | 415 |
| Chemistry Computer Lab | 123 | Chemistry Computer Lab | 123 | Chemistry Computer Lab | 123 |
| Organic Composition Lab | 321 | Organic Composition Lab | 321 | Organic Composition Lab | 321 |
| Stock Room | 456 | Stock Room | 456 | Stock Room | 456 |
| Graduate Students Office | 654 | Graduate Students Office | 654 | Graduate Students Office | 654 |
| Instrumentation Room | 415 | Instrumentation Room | 415 | Instrumentation Room | 415 |
| Chemistry Computer Lab | 123 | Chemistry Computer Lab | 123 | Chemistry Computer Lab | 123 |
| Organic Composition Lab | 321 | Organic Composition Lab | 321 | Organic Composition Lab | 321 |
| Stock Room | 456 | Stock Room | 456 | Stock Room | 456 |
| Graduate Students Office | 654 | Graduate Students Office | 654 | Graduate Students Office | 654 |
| Instrumentation Room | 415 | Instrumentation Room | 415 | Instrumentation Room | 415 |

(3) COLUMN ELEVATION | 1 1/2"=1'-0"

2

2'-2"

1

3

7

1


6

Fabricated aluminum cabinet with clear tempered glass face. Hinged door to be locked mechanically with concealed captured screws/pins top and bottom on side of cabinet. Cabinet to be painted on all visible surfaces.

Changeable New Hermes Gravoply II name strips.

| | | | |
|--------------------------|-----|--------------------------|-----|
| Chemistry Computer Lab | 123 | Chemistry Computer Lab | 123 |
| Organic Composition Lab | 321 | Organic Composition Lab | 321 |
| Stock Room | 456 | Stock Room | 456 |
| Graduate Students Office | 654 | Graduate Students Office | 654 |
| Instrumentation Room | 415 | Instrumentation Room | 415 |
| Chemistry Computer Lab | 123 | Chemistry Computer Lab | 123 |
| Organic Composition Lab | 321 | Organic Composition Lab | 321 |
| Stock Room | 456 | Stock Room | 456 |
| Graduate Students Office | 654 | Graduate Students Office | 654 |
| Instrumentation Room | 415 | Instrumentation Room | 415 |
| Chemistry Computer Lab | 123 | Chemistry Computer Lab | 123 |
| Organic Composition Lab | 321 | Organic Composition Lab | 321 |
| Stock Room | 456 | Stock Room | 456 |
| Graduate Students Office | 654 | Graduate Students Office | 654 |
| Instrumentation Room | 415 | Instrumentation Room | 415 |
| Chemistry Computer Lab | 123 | Chemistry Computer Lab | 123 |
| Organic Composition Lab | 321 | Organic Composition Lab | 321 |
| Stock Room | 456 | Stock Room | 456 |
| Graduate Students Office | 654 | Graduate Students Office | 654 |
| Instrumentation Room | 415 | Instrumentation Room | 415 |





(2) COLUMN ELEVATION | 1 1/2"=1'-0"

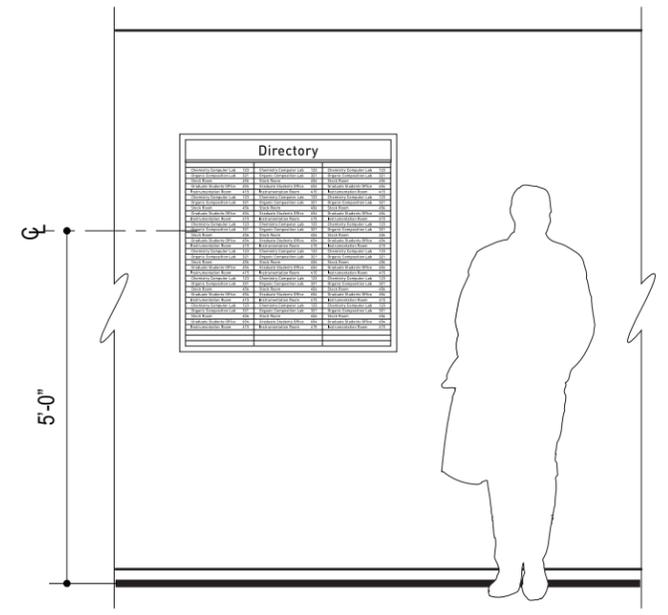

LOCATION ELEVATION | 3/8"=1'-0"

GENERAL NOTES:

1. Copy shown as typical layouts only, actual layouts to be determined and or verified prior to fabrication.
2. Sign installer to verify existing mounting conditions and use appropriate attachment method as per condition.

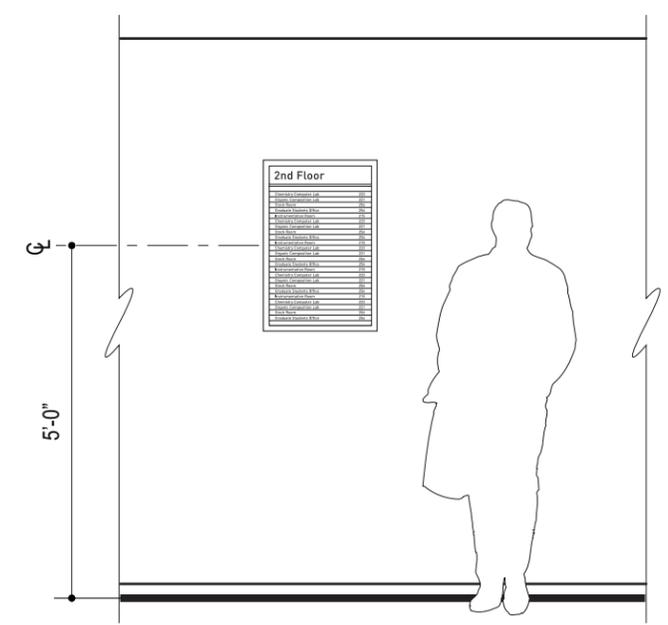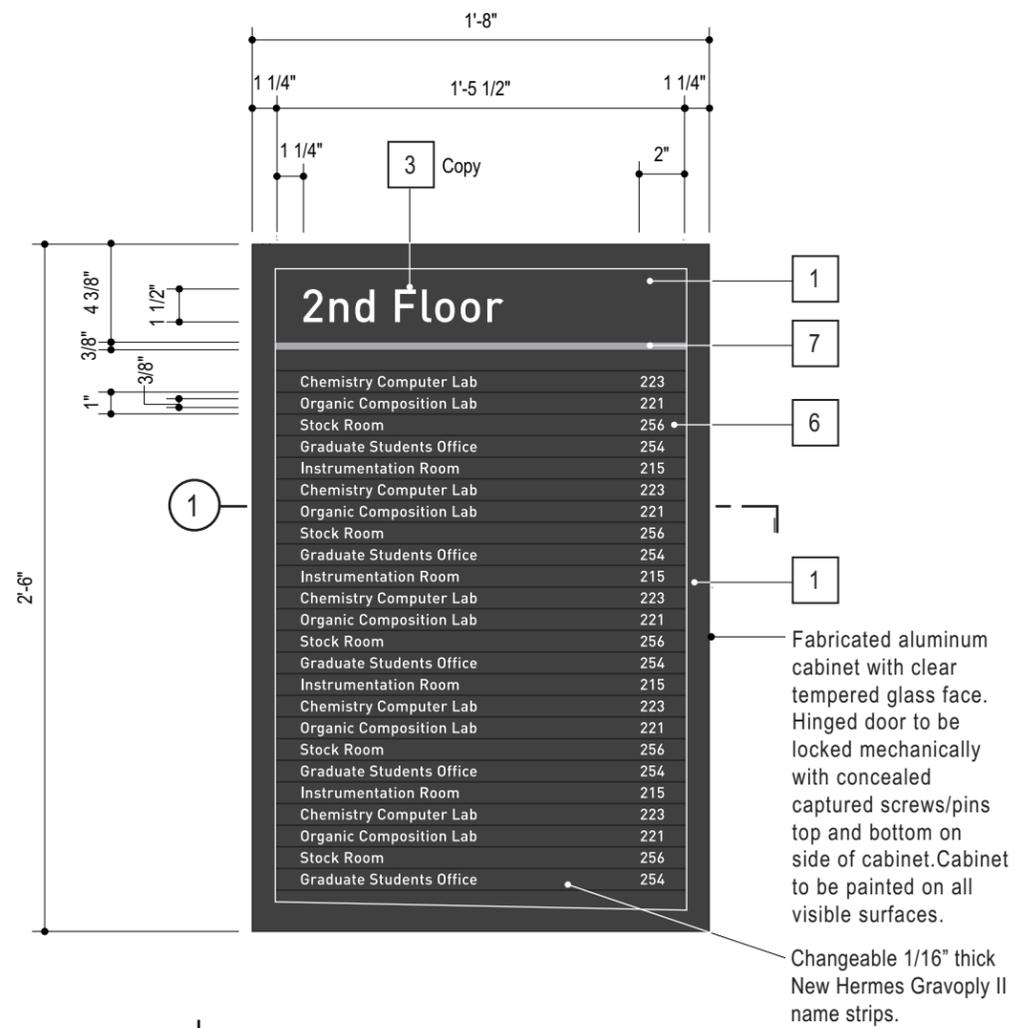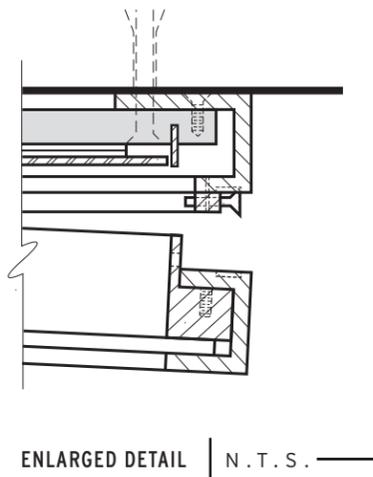
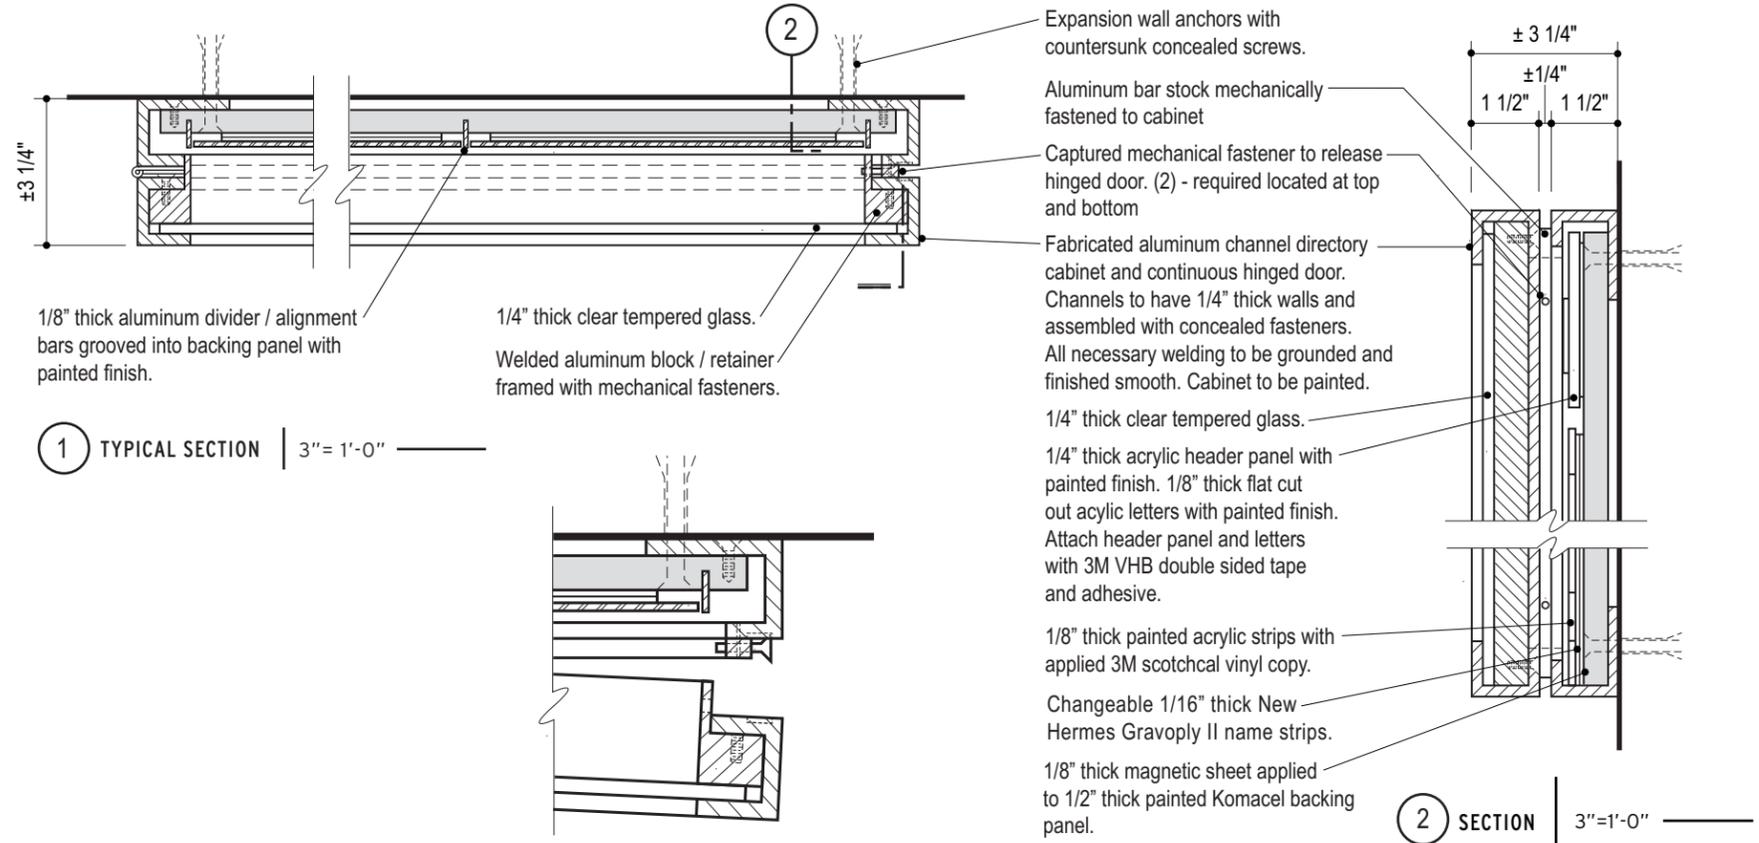


GENERAL NOTES:

1. Copy shown as typical layouts only, actual layouts to be determined and or verified prior to fabrication.
2. Sign installer to verify existing mounting conditions and use appropriate attachment method as per condition.



ELEVATION HALF SIZE

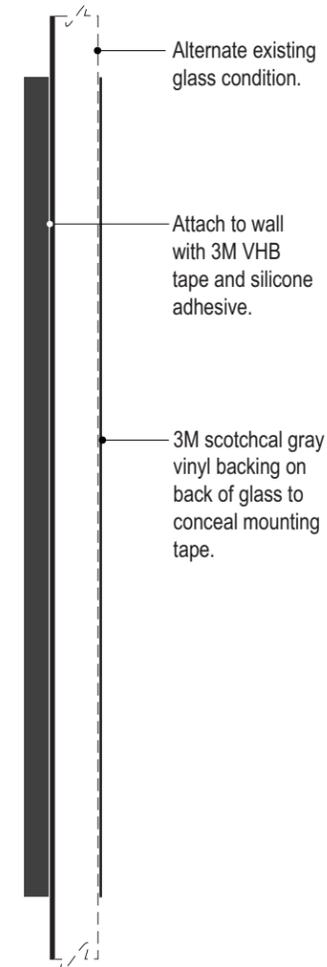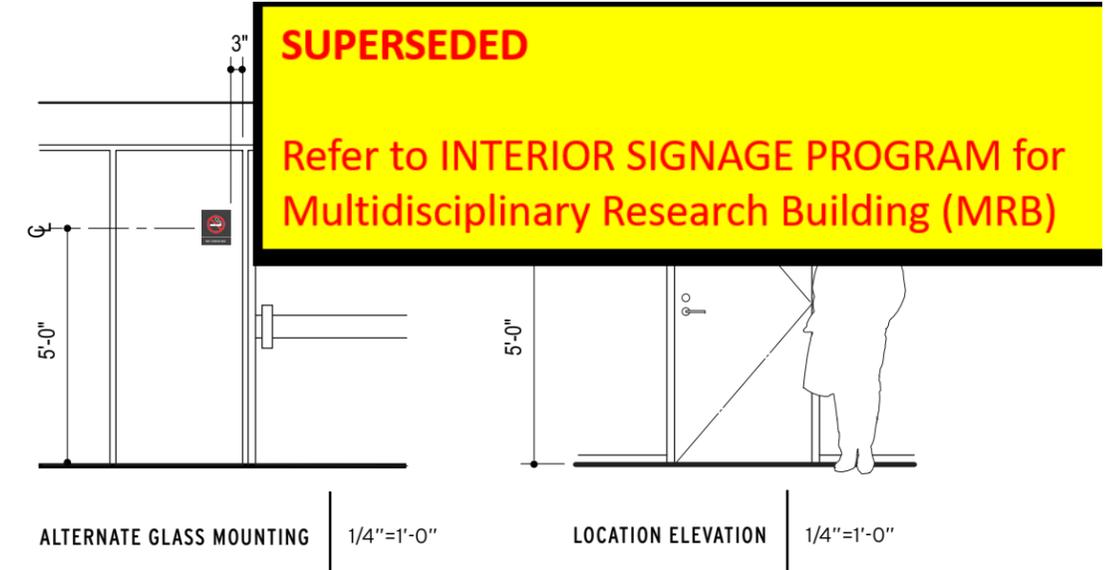



SIDE VIEW HALF SIZE





ADDITIONAL LAYOUTS HALF SIZE

GENERAL NOTES:

1. Copy shown as typical layouts only, actual layouts to be determined and or verified prior to fabrication.
2. Sign installer to verify existing mounting conditions and use appropriate attachment method as per condition.

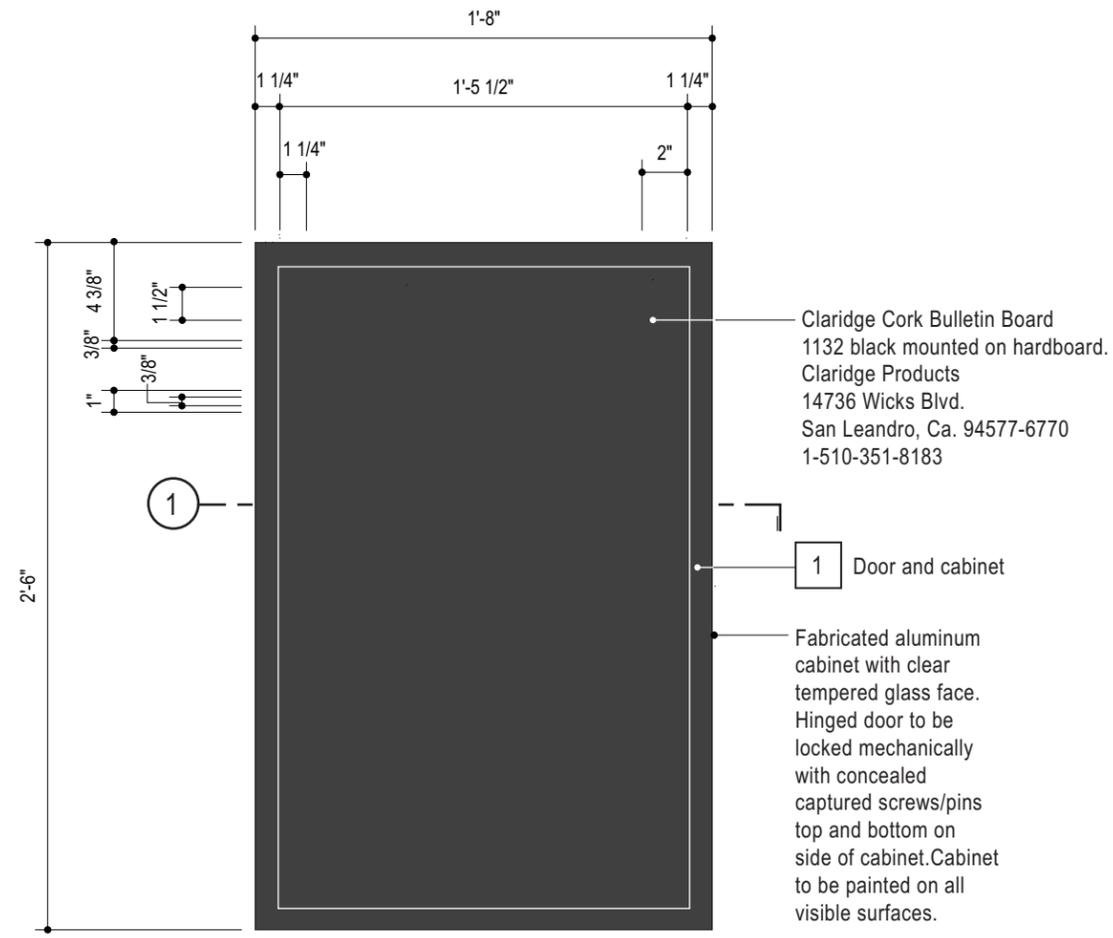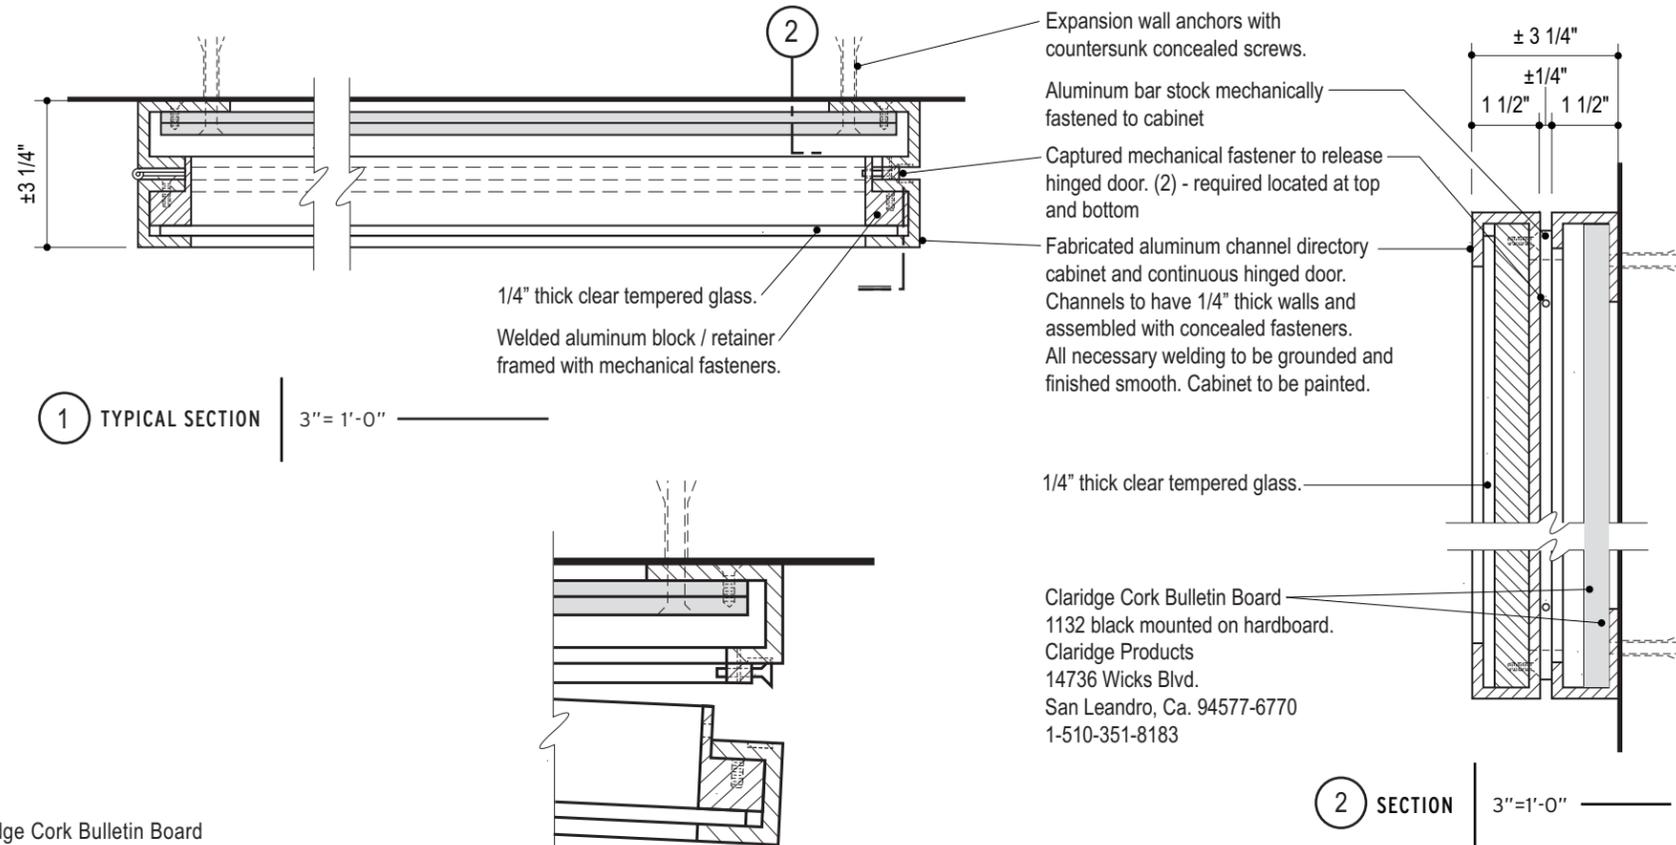

ELEVATION | 1 1/2"=1'-0"

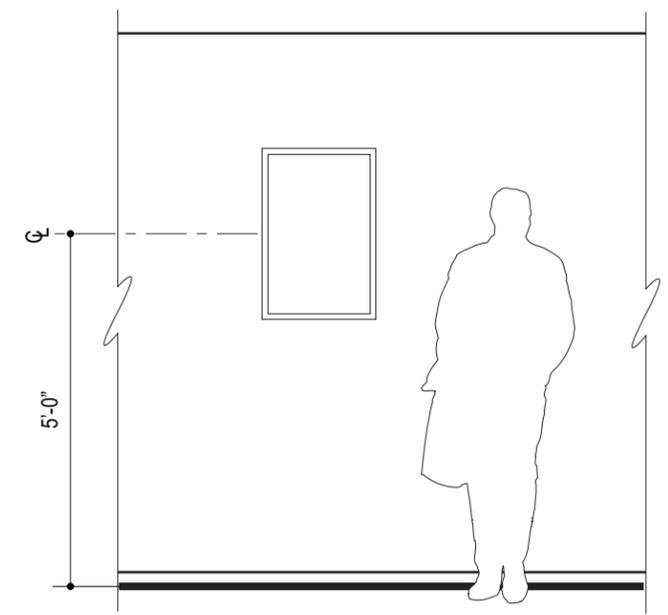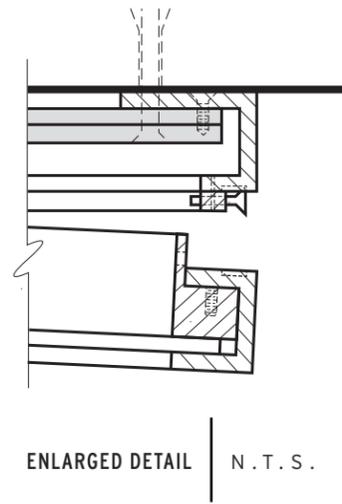


LOCATION ELEVATION | 3/8"=1'-0"


SUPERSEDED

Refer to INTERIOR SIGNAGE PROGRAM for Multidisciplinary Research Building (MRB)


2. Sign installer to verify existing mounting conditions and use appropriate attachment method as per condition.
3. Braille shall be Calif Grade 2 (Contracted Braille).
4. An inverted "L" shall precede all numbers in Braille.

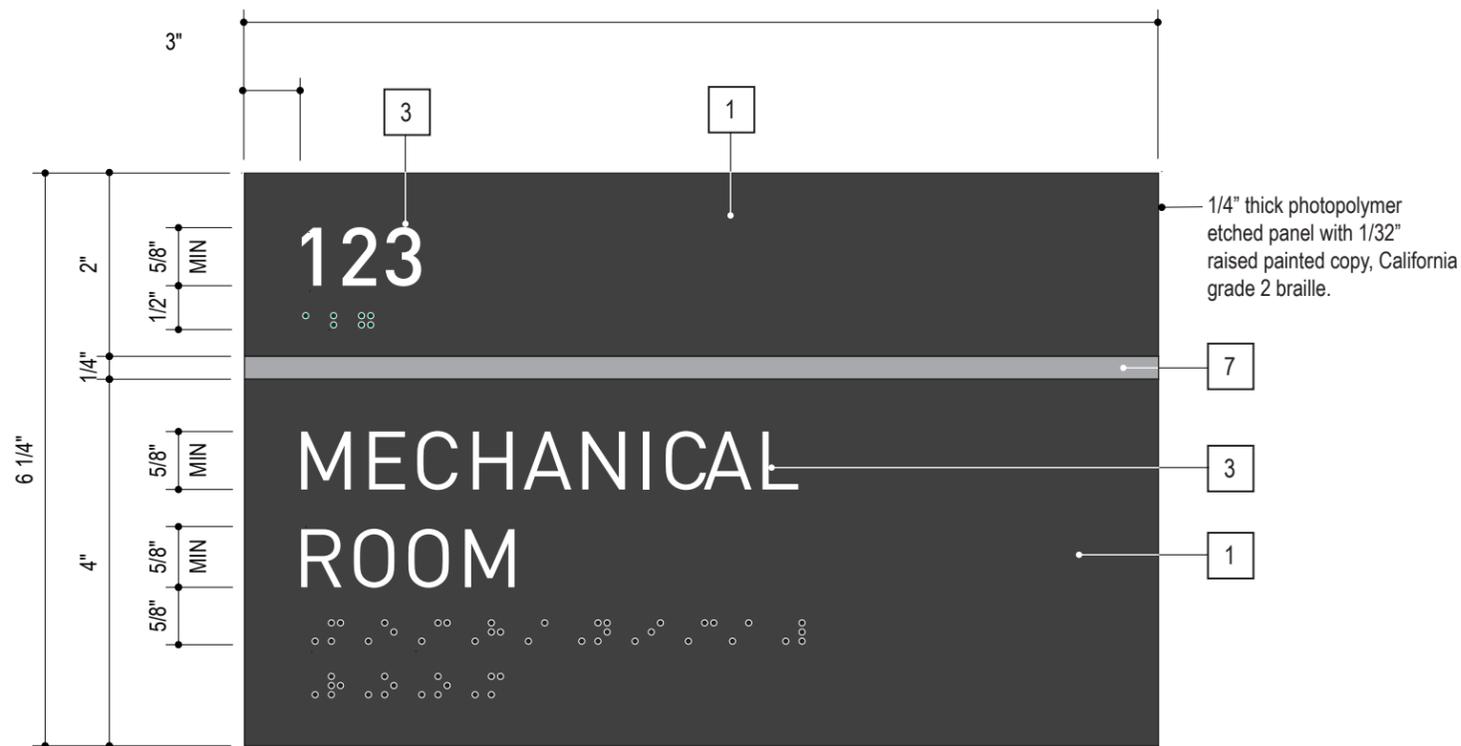


ELEVATION | HALF SIZE

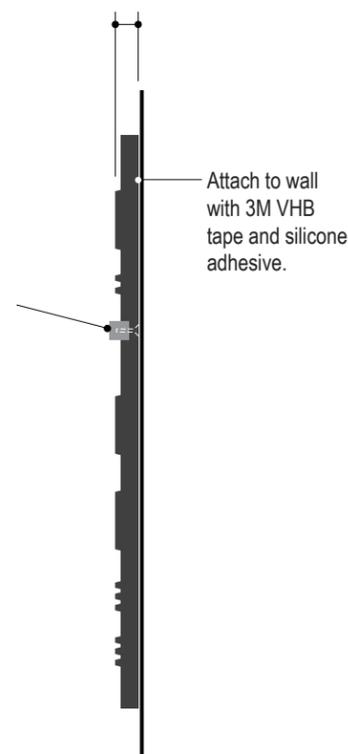

SIDE VIEW | HALF SIZE

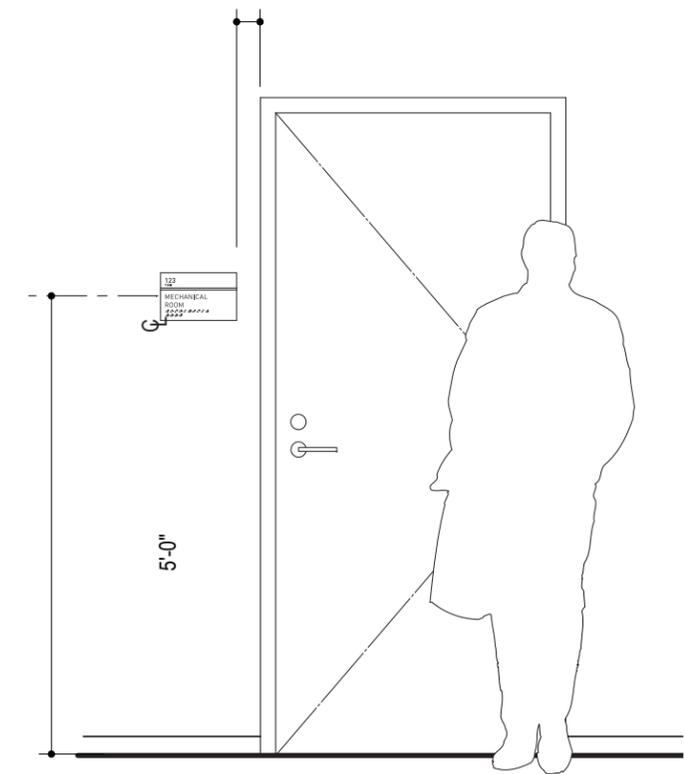


LOCATION ELEVATION | 1/2"=1'-0"

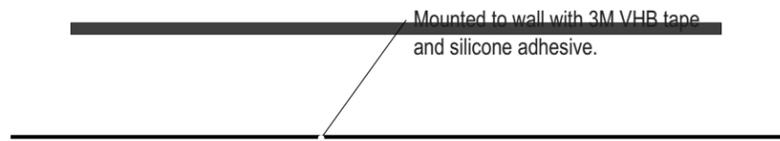

PLAN VIEW | 3"=1'-0"

C

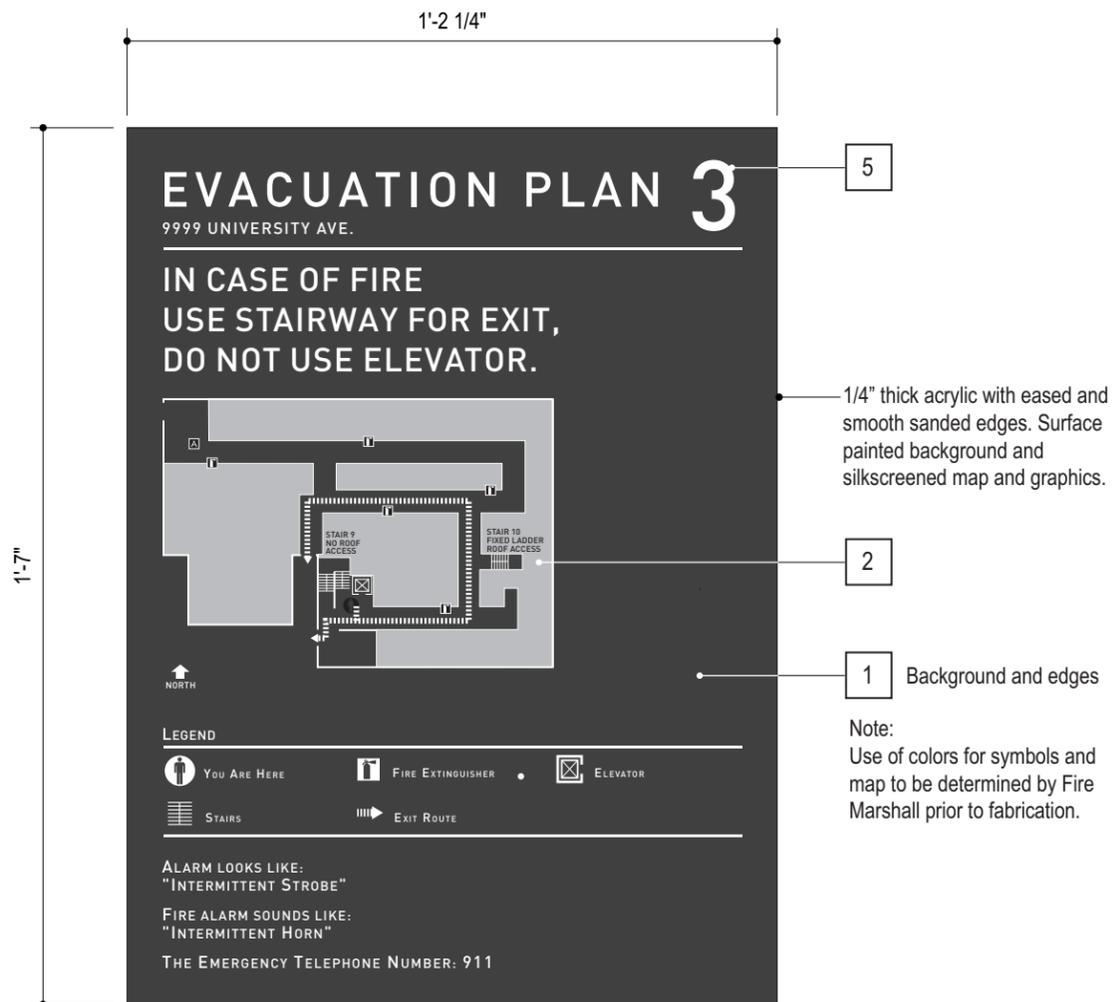

Horizontal Map Layout

ELEVATION | 3"=1'-0"



Vertical Map Layout


ELEVATION | 3"=1'-0"

SUPERSEDED

Refer to INTERIOR SIGNAGE PROGRAM for Multidisciplinary Research Building (MRB)



2. Sign installer to verify existing mounting conditions and use appropriate attachment method as per condition

3. Contact UCR Capital Programs for template artwork in Adobe Illustrator format.

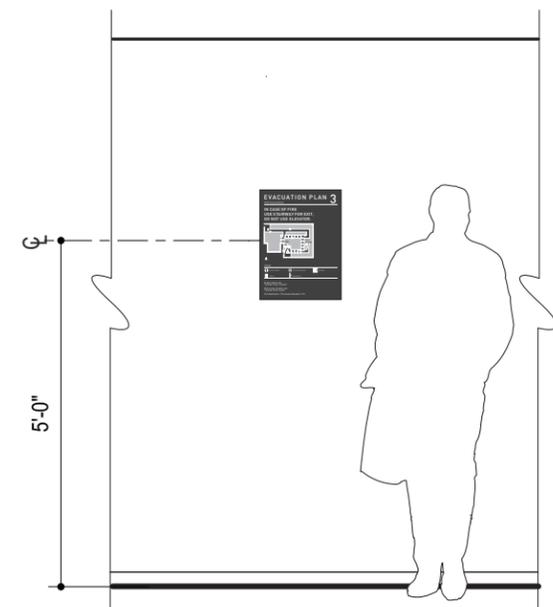


LOCATION ELEVATION | 3/8"=1'-0"

SUPERSEDED
 Refer to INTERIOR SIGNAGE PROGRAM for
 Multidisciplinary Research Building (MRB)

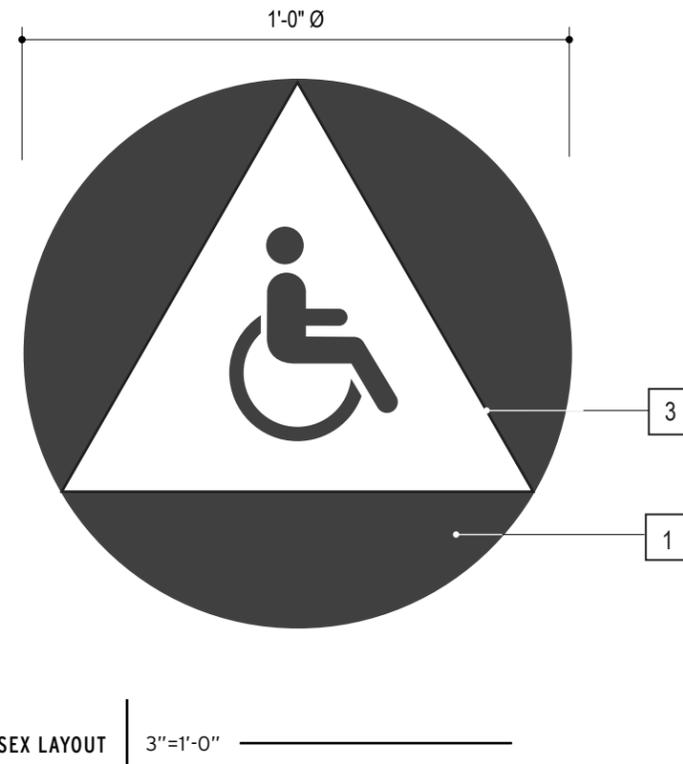
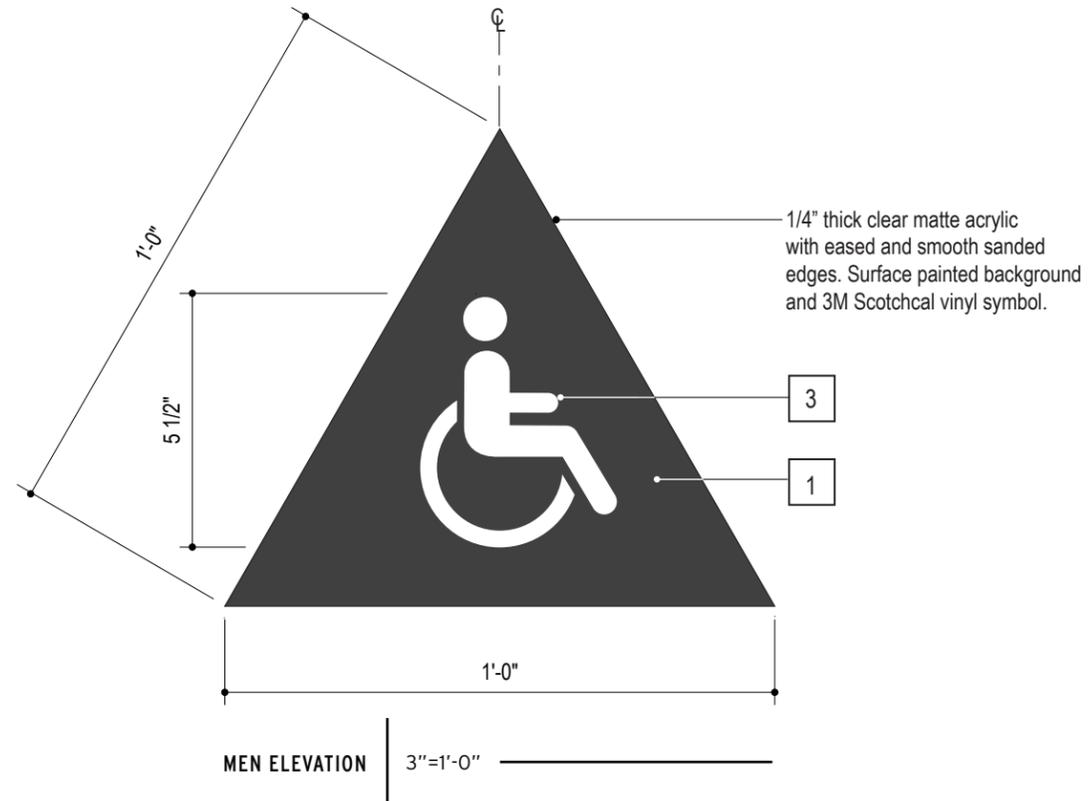


Ease edges to prevent individuals from cutting themselves.

1/4" thick clear matte acrylic with eased and smooth sanded edges. Surface painted background and 3M Scotchcal vinyl symbol.

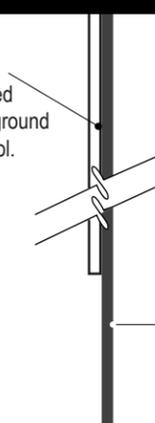




UNISEX SIDE 3"=1'-0" (scale bar)

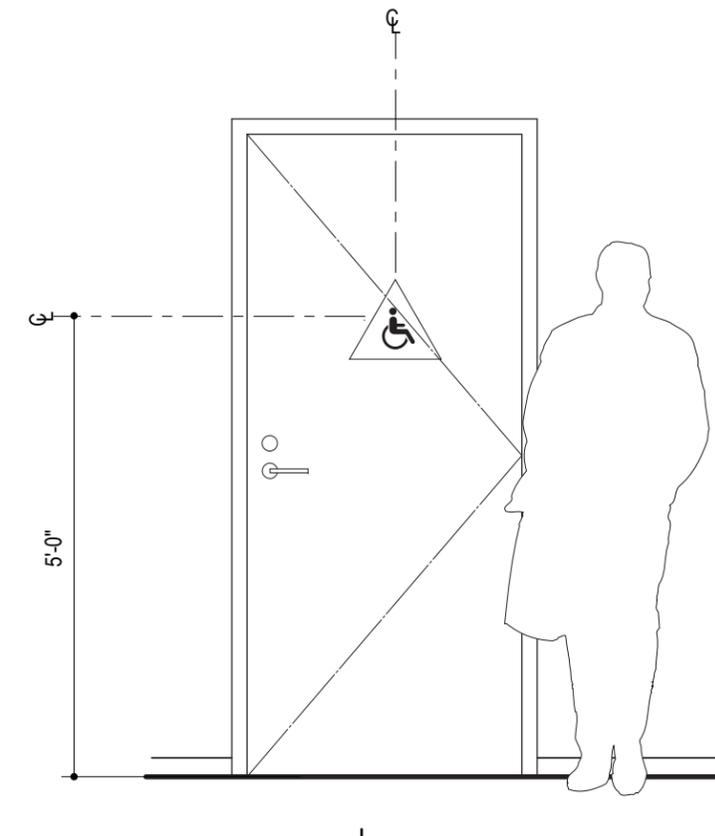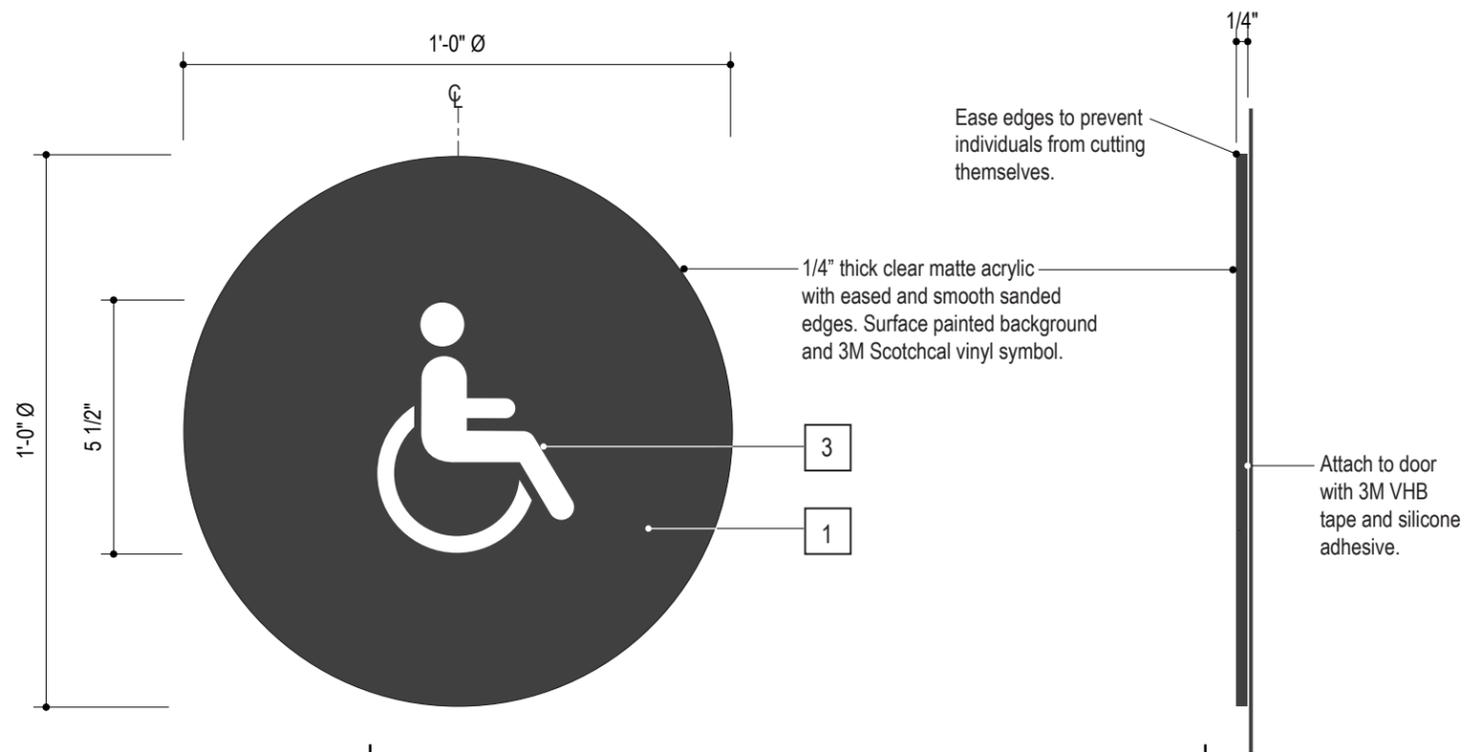

SUPERSEDED

Refer to INTERIOR SIGNAGE PROGRAM for Multidisciplinary Research Building (MRB)


2. Sign installer to verify existing mounting conditions and use appropriate attachment method as per condition.
3. Braille shall be Calif Grade 2 (Contracted Braille).
4. An inverted "L" shall precede all numbers in Braille.

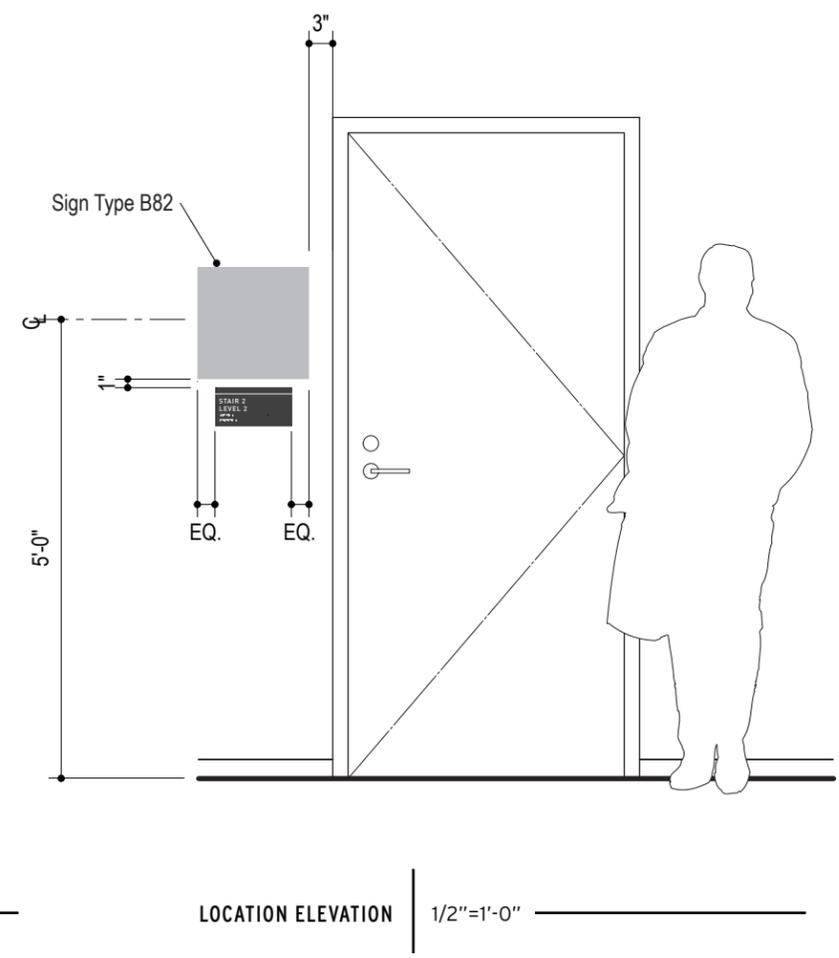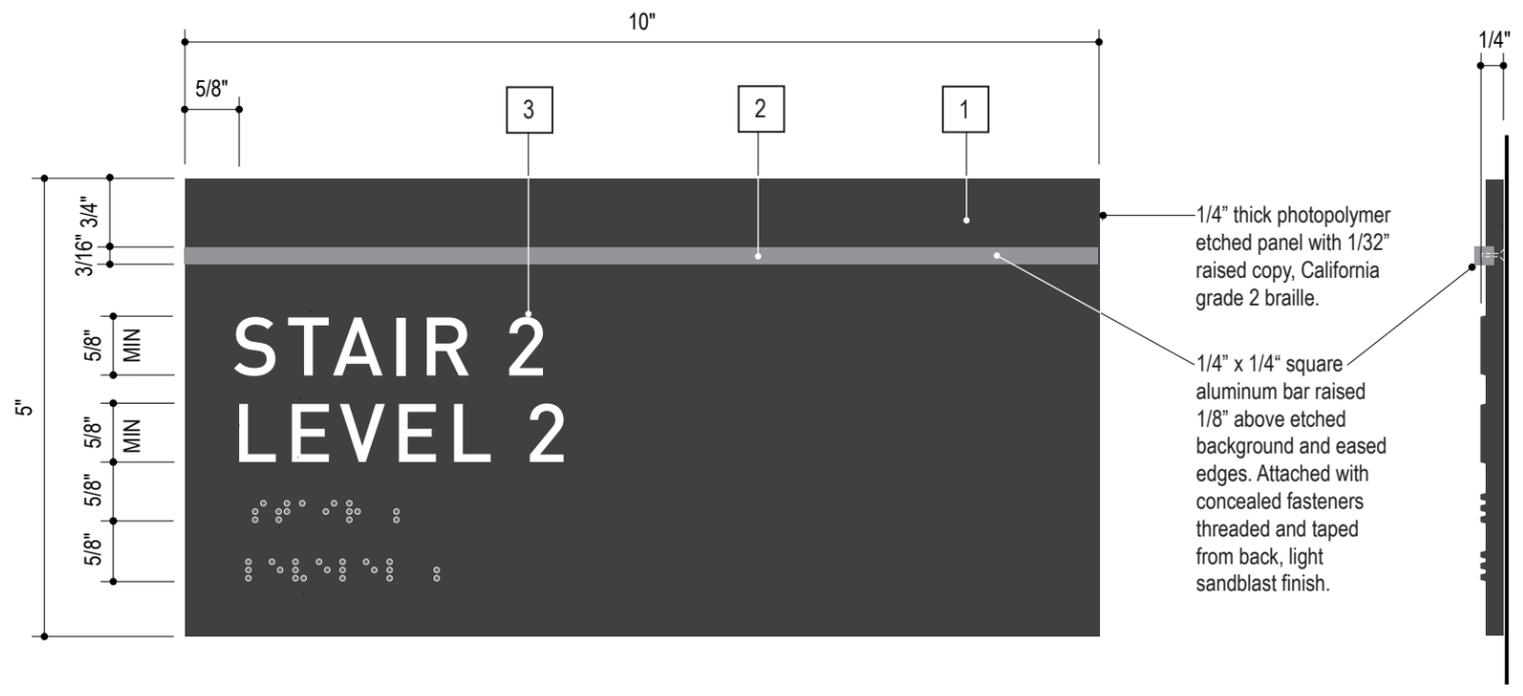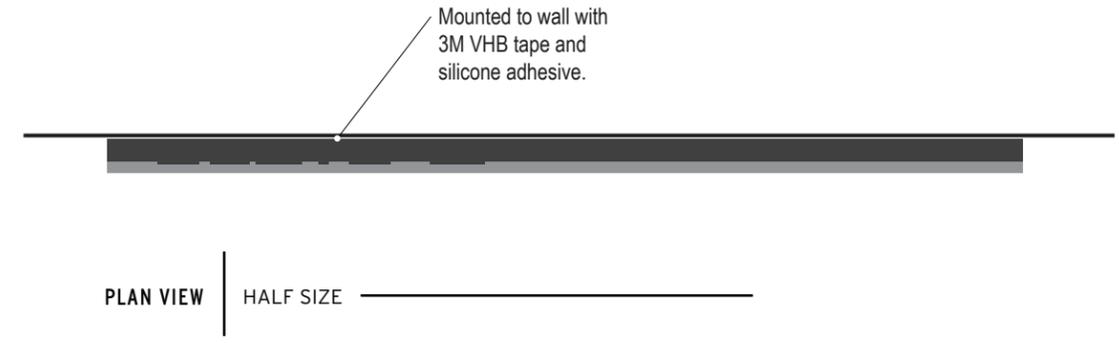


SUPERSEDED

Refer to INTERIOR SIGNAGE PROGRAM for Multidisciplinary Research Building (MRB)


2. Sign installer to verify existing mounting conditions and use appropriate attachment method as per condition.

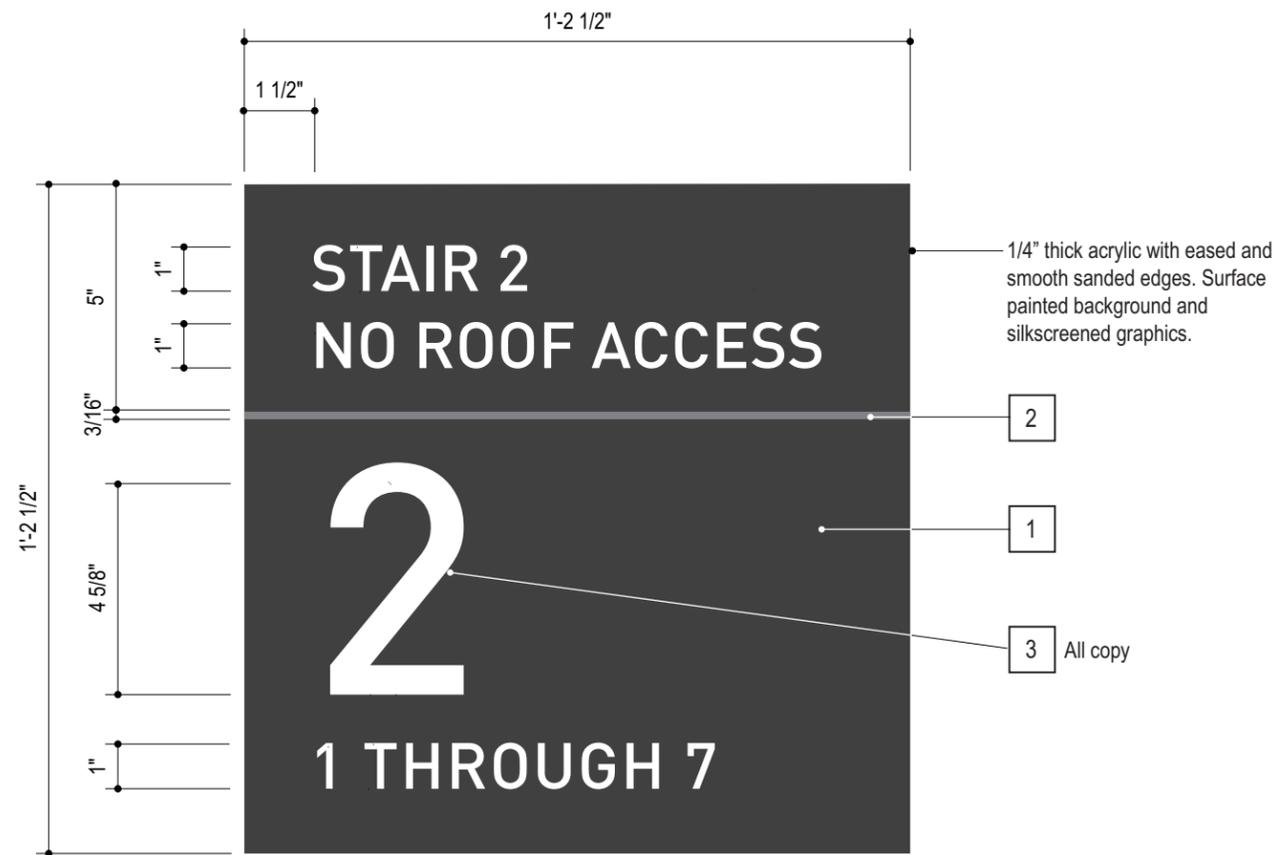

ELEVATION | 3"=1'-0"

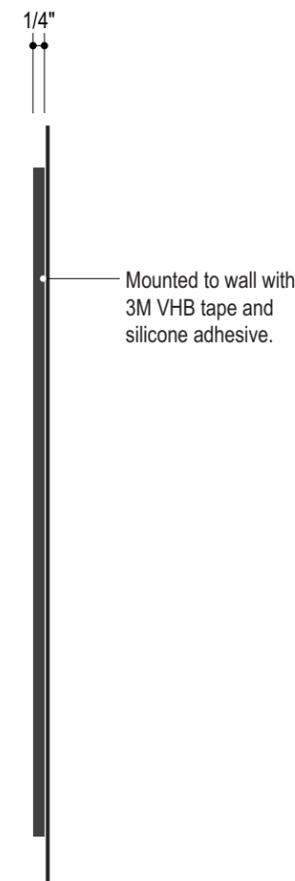


SIDE VIEW | 3"=1'-0"

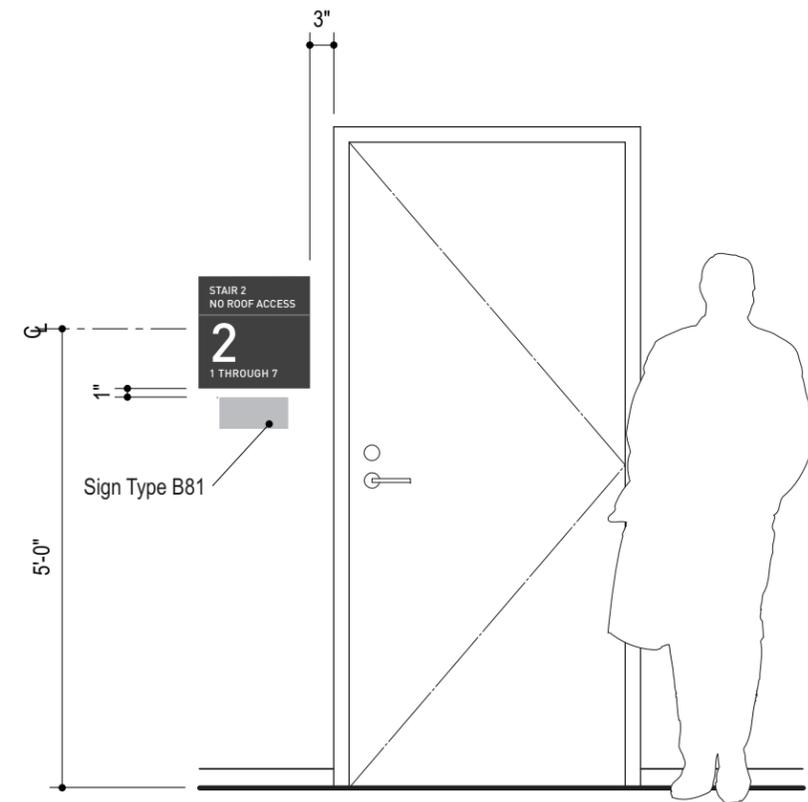


LOCATION ELEVATION | 1/2"=1'-0"

GENERAL NOTES:


1. Copy shown as typical layouts only, actual layouts to be determined and or verified prior to fabrication.
2. Sign installer to verify existing mounting conditions and use appropriate attachment method as per condition.

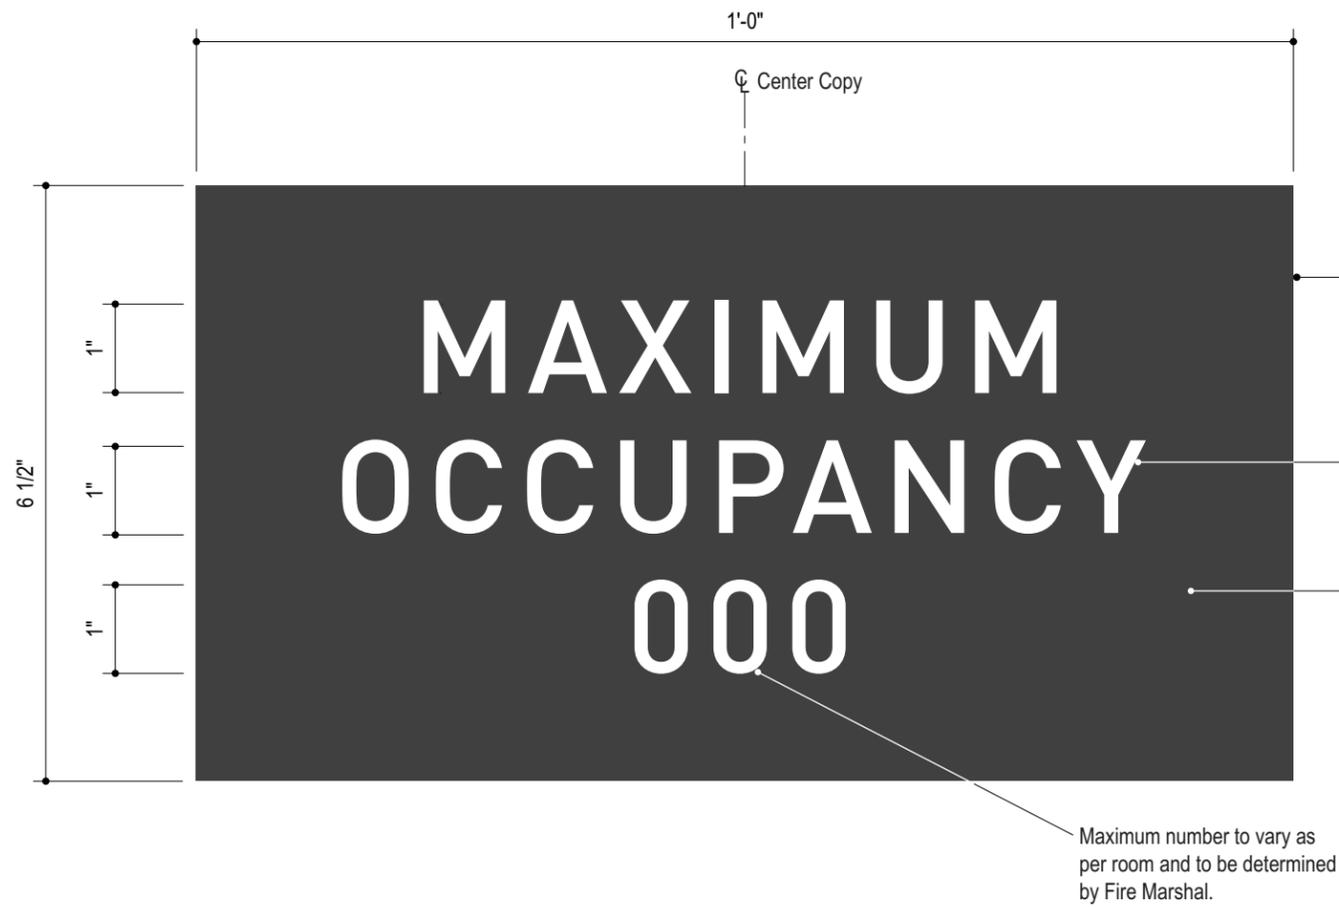

ELEVATION | HALF SIZE

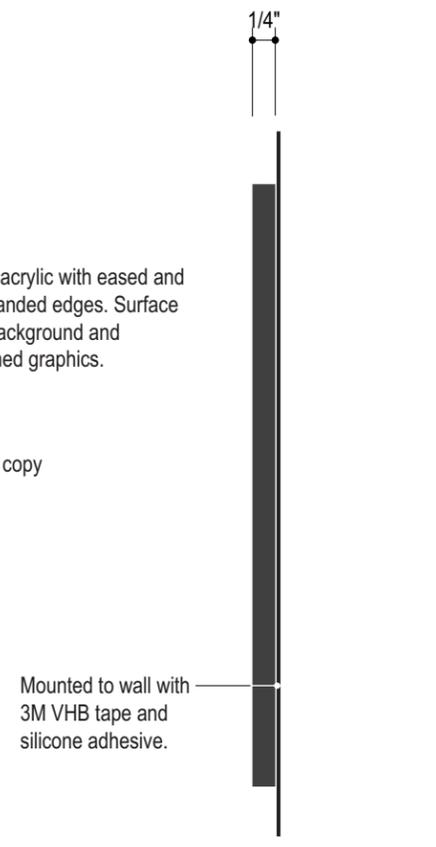

SIDE VIEW | HALF SIZE

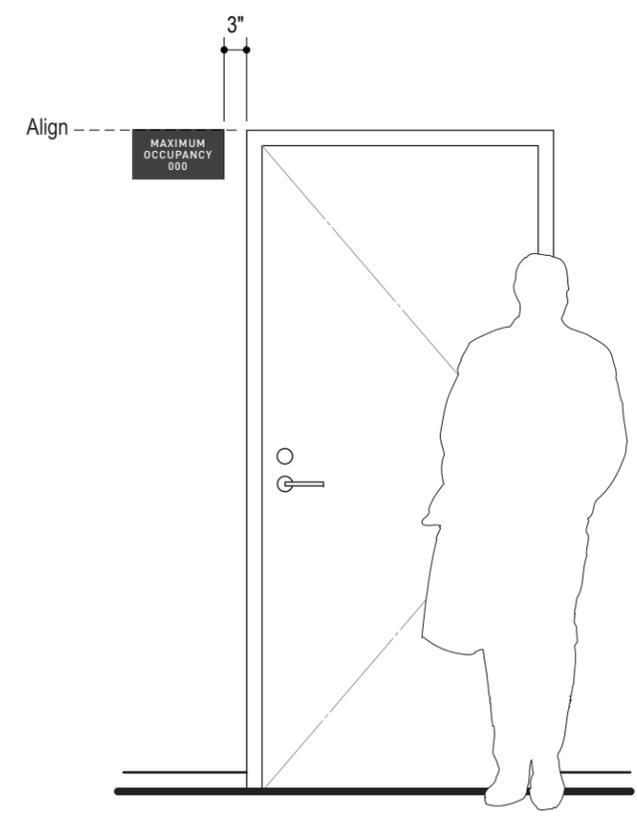


LOCATION ELEVATION | 1/2"=1'-0"



Computer cut 3M Scotchcal vinyl copy with color being gray or white as determined by existing surface color.

ELEVATION


3"=1'-0"

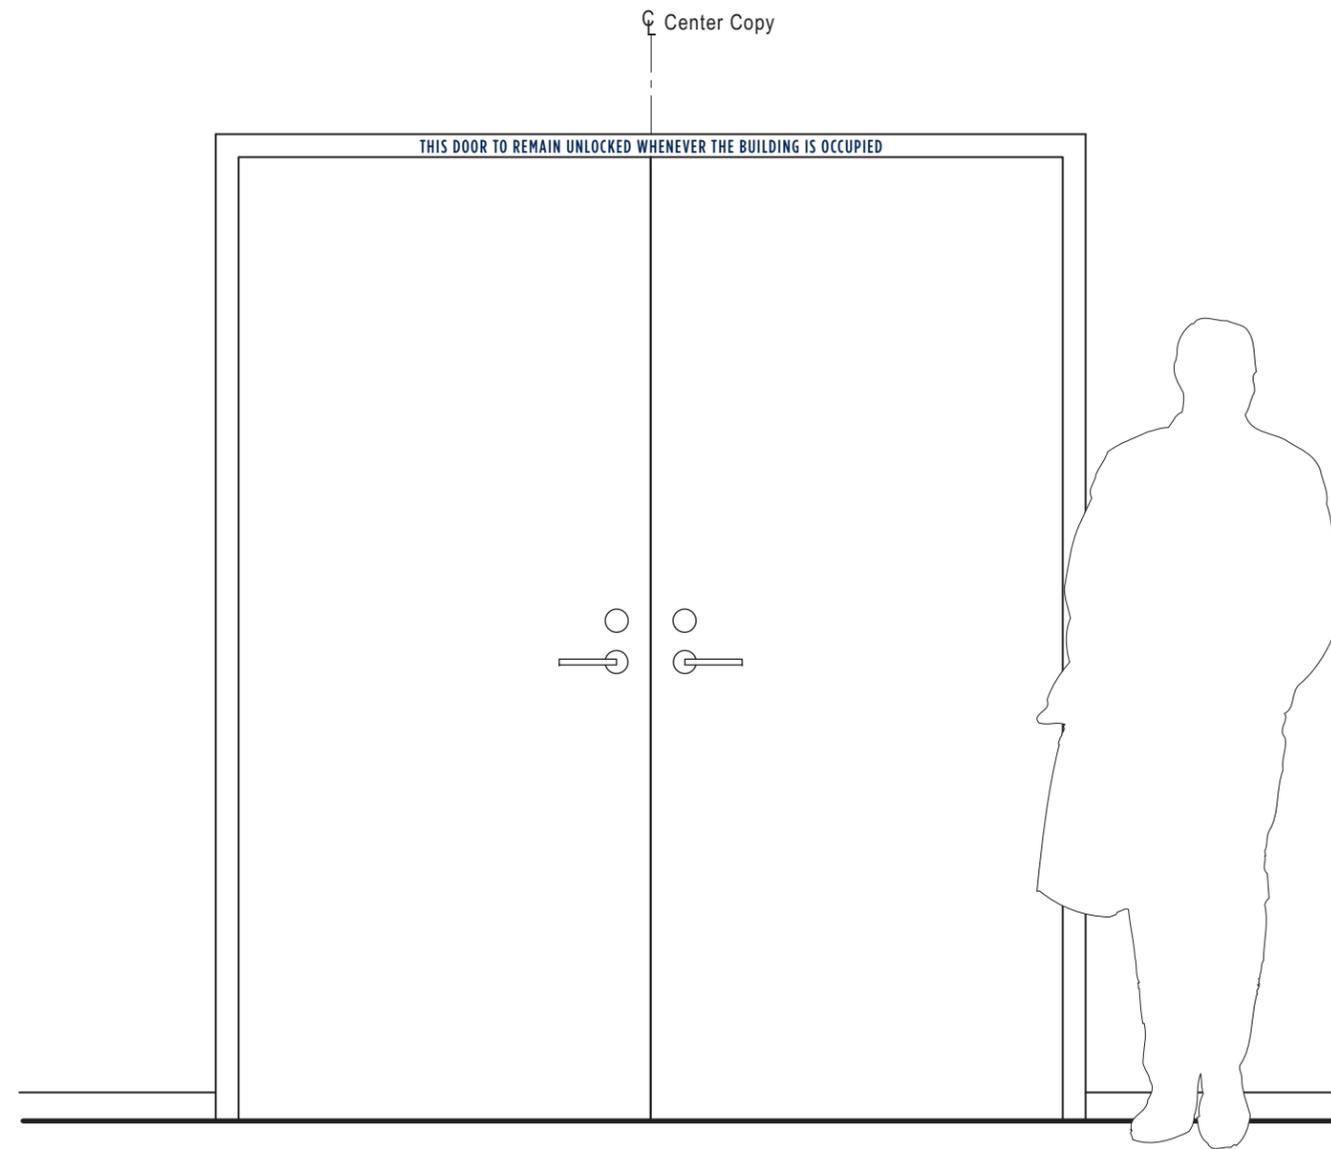


LOCATION ELEVATION

3/4"=1'-0"


SUPERSEDED
Refer to INTERIOR SIGNAGE PROGRAM for
Multidisciplinary Research Building (MRB)

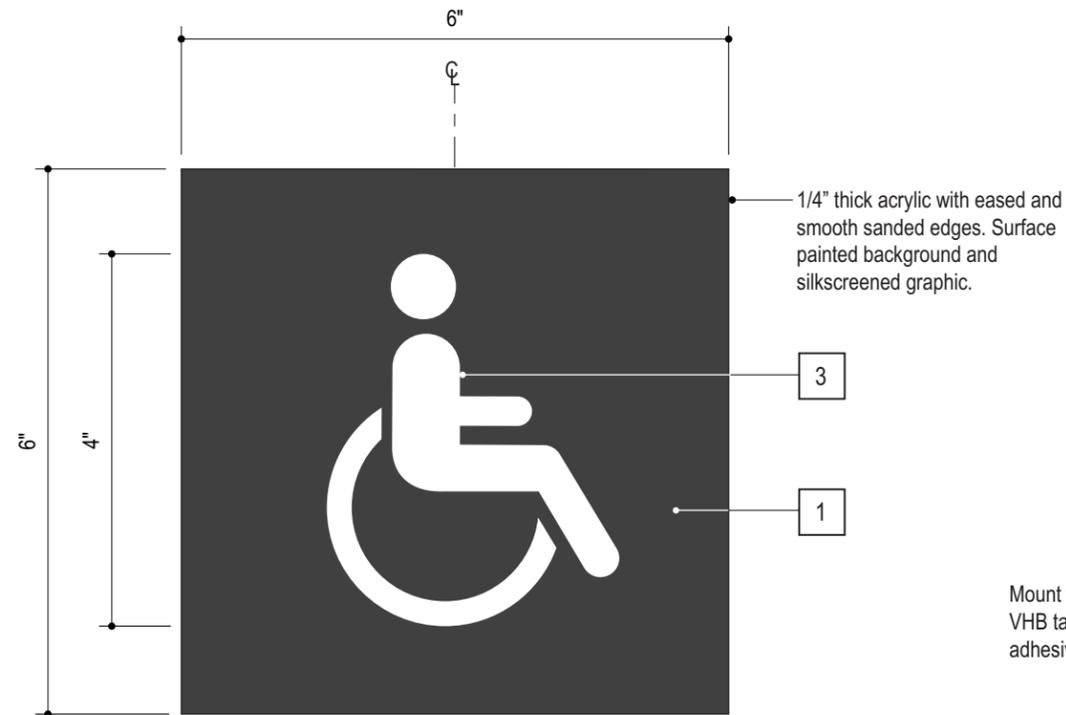


ELEVATION | HALF SIZE

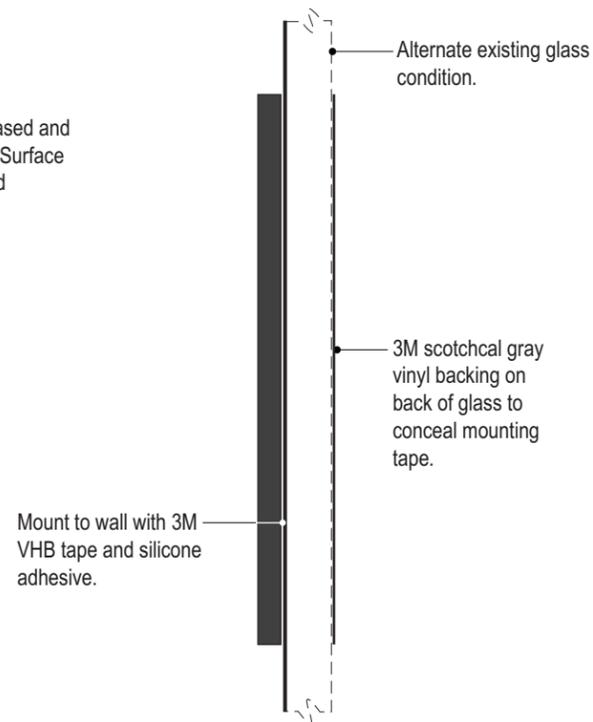

SIDE VIEW | HALF SIZE

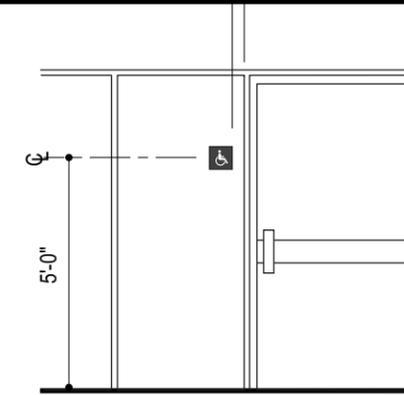

ALTERNATE GLASS MOUNTING | 1/4"=1'-0"

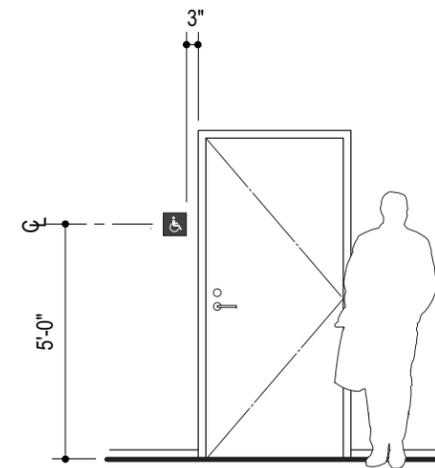


LOCATION ELEVATION | 1/4"=1'-0"

GENERAL NOTES:


1. Copy shown as typical layouts only, actual layouts to be determined and or verified prior to fabrication.
2. Sign installer to verify existing mounting conditions and use appropriate attachment method as per condition.
3. Braille shall be Calif Grade 2 (Contracted Braille).




ELEVATION HALF SIZE

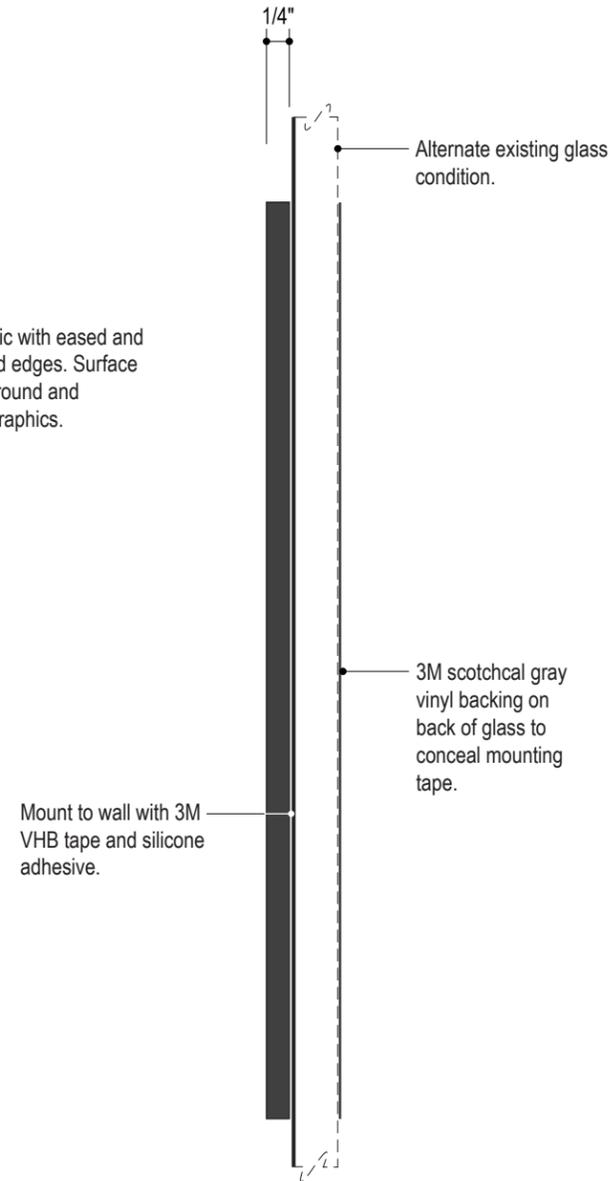

SIDE VIEW HALF SIZE

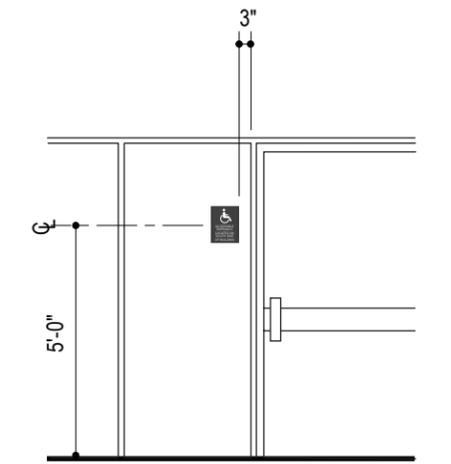

ALTERNATE GLASS MOUNTING 1/4"=1'-0"

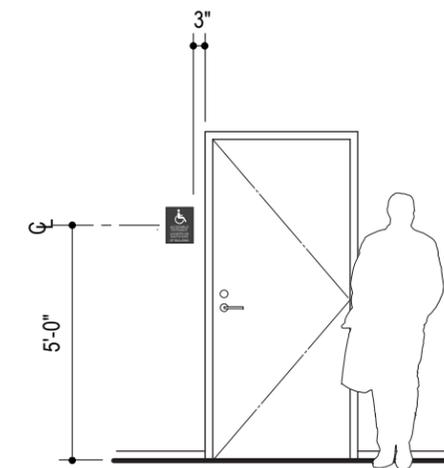


LOCATION ELEVATION 1/4"=1'-0"


SUPERSEDED

Refer to INTERIOR SIGNAGE PROGRAM for Multidisciplinary Research Building (MRB)


2. Sign installer to verify existing mounting conditions and use appropriate attachment method as per condition.

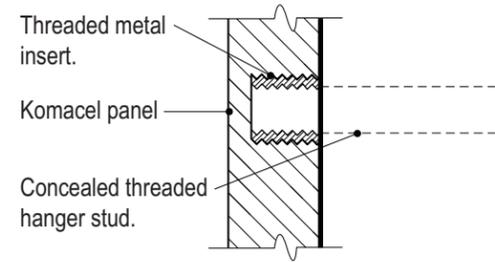


(A) DETAIL FULL SIZE

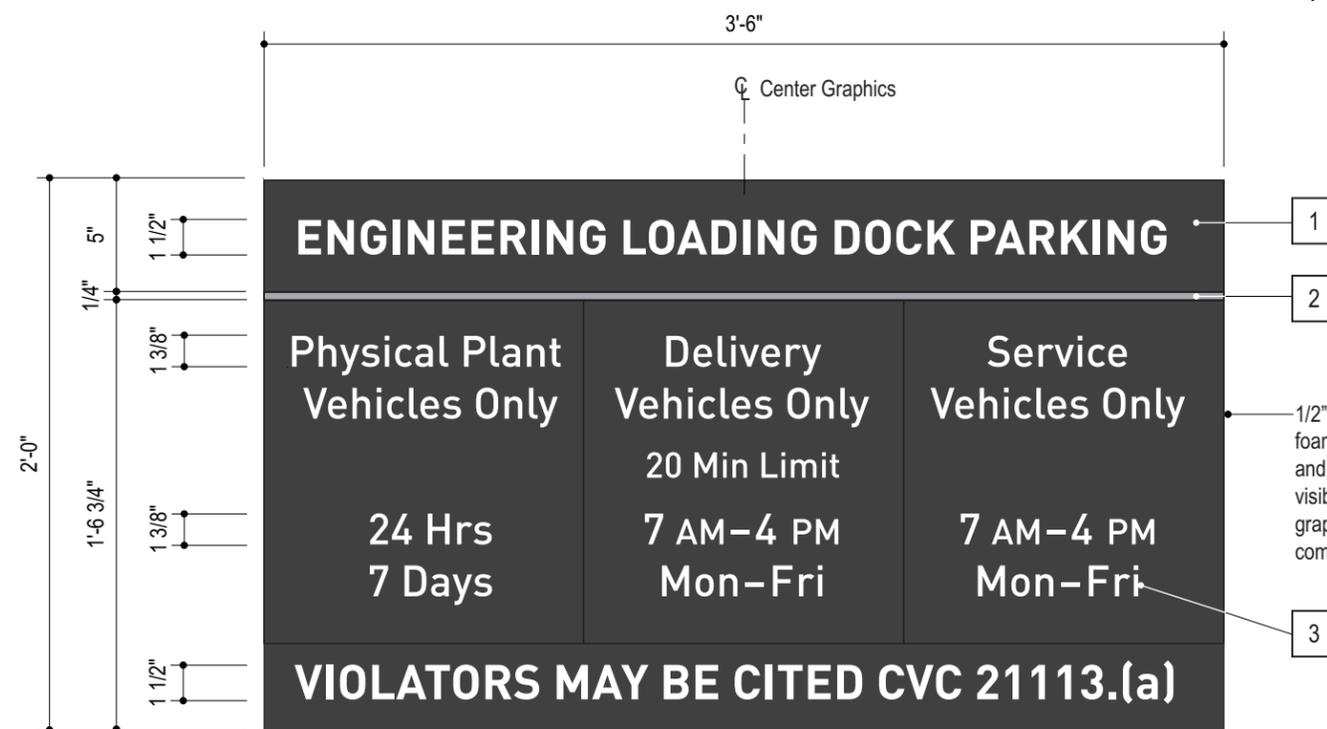

ELEVATION 1 1/2"=1'-0"

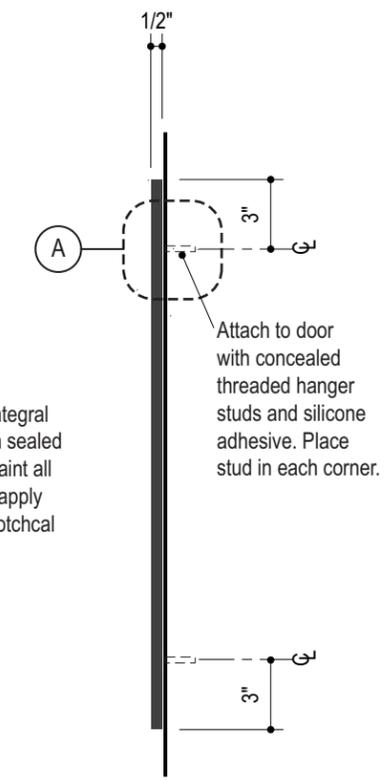

SIDE VIEW 1 1/2"=1'-0"

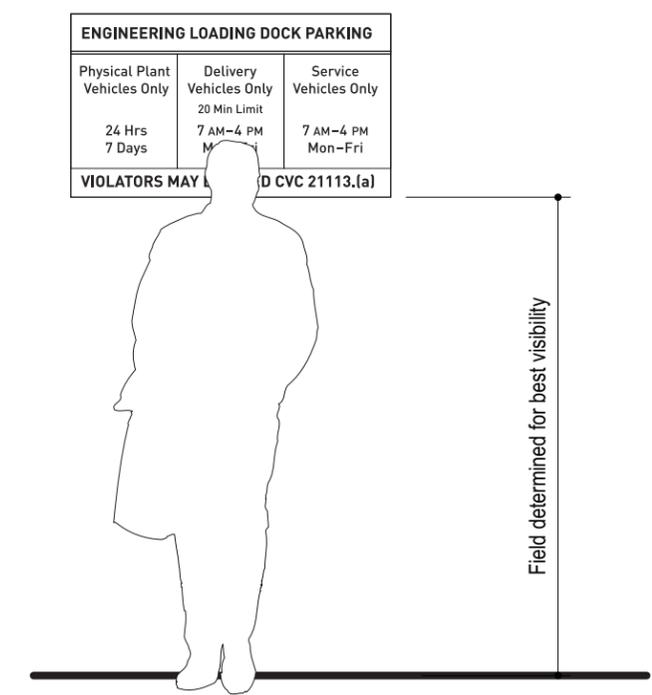

LOCATION ELEVATION 1/2"=1'-0"

UCR Campus Process: Gender Inclusive Facilities 2015

ISSUING OFFICER: Associate Vice Chancellor/ Campus Architect

RESPONSIBLE OFFICE: Architects & Engineers **EFFECTIVE DATE:** November 01, 2015

I. Background

UCR is strongly committed to creating and sustaining a campus environment that supports and values all members of our community, including visitors. This Gender Inclusive Facilities process focuses on providing a safe environment, consistent with UCR principles of community and efforts aimed at civility and respect. Gender inclusion should provide access and equality by creating an environment that is safe, accessible and respectful of all individuals. One aspect of creating an inclusive environment is the availability of safe, accessible and convenient restroom facilities. Many people may experience difficulty, inconvenience or harassment when using gender specific restrooms and facilities. Additionally, parents with children of a different gender, as well as caregivers to persons of different genders, face difficulties in accompanying them. UCR aims to implement best practices for gender inclusive facilities.

II. Goals of the UCR Gender Inclusive Process

In accordance with the University's nondiscrimination policies, these guidelines seek to create an inclusive campus environment for transgender and gender variant people and provide direction on the implementation of gender inclusive facilities in UCR-owned buildings.

III. Definitions:

Changing Room: a room in which one or more persons partially or fully disrobe and re-dress. Locker rooms fall under this definition. Gender inclusive changing rooms shall provide privacy and security.

Gender Identity: an individual's sense of oneself as male, female or transgender, including an individual's self-image, appearance, expression or behavior, whether or not that self-image, appearance, expression or behavior is different from the individual's sex assigned at birth.

Gender Inclusive facility (sometimes referred to as Gender Neutral facility): a facility, including but not limited to restrooms, showers, locker rooms and changing rooms, that is

usable by persons of all gender identities and expressions and that is not gender specific. The facility shall provide privacy and security for the individual user. Gender inclusive facilities shall include spaces and fixtures equivalent to gender specific facilities.

Gender Specific: designated for use by one gender (i.e. male or female).

Restroom: any facility equipped with toilets, urinals and other similar facilities, in a public facility for use of the public for personal hygiene and comfort. “In a public facility” and “for use by the public” in this context covers essentially all UCR facilities and restrooms, except for facilities located within private residences or apartments, within dormitory suites, or in areas not accessible to the public.

Shower: a space in which one or more persons bathe or shower. Gender inclusive showers shall provide privacy and security for the individual user.

IV. **Applicability**

This process applies to UCR-owned facilities including new construction, existing and renovated facilities. While the process does not extend to UCR-leased facilities at this time, evaluation of the availability of gender inclusive facilities shall occur when beginning or renewing leases, especially when UCR leases more than 50% of a building, or for leases 10 years or longer. Privatized projects developed on UCR-owned land where the project is to be used for University-related purposes shall comply with the requirements for inclusive facilities.

V. **Process**

- a. **Existing Facilities: Capital Asset Strategies (CAS)** shall maintain an accurate list of Gender Inclusive Facilities in the campus space data found within the Facilities Management System (FMS). CAS will also maintain the locational listing in the Geographic Information System database, and transmit that information to Strategic Communications, for inclusion on the interactive campus map.

The Campus Architect will ensure the conversion of existing, single-occupancy or single-stall restrooms in UCR-owned buildings from gender specific to gender inclusive with privacy and security as noted in the definitions, such that all UCR-owned buildings with existing single stall restrooms will either contain a Gender Inclusive Restroom (GIRR) or be served by an identified GIRR in a “nearby” facility. “Nearby” is commonly defined as being within two minutes of pedestrian travel time between building entrances. Conversions will usually be limited to revised signage. Conversions that are accomplished by signage changes alone shall not be considered renovations. In cases

where conversions do not satisfy the goal of having a GIRR in every UCR-owned building or in a nearby building, construction or renovation of a GIRR must be considered.

- b. *New Construction or Renovation:*** UCR-owned buildings beginning design, for either new construction or renovation, on or after July 1, 2015, shall include at least one GIRR on each floor where restrooms are required or provided in a building. GIRRs on each floor shall be accessible consistent with the California Building Code (CBC). “UCR-owned” includes buildings designed and/or built by third parties that are to become the property of UCR upon completion.
- c. *Restroom Renovations:*** When extensive renovations are made to existing restrooms (i.e. when the construction cost for the renovation exceeds 50% of the restroom replacement cost) or when extensive renovations are made to one or more floors of an existing building (i.e. more than 50% of the replacement cost of the area being renovated) in buildings that do not already have at least one GIRR, the project shall provide a GIRR in the same building.
- d. *Changing Rooms:*** The design of new buildings shall provide for at least one gender-inclusive changing room in each location in the building where locker rooms or changing rooms are provided. The gender-inclusive changing room shall be located within the locker room/changing room facility so the user need not leave the locker room/changing room to use the gender-inclusive changing room. For major renovations, the Campus shall construct at least one gender inclusive private changing room in each location in any building where locker rooms or changing rooms are provided (major renovation is defined as renovation exceeding 50% of the replacement cost of the area being renovated) or when the locker room or changing room is renovated.
- e. *Showers:*** The design of new buildings shall provide for at least one gender-inclusive shower in buildings where showers are provided. If the shower or showers are located within a locker room/changing room facility, the gender inclusive shower(s) shall be located so that the user need not leave the locker room/changing room facility to use the shower. The Campus shall construct at least one gender inclusive shower in each location in any building where showers are provided when a major renovation occurs (major renovation is defined as renovation exceeding 50% of the replacement cost of the area being renovated) or when existing showers are renovated. The shower(s) shall be located within the locker room/changing room facility so that the user need not leave the locker room/changing room facility to use the shower(s).
- f. *Signage:*** Gender inclusive facilities will be identified in a simple manner, utilizing the minimum signage required by the CBC and the 2010 ADA Standards for Accessible Design (ADA). For GIRRs, the required sign on the door shall be a triangle within a circle

of contrasting color, without gender pictograms. The international convention is a white triangle on a blue circle, but ADA-compliant and CBC-compliant signs/colors are acceptable. The CBC-required room identification sign shall provide the minimum required information, including the pictogram for access, if applicable. For GIRRs, the room identification shall be "Restroom". Signs for changing rooms and shower rooms shall also follow this guidance, as applicable.

- g. Directional signs:** In existing buildings where gender inclusive facilities are not or cannot be provided, the Campus Architect shall direct the installation of at least one directional sign in a conspicuous location, normally near the building's main entrance and the building restrooms, indicating the location of the nearest gender inclusive facilities.
- h. Hardship:** In instances where hardship may preclude full compliance with this process, campus entities may request that a waiver from the process be approved. Approval authority for these waivers has been delegated in writing from the Chancellor to the Campus Building Official (Campus Architect). The waiver request form is included as Attachment A.
- i. Feedback:** Any concerns, suggestions, or recommendations associated with UCR's provision of gender inclusive facilities should be submitted to the Campus Architect, via the Office of Architects & Engineers.

VI. References

1. University of California Guidelines for Providing Gender Inclusive Facilities: Effective 7/1/15
2. University of California Facilities Manual RD4.1: Providing Gender Inclusive Facilities
3. UCR Gender Inclusive Facilities Hardship Waiver Request (Attachment A)
4. Model Template for Signs (Attachment B)

UCR Gender Inclusive Facilities Hardship Waiver Request

PROCESS

1. Project proponent completes Waiver Request Form. The Project Manager will provide technical support, as needed.
2. Request is submitted to Campus Building Official (Campus Architect) through the Architects & Engineers office.
3. Review of Request and application of criteria to be completed by “Working Group” consisting of:
 - a. Code Enforcement Representative
 - b. Capital Finance Representative
 - c. A&E Project Team member
 - d. CAS Project Team member
4. “Working Group” makes recommendation with justification to Campus Building Official for approval or denial.
5. Campus Building Official renders decision.
6. CBO decision may be appealed to VC-BAS, whose ruling will be final, and without further appeal.

CRITERIA

- **Building Code Compliance:** Waiver may be considered for instances where, in the judgement of the Campus Building Official (CBO), compliance with GIF provision would unduly compromise provisions of the California Building Code or other applicable provision of law.
 - Access
 - Life/Safety
 - Security
 - Fixture unit requirements(Plumbing Code)
- **Program impacts** – Waiver may be considered upon project proponent’s application where, in the judgement of the CBO, compliance with GIF provision would unduly compromise the core mission of the University by adverse impact on space or functional requirements of the facility.
- **Cost:** Waiver may be considered upon project proponent’s application where, in the judgement of the CBO, compliance with GIF provision would entail consumption of fiscal resources to a degree that would unduly compromise the core mission of the University.
 - Quantitative criteria:
 - For projects with a total budget (GIF compliance not included) of \$100,000 or less, cost impact >10%.
 - For projects with a total budget (GIF compliance not included) of >\$100,000 cost impact >5%.
- **Location:** Waiver may be considered upon application where, in the judgement of the CBO, compliance with GIF provision is unnecessary based on availability of convenient access to existing GIF facility.

**Gender Inclusive Facilities in Renovation Projects
REQUEST FOR WAIVER BASED ON HARDSHIP**

Submit completed form to UCR Architects and Engineers office

LEGEND

| |
|-------------|
| Input cell |
| Calculation |

Campus

Project

Date

PROJECT COST

Construction cost of overall project
 Construction cost of inclusive restroom work (new or remodeled single-occupancy restroom or remodeled multi-occupancy restroom)
 Percentage of restroom cost/overall project construction cost

\$

\$

OCCUPANT LOAD & FIXTURE COUNTS

Occupant load of building

Occupants

| MEN | | WOMEN | |
|---|---|---|---|
| TOILETS & URINALS | LAVATORIES | TOILETS | LAVATORIES |
| <input style="width: 80px; height: 20px;" type="text"/> |
| <input style="width: 80px; height: 20px;" type="text"/> |
| <input style="width: 80px; height: 20px;" type="text"/> |
| <input style="width: 80px; height: 20px;" type="text"/> |

^{1,2,4} **Required** number of gender specific toilet/urinal fixtures
Existing number of gender specific toilet/urinal fixtures
 Number of gender specific fixtures inc. new inclusive restroom(s)
 Deficit (if any) with new inclusive restrooms and fixtures

PROXIMITY

Are there other inclusive restrooms in this building?
 If YES, indicate distance to nearest inclusive restroom in building

³ If NO, indicate location of nearest inclusive restroom

| YES or NO | | | |
|---|--|---|---|
| <input style="width: 80px; height: 20px;" type="text"/> | Travel distance in feet | <input style="width: 80px; height: 20px;" type="text"/> | Travel distance--number of floors |
| <input style="width: 80px; height: 20px;" type="text"/> | Travel distance in feet between building entries | <input style="width: 80px; height: 20px;" type="text"/> | Pedestrian travel time between building entries |

HARDSHIP

If space will be reassigned from programmatic or other dedicated use to construct the inclusive restroom(s), describe secondary effects of constructing restroom in this location

(Describe)

INTENT

If inclusive restroom cannot be provided in this location, describe the proposed alternate solution and how it meets the spirit and intent of the inclusive restrooms guidelines?

(Describe)

NOTES

¹ "Separate" refers to California Code of Regulations, Title 24, Part 6--California Plumbing Code, Section 422.2, Separate Facilities: "Separate toilet facilities shall be provided for each sex." See also Table 422.1 of the plumbing code for fixture count requirements.
² Include additional code-triggered required separate fixtures that must be added by the work of the new project, if any.
³ Pedestrian travel time is encouraged to be less than 2 minutes between building entrances to avoid extending break times and provide equivalent facilities
⁴ Modify form as needed if assessing changing rooms or showers

Signage Guidelines - Gender Inclusive Facilities

Updated 6/23/2020



Directional Signage – to be used if no gender inclusive facilities are available in a building.



Restroom Door Sign – Details on Page 2



Restroom Room Sign – Details on Page 3

All signs shall meet ADA and CBC Standards.

CBC/ADA Door Signage

SIGN SPECIFICATIONS

1. SIGN PANEL SUBSTRATE
 Finish Size: 9"H x 10 1/2"W
 Material: 1/4" Plaskolite Non-Glare Clear Acrylic (P99)
 Backpaint: Matthews Paint to Match 311-307 Charcoal Grey (Satin Finish)
 Edge Finish: Milled & Unpainted

2. SIGN PANEL SUBSTRATE
 Finish Size: 12"H x 12"W
 Material: 1/4" Plaskolite Non-Glare Clear Acrylic (P99)
 Backpaint: Matthews MAP-LVS202 White (Satin Finish)
 Edge Finish: Milled & Unpainted


3. SYMBOL
 Material: Second-Surface Vinyl To Match 311-307 Charcoal Grey (Opaque)
 Height: 5 1/2" Tall

4. SYMBOL
 Material: Second-Surface 3M #7725-10 Opaque White Vinyl
 Height: 5 1/2" Tall

5. ADHESIVE / TAPE FOR COMPONENTS
 Tape: Thin DT Tape

6. MOUNTING
 Tape: 1/16" Thick Double Sided Foam Tape & Silicone Adhesive

INSTALLATION PLACEMENT
 Height: 60" Bottom of Highest Tactile Letters / 48" AFF Min. to Bottom of Braille
 Placement: 9" OC of Tactile Characters From Opening of Door
 Location: Adjacent to Latch Side of Door. Refer to CSB Installation Standards

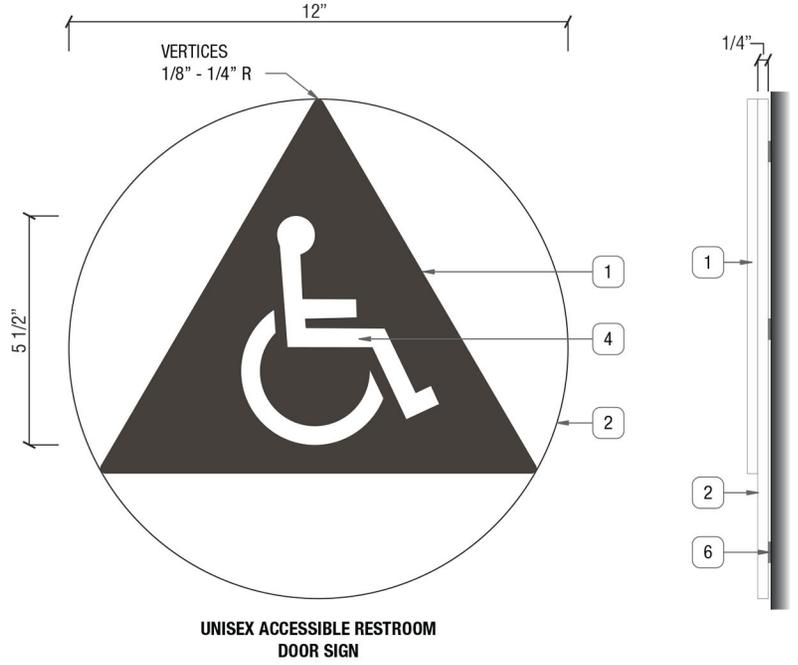

SIGN TYPE - GENDER INCLUSIVE RESTROOM

B SIDE VIEW
 SCALE: 3" = 1'-0"

COLOR LEGEND

| | |
|--|---|
| | WHITE - MATTHEWS PAINT MAP-LVS202 (SATIN FINISH) / 3M #7725-10 OPAQUE WHITE VINYL |
| | CHARCOAL GREY - 311-307 CHARCOAL GREY - VINYL / MATTHEWS PAINT TO MATCH (SATIN FINISH) |

Restroom Signage (Wall Mt.)

SIGN SPECIFICATIONS

1. SIGN PANEL SUBSTRATE

Finish Size: 6 1/4"H x 10"W
 Material: 1/4" Plaskolite Non-Glare Clear Acrylic (P99)
 Backpaint: Matthews MAP-LVS202 White (Satin Finish)
 Edge Finish: Milled & Unpainted

2. TACTILE APPLIQUE

Material: Modified Acrylic
 Font Height: 5/8" Tall
 Symbol Heights: 4 1/2" / 2 7/8"
 Depth: 1/32" Thick
 Font: DIN Medium
 Color: 311-307 Charcoal Grey

3. BRAILLE

Type: Clear Grade II Braille

4. DECORATIVE METAL BAR

Material: 6063 Aluminum Square 1/4" x 10"
 Finish: #4 Brushed Finish (Horizontal Grain)
 Fastener: Thin DT Tape

5. ADHESIVE / TAPE FOR COMPONENTS

Tape: Thin DT Tape

6. MOUNTING

Tape: 1/16" Thick Double Sided Foam Tape & Silicone Adhesive

INSTALLATION PLACEMENT


Height: 60" Bottom of Highest Tactile Letters / 48" AFF Min. to Bottom of Braille
 Placement: 9" OC of Tactile Characters From Opening of Door
 Location: Adjacent to Latch Side of Door. Refer to CSB Installation Standards



TOTAL QTY. : 8

A ELEVATION
SCALE: HALF-SIZE


SIGN TYPE - GENDER INCLUSIVE
RESTROOM

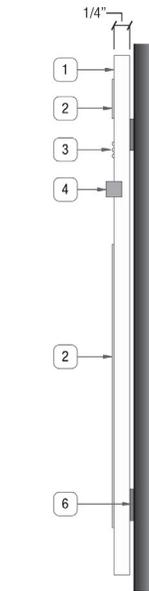


B SIDE VIEW
SCALE: HALF-SIZE

COLOR LEGEND

| | |
|--|--|
| | WHITE - MATTHEWS PAINT MAP-LVS202 (SATIN FINISH) |
| | CHARCOAL GREY - TACTILE: 311-307 CHARCOAL GREY / MATTHEWS PAINT TO MATCH (SATIN FINISH) |
| | #4 BRUSHED FINISH (HORIZONTAL GRAIN) |

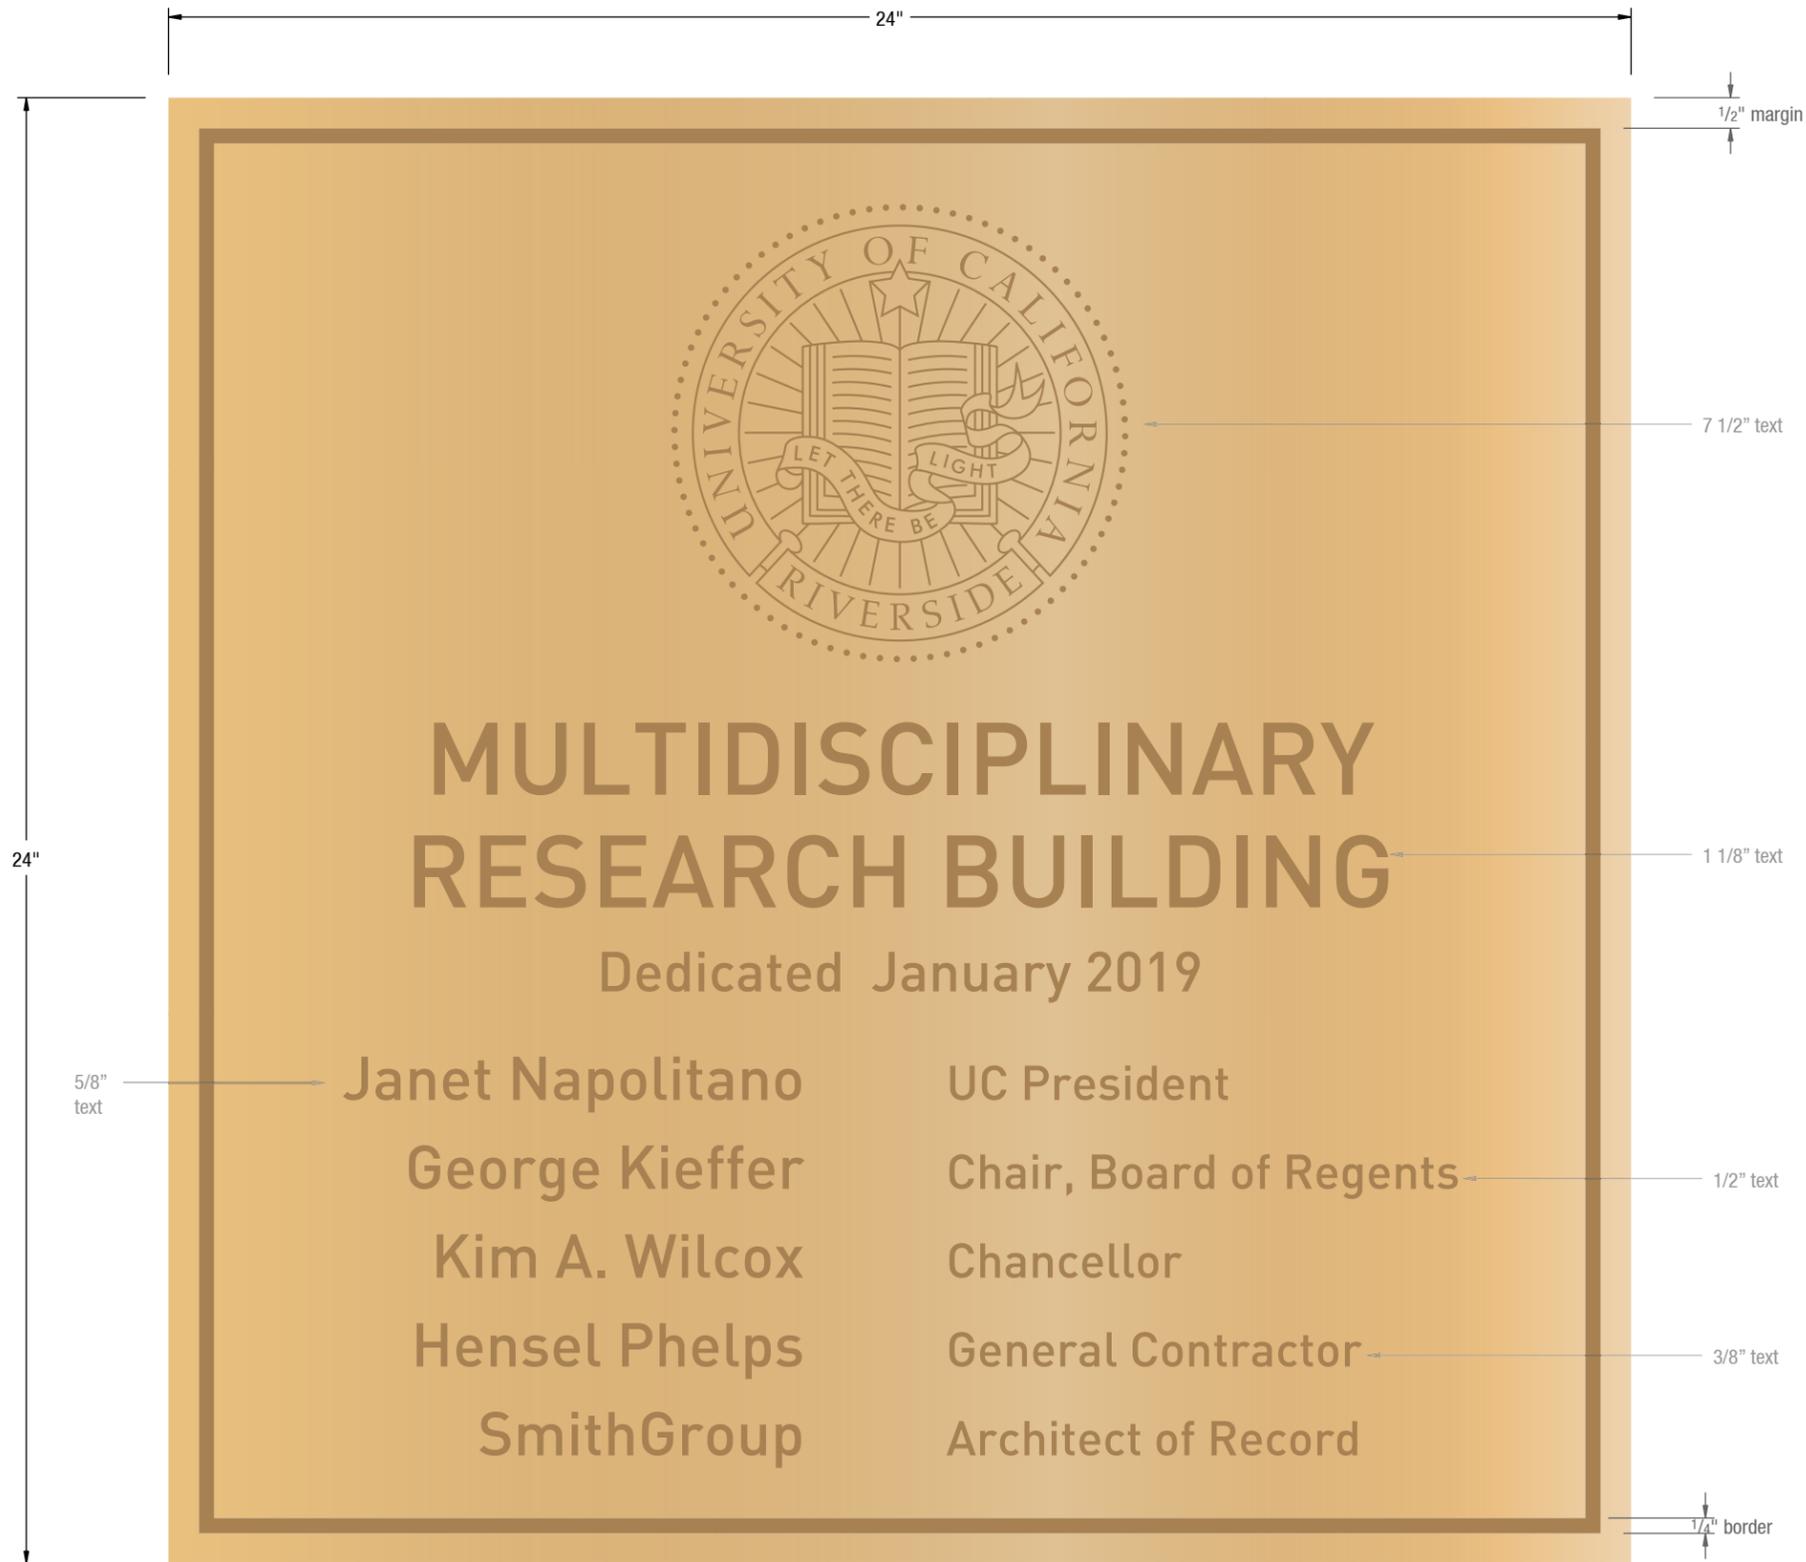

A FRONT ELEVATION
SCALE 1:3

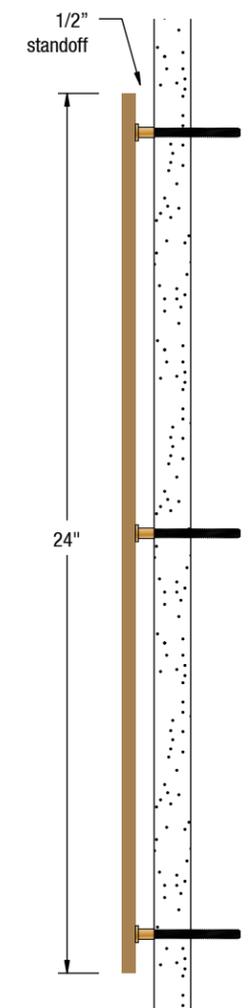

B SIDE SECTION
SCALE 1:5

SIGN SPECIFICATIONS

- 1. SIGN PANEL SUBSTRATE**
Finish Sizes:
- 12" H x 18" W
Material: Cast Bronze (horizontal grain)
Return: 5/16"
- 2. TEXT**
Finish: Natural Satin (horizontal grain)
Clear Coat: Semi-Gloss
Recessed Texture: Sand
Recessed Paint Fill: 0312 Medium Bronze
Fonts: DIN Medium
Brushed Bronze = Raised
Text = Recessed
- 3. MOUNTING**
Studs: 10/24 Blind Stud - 2" length
Standoffs: 1/2"
Border: 1/8" Outline
Edges: Square
Mounting Pattern: Yes
- 4. MOUNTING SURFACE**
Brick

**Cast Bronze with Recessed Text.
Paint filled medium bronze text.**



Material
Grain Runs Horizontal
On Finish Product



Paint Fill

C FINISH
SCALE: NTS

FILE PATH Q:\UCR MRB1\20180426 UCR Contract\Renderings, Submittals & PDFs\Submittals\UCR MRB1_SignSubmittal



CONTACT
Albuquerque / Phoenix
P 505.888.2901 ext 109
F 505.888.2902
csbsigns.com


DRAWN BY
Lawrence Spingola
Lawrence Spingola@csbsigns.com
This artwork and design is owned by Century Sign Builders unless expressly stated. Use of this document or the design shown here without permission is prohibited.


CLIENT / PROJECT
Client / GC: Hensel Phelps
Project: University of California, Riverside - MRB1
APPROVAL REQUIRED FOR PRODUCTION

DATE
Modification Date: November 29, 2018 9:10 AM

SHEET TITLE
Sign Type PLQ
Building Dedication Plaque

SHEET
27

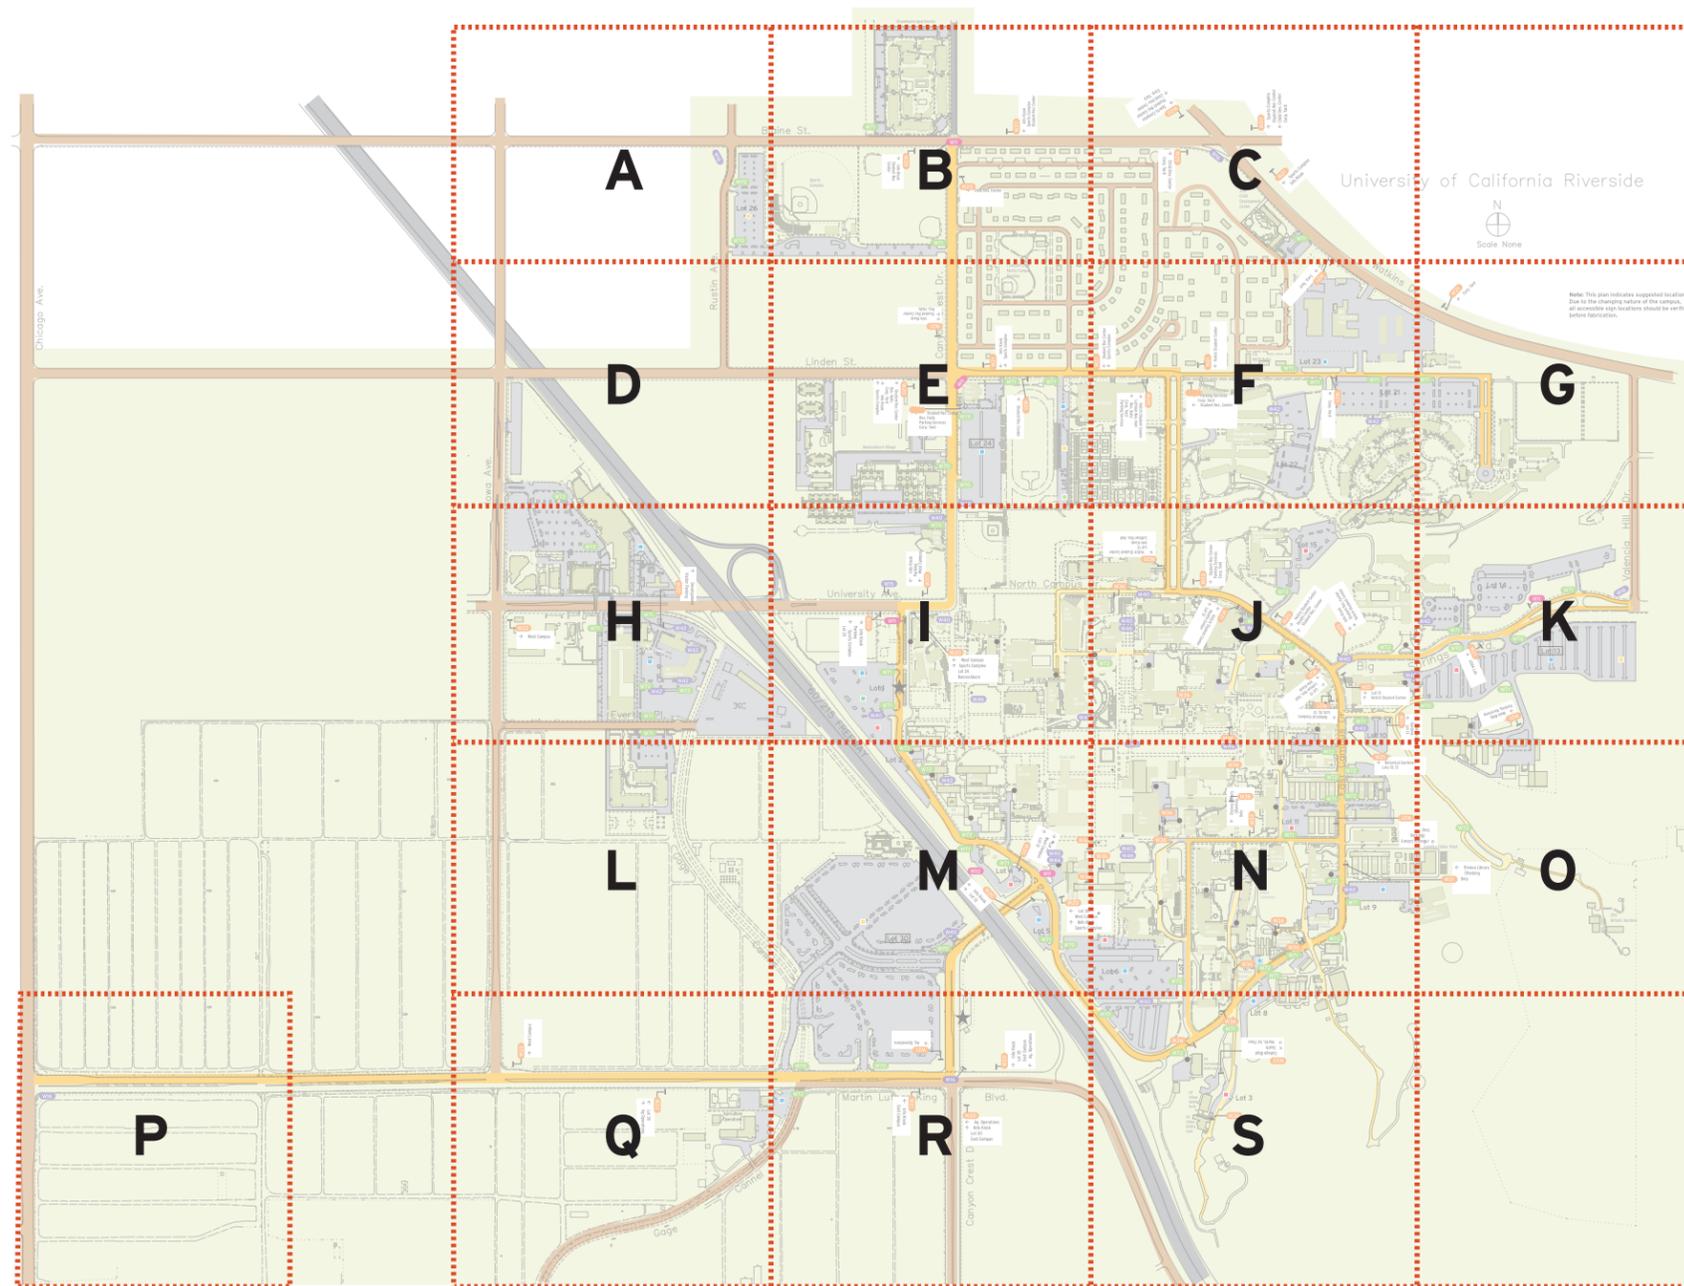

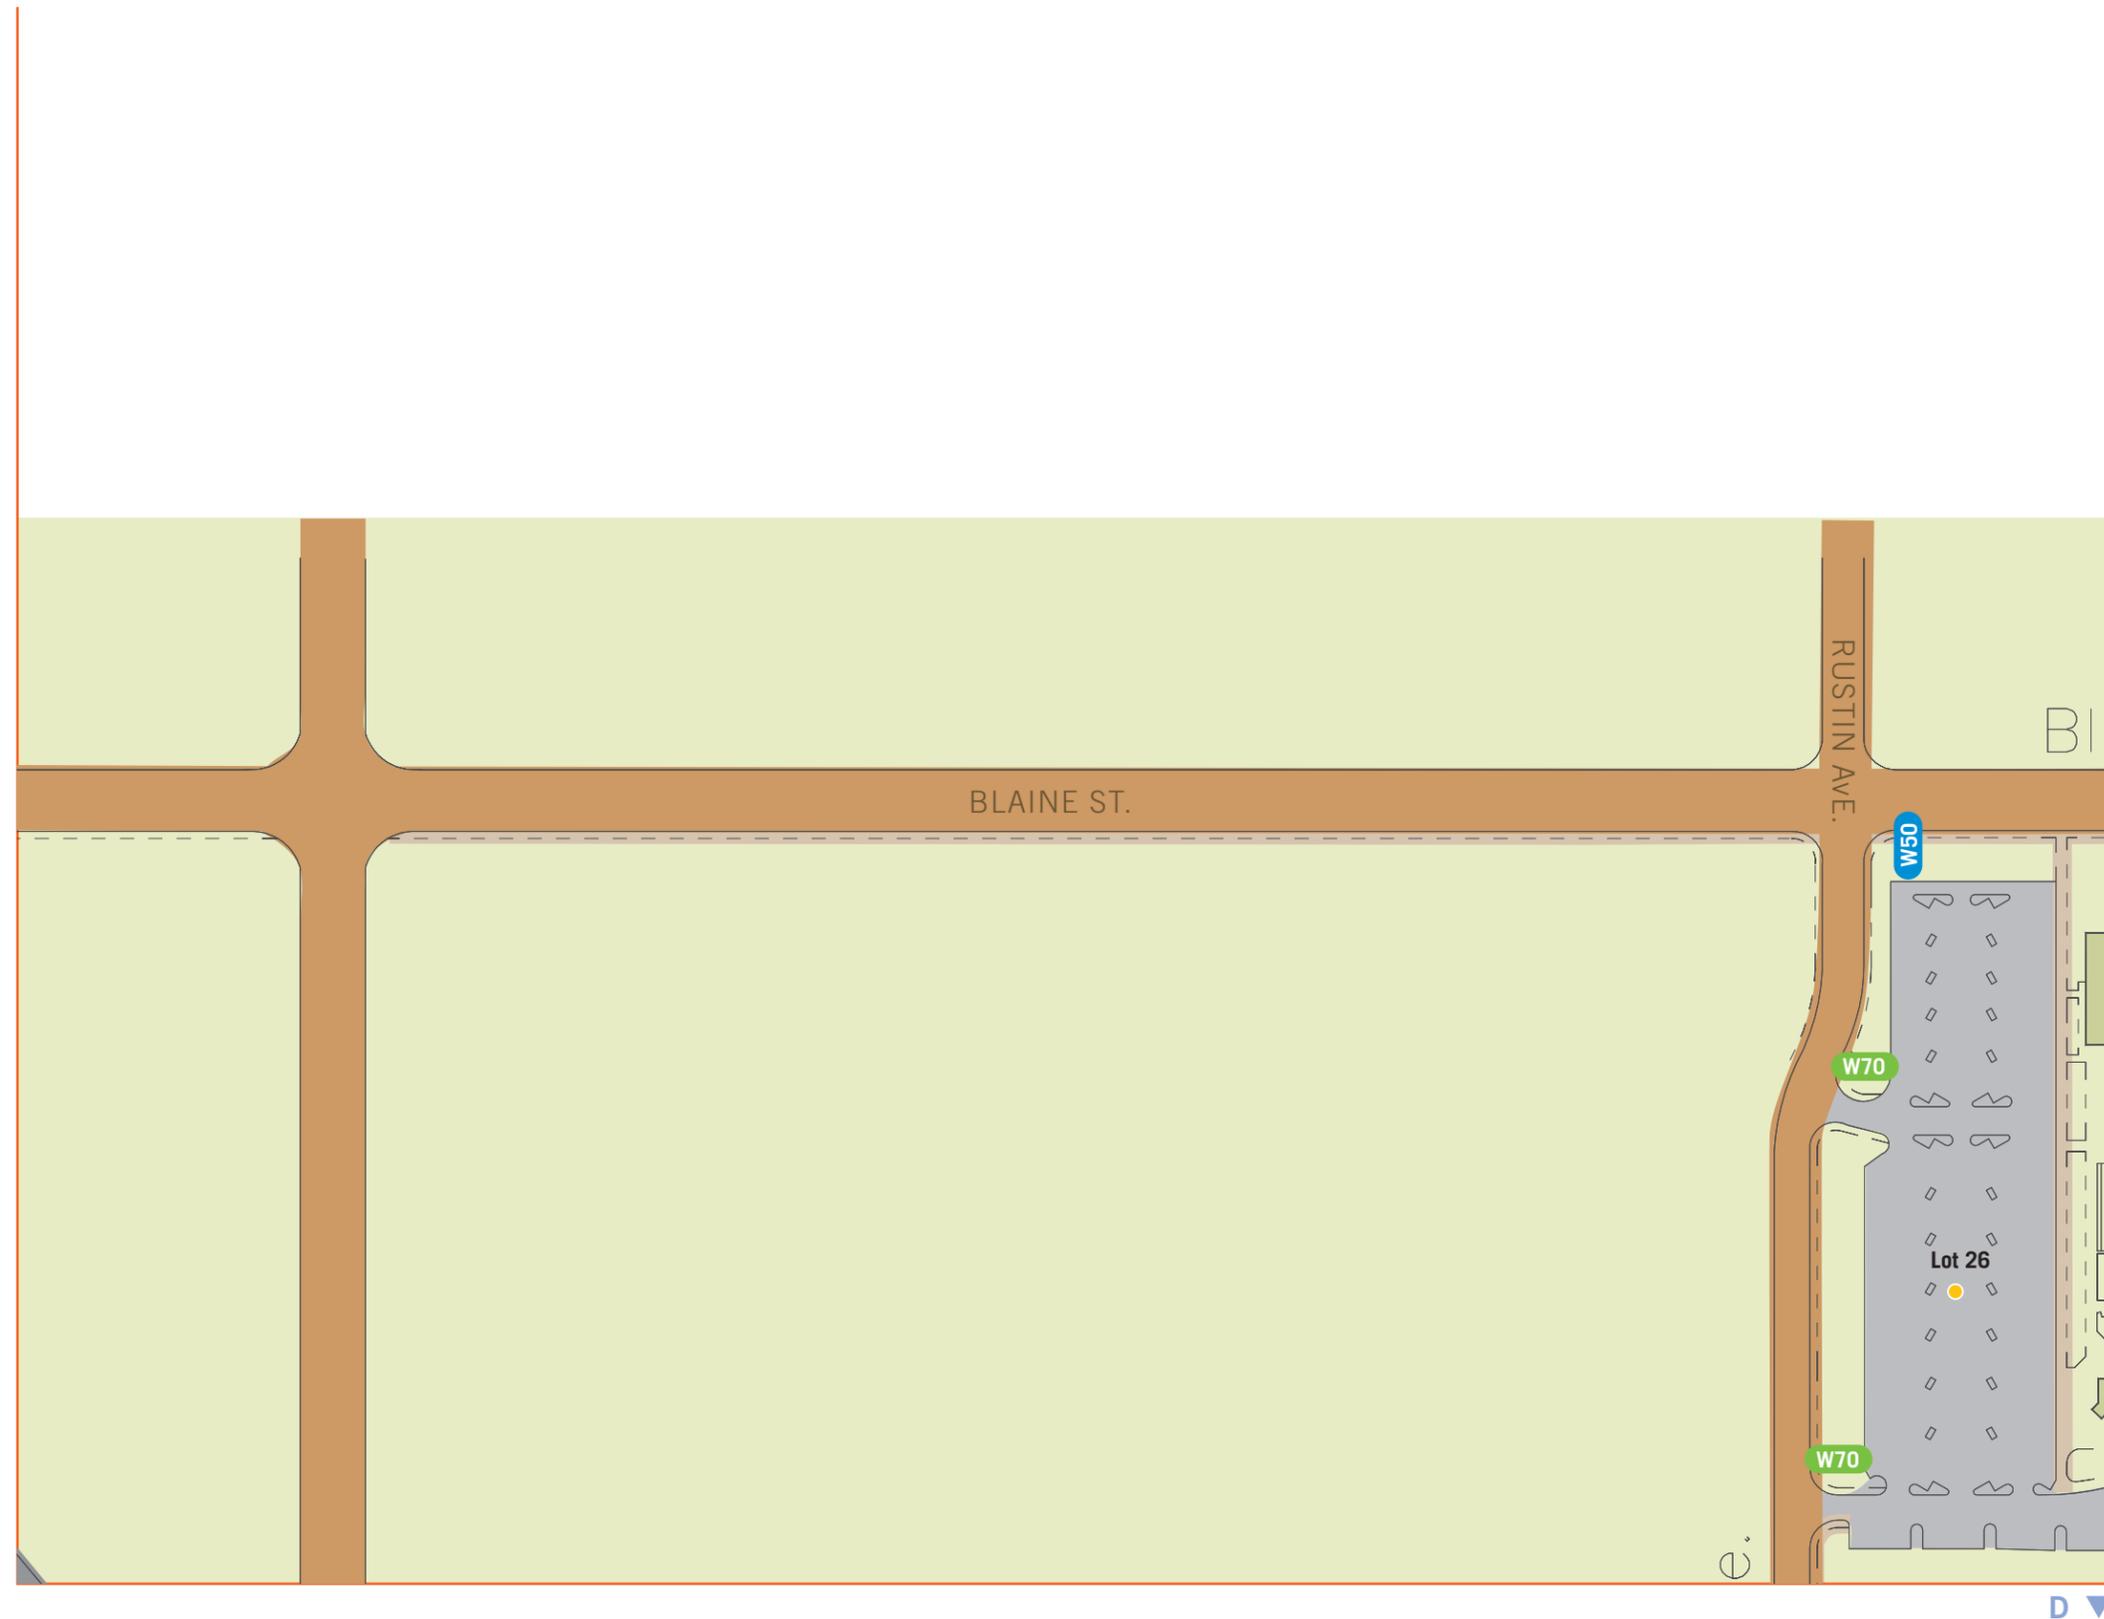

- Legend**
- Off campus vehicular circulation
 - On campus primary veh. circulation
 - On campus secondary veh. circulation
 - Primary Pedestrian Circulation
 - Secondary Pedestrian Circulation
 - Parking Lot Permit Zones
 - ★ Information Kiosk
 - ▲ Existing Postings
 - Electronic Message Boards**
W10 Site ID, Freeway
W11 Campus ID
 - Campus Entry Monument**
W15 Primary ID
W16 Secondary ID
 - Pedestrian Information**
W36 Accessible Pathway
 - Pedestrian Information**
W40 Freestanding Directory, primary
W41 Wall Mounted Directory
W42 Freestanding Directory, secondary
W46 Info Kiosk, Posted Messages
W48 Interactive Kiosk
 - Building Identity**
W50 Primary, vehicular
W51 Freestanding, Ped
 - Parking Lot Id/Info**
W70 Primary ID
W71 Secondary ID
W72 Pole Mounted ID
 - W97 Street Signs

Note:
Lozenge orientation does not necessarily represent accurate sign placement.

A



- Legend**
- Off campus vehicular circulation
 - On campus primary veh. circulation
 - On campus secondary veh. circulation
 - Primary Pedestrian Circulation
 - Secondary Pedestrian Circulation
 - Parking Lot Permit Zones
 - Information Kiosk
 - Existing Postings
 - Electronic Message Boards**
W10 Site ID, Freeway
W11 Campus ID
 - Campus Entry Monument**
W15 Primary ID
W16 Secondary ID
 - Pedestrian Information**
W36 Accessible Pathway
 - Pedestrian Information**
W40 Freestanding Directory, primary
W41 Wall Mounted Directory
W42 Freestanding Directory, secondary
W46 Info Kiosk, Posted Messages
W48 Interactive Kiosk
 - Building Identity**
W50 Primary, vehicular
W51 Freestanding, Ped
 - Parking Lot Id/Info**
W70 Primary ID
W71 Secondary ID
W72 Pole Mounted ID
 - W97 Street Signs

Note:
Lozenge orientation does not necessarily represent accurate sign placement.

E

B ◀




Universi

- Legend**
- Off campus vehicular circulation
 - On campus primary veh. circulation
 - On campus secondary veh. circulation
 - Primary Pedestrian Circulation
 - Secondary Pedestrian Circulation
 - Parking Lot Permit Zones
 - Information Kiosk
 - Existing Postings
 - Electronic Message Boards**
W10 Site ID, Freeway
W11 Campus ID
 - Campus Entry Monument**
W15 Primary ID
W16 Secondary ID
 - Pedestrian Information**
W36 Accessible Pathway
 - Pedestrian Information**
W40 Freestanding Directory, primary
W41 Wall Mounted Directory
W42 Freestanding Directory, secondary
W46 Info Kiosk, Posted Messages
W48 Interactive Kiosk
 - Building Identity**
W50 Primary, vehicular
W51 Freestanding, Ped
 - Parking Lot Id/Info**
W70 Primary ID
W71 Secondary ID
W72 Pole Mounted ID
 - W97 Street Signs

Note:
Lozenge orientation does not necessarily represent accurate sign placement.

F ▼

▲ A

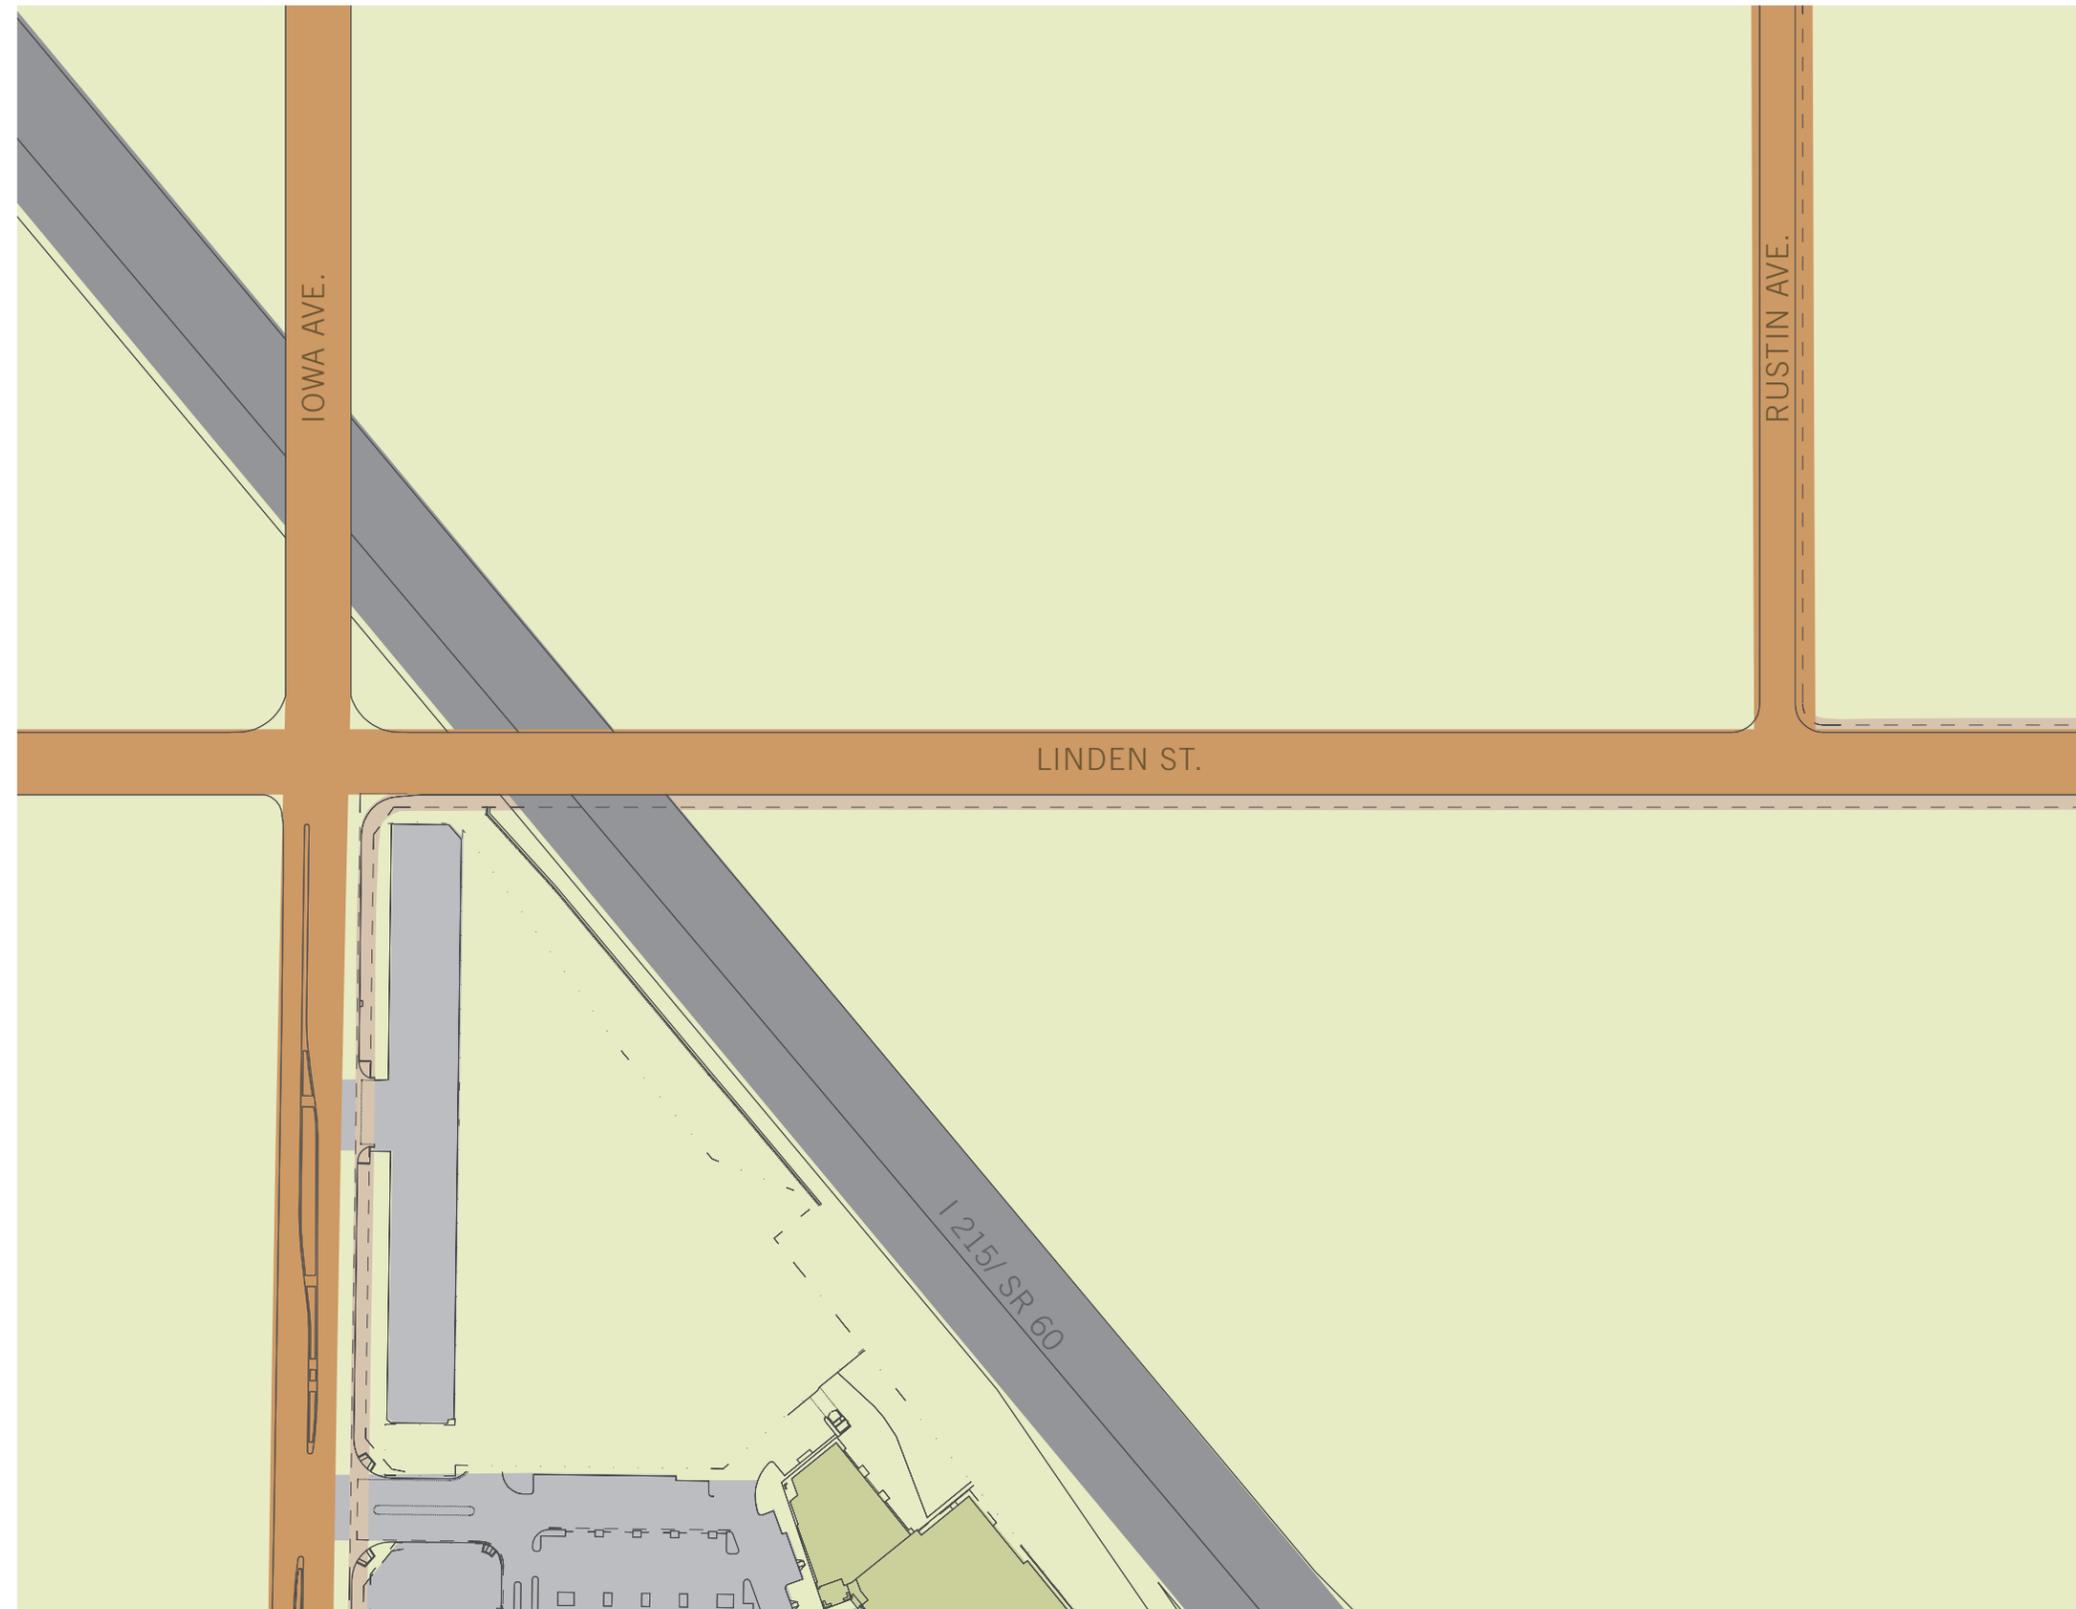

H ▼ E

- Legend**
- Off campus vehicular circulation
 - On campus primary veh. circulation
 - On campus secondary veh. circulation
 - Primary Pedestrian Circulation
 - Secondary Pedestrian Circulation
 - Parking Lot Permit Zones
 - Information Kiosk
 - Existing Postings
 - Electronic Message Boards**
W10 Site ID, Freeway
W11 Campus ID
 - Campus Entry Monument**
W15 Primary ID
W16 Secondary ID
 - Pedestrian Information**
W36 Accessible Pathway
 - Pedestrian Information**
W40 Freestanding Directory, primary
W41 Wall Mounted Directory
W42 Freestanding Directory, secondary
W46 Info Kiosk, Posted Messages
W48 Interactive Kiosk
 - Building Identity**
W50 Primary, vehicular
W51 Freestanding, Ped
 - Parking Lot Id/Info**
W70 Primary ID
W71 Secondary ID
W72 Pole Mounted ID
 - W97 Street Signs

Note:
Lozenge orientation does not necessarily represent accurate sign placement.

▲ B
D ◀




- Legend**
- Off campus vehicular circulation
 - On campus primary veh. circulation
 - On campus secondary veh. circulation
 - Primary Pedestrian Circulation
 - Secondary Pedestrian Circulation
 - Parking Lot Permit Zones
 - Information Kiosk
 - Existing Postings
 - Electronic Message Boards**
W10 Site ID, Freeway
W11 Campus ID
 - Campus Entry Monument**
W15 Primary ID
W16 Secondary ID
 - Pedestrian Information**
W36 Accessible Pathway
 - Pedestrian Information**
W40 Freestanding Directory, primary
W41 Wall Mounted Directory
W42 Freestanding Directory, secondary
W46 Info Kiosk, Posted Messages
W48 Interactive Kiosk
 - Building Identity**
W50 Primary, vehicular
W51 Freestanding, Ped
 - Parking Lot Id/Info**
W70 Primary ID
W71 Secondary ID
W72 Pole Mounted ID
 - W97 Street Signs

Note:
Lozenge orientation does not necessarily represent accurate sign placement.

▶ F
I ▼

E

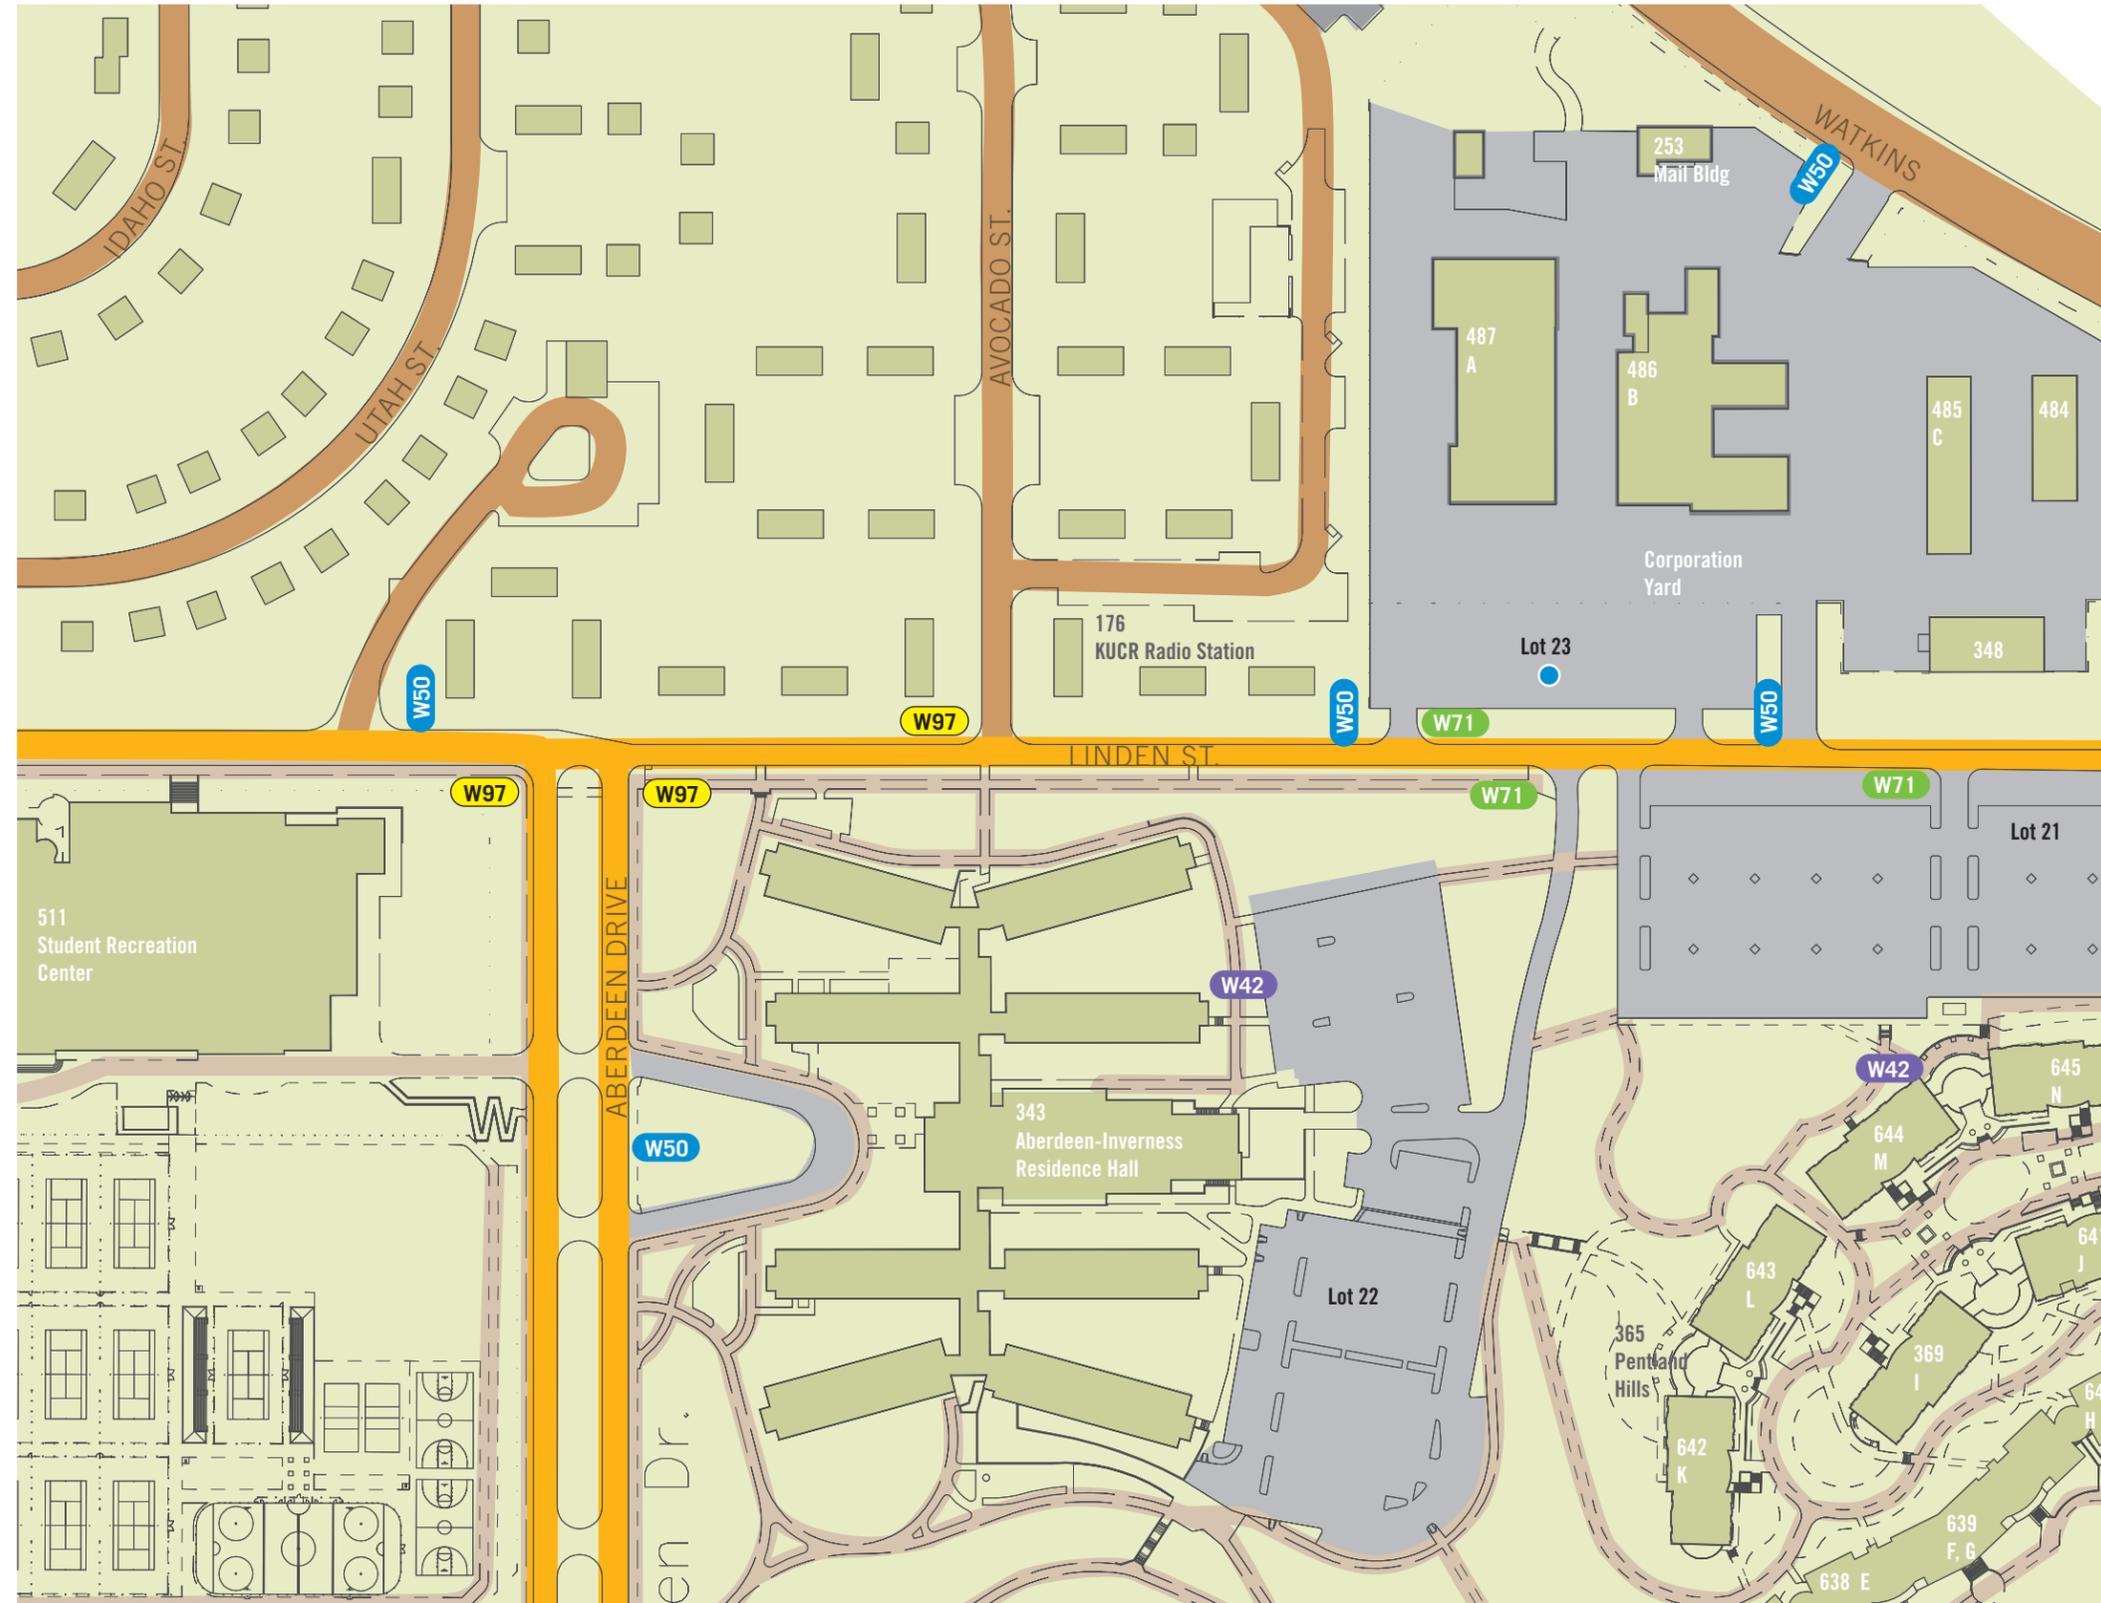


- Legend**
- Off campus vehicular circulation
 - On campus primary veh. circulation
 - On campus secondary veh. circulation
 - Primary Pedestrian Circulation
 - Secondary Pedestrian Circulation
 - Parking Lot Permit Zones
 - Information Kiosk
 - Existing Postings
 - Electronic Message Boards**
W10 Site ID, Freeway
W11 Campus ID
 - Campus Entry Monument**
W15 Primary ID
W16 Secondary ID
 - Pedestrian Information**
W36 Accessible Pathway
 - Pedestrian Information**
W40 Freestanding Directory, primary
W41 Wall Mounted Directory
W42 Freestanding Directory, secondary
W46 Info Kiosk, Posted Messages
W48 Interactive Kiosk
 - Building Identity**
W50 Primary, vehicular
W51 Freestanding, Ped
 - Parking Lot Id/Info**
W70 Primary ID
W71 Secondary ID
W72 Pole Mounted ID
 - W97 Street Signs

Note:
Lozenge orientation does not necessarily represent accurate sign placement.

J

F ◀

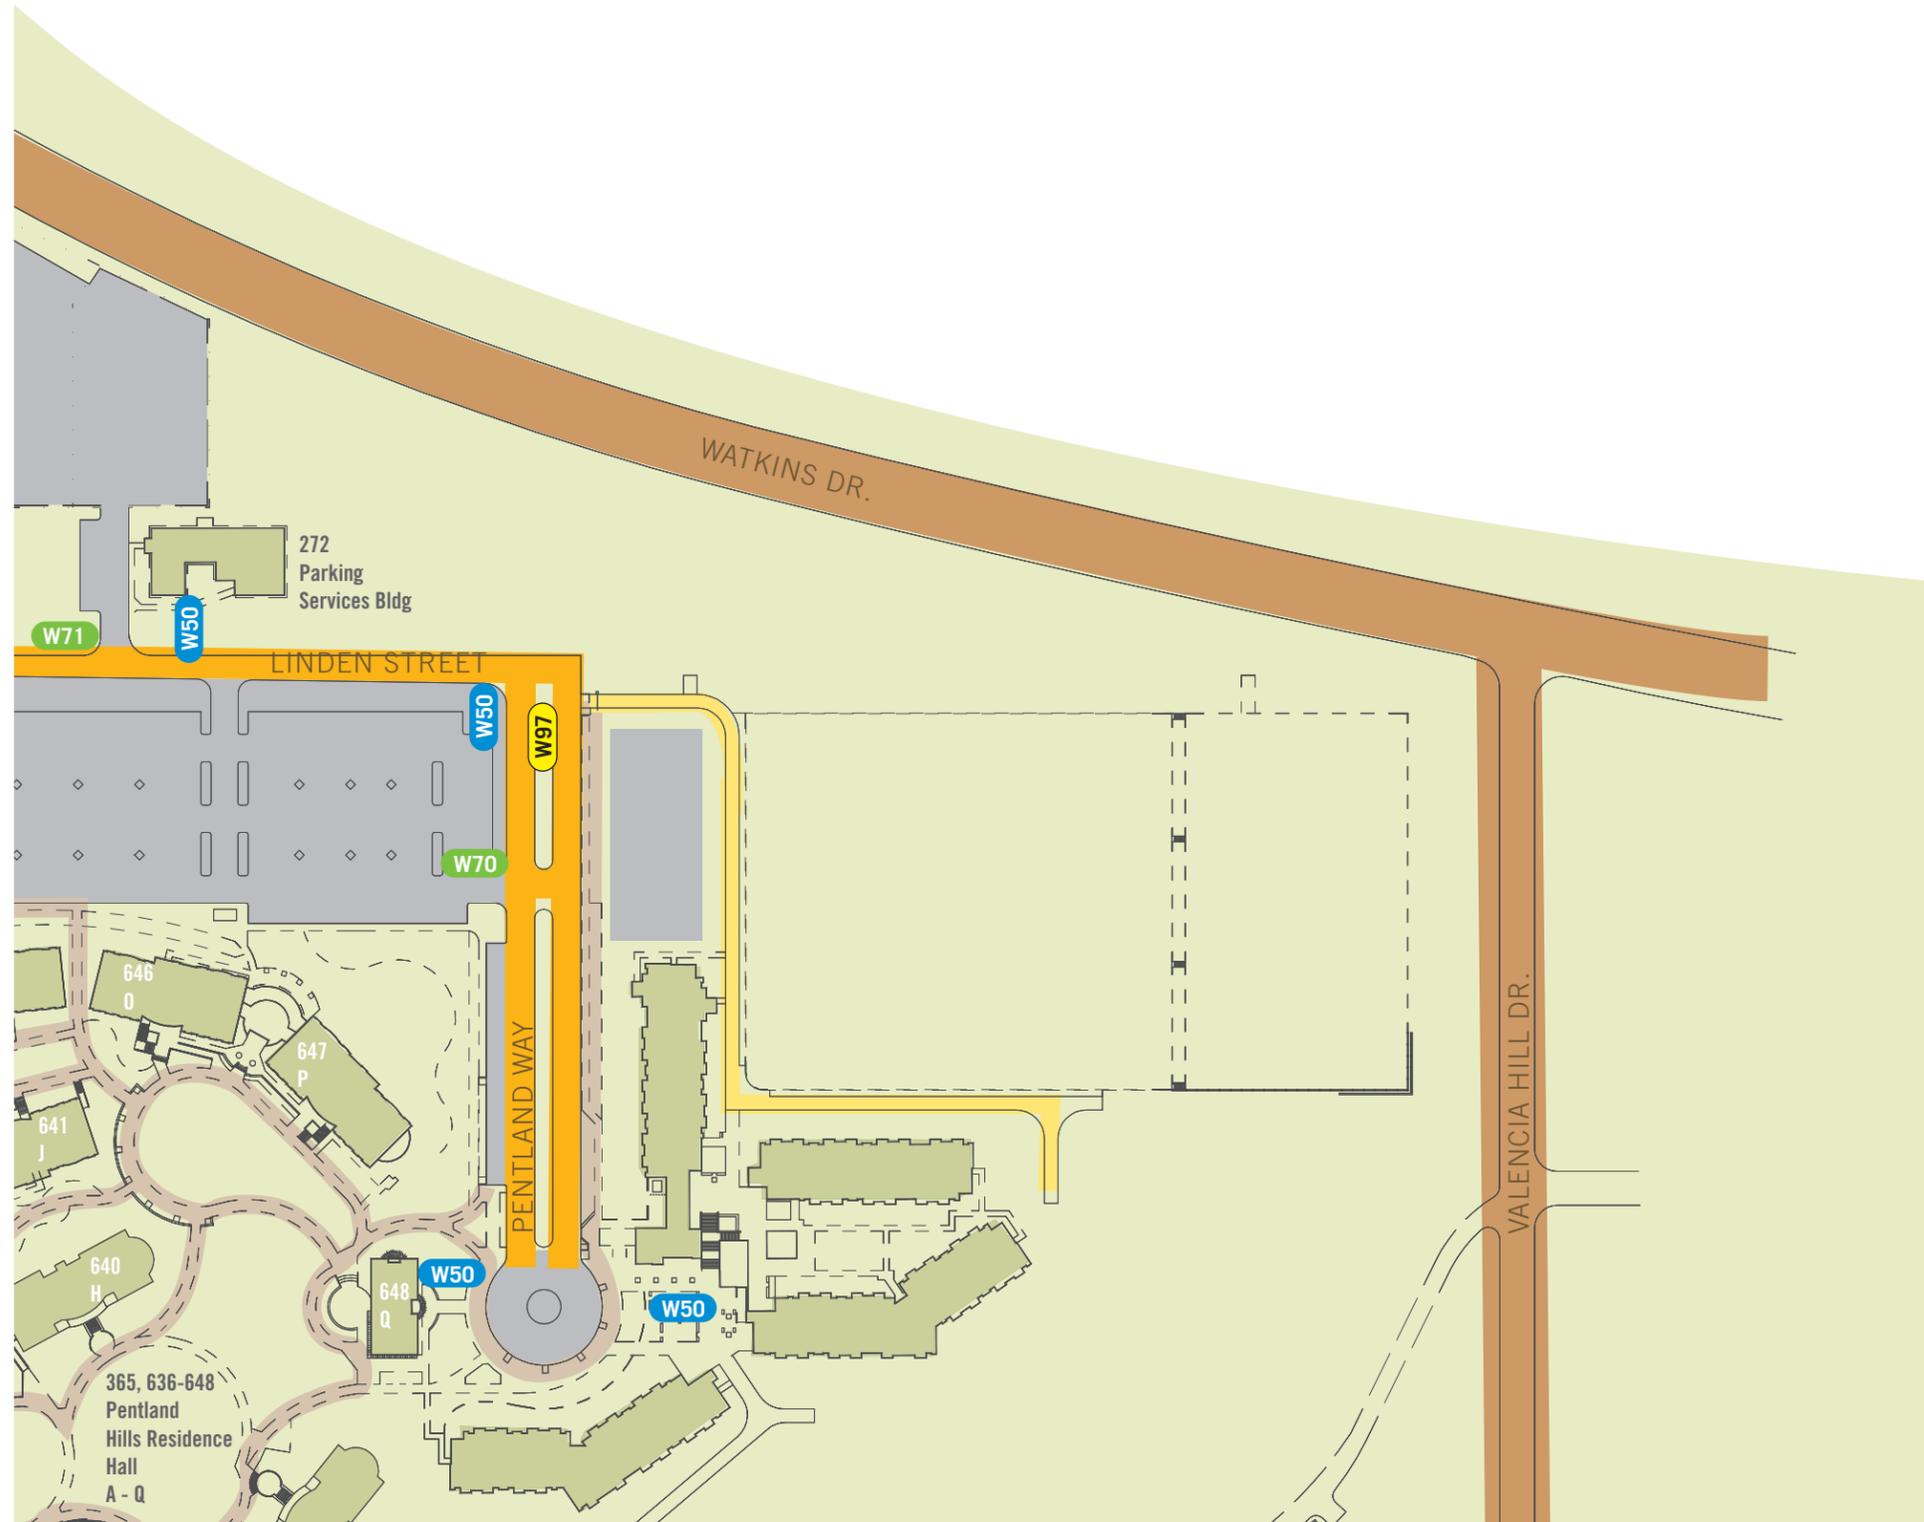


Legend

- Off campus vehicular circulation
- On campus primary veh. circulation
- On campus secondary veh. circulation
- Primary Pedestrian Circulation
- Secondary Pedestrian Circulation
- Parking Lot Permit Zones
- ★ Information Kiosk
- ▲ Existing Postings
- Electronic Message Boards**
W10 Site ID, Freeway
W11 Campus ID
- Campus Entry Monument**
W15 Primary ID
W16 Secondary ID
- Pedestrian Information**
W36 Accessible Pathway
- Pedestrian Information**
W40 Freestanding Directory, primary
W41 Wall Mounted Directory
W42 Freestanding Directory, secondary
W46 Info Kiosk, Posted Messages
W48 Interactive Kiosk
- Building Identity**
W50 Primary, vehicular
W51 Freestanding, Ped
- Parking Lot Id/Info**
W70 Primary ID
W71 Secondary ID
W72 Pole Mounted ID
- W97 Street Signs

Note:
Lozenge orientation does not necessarily represent accurate sign placement.

K ▼

▲ D

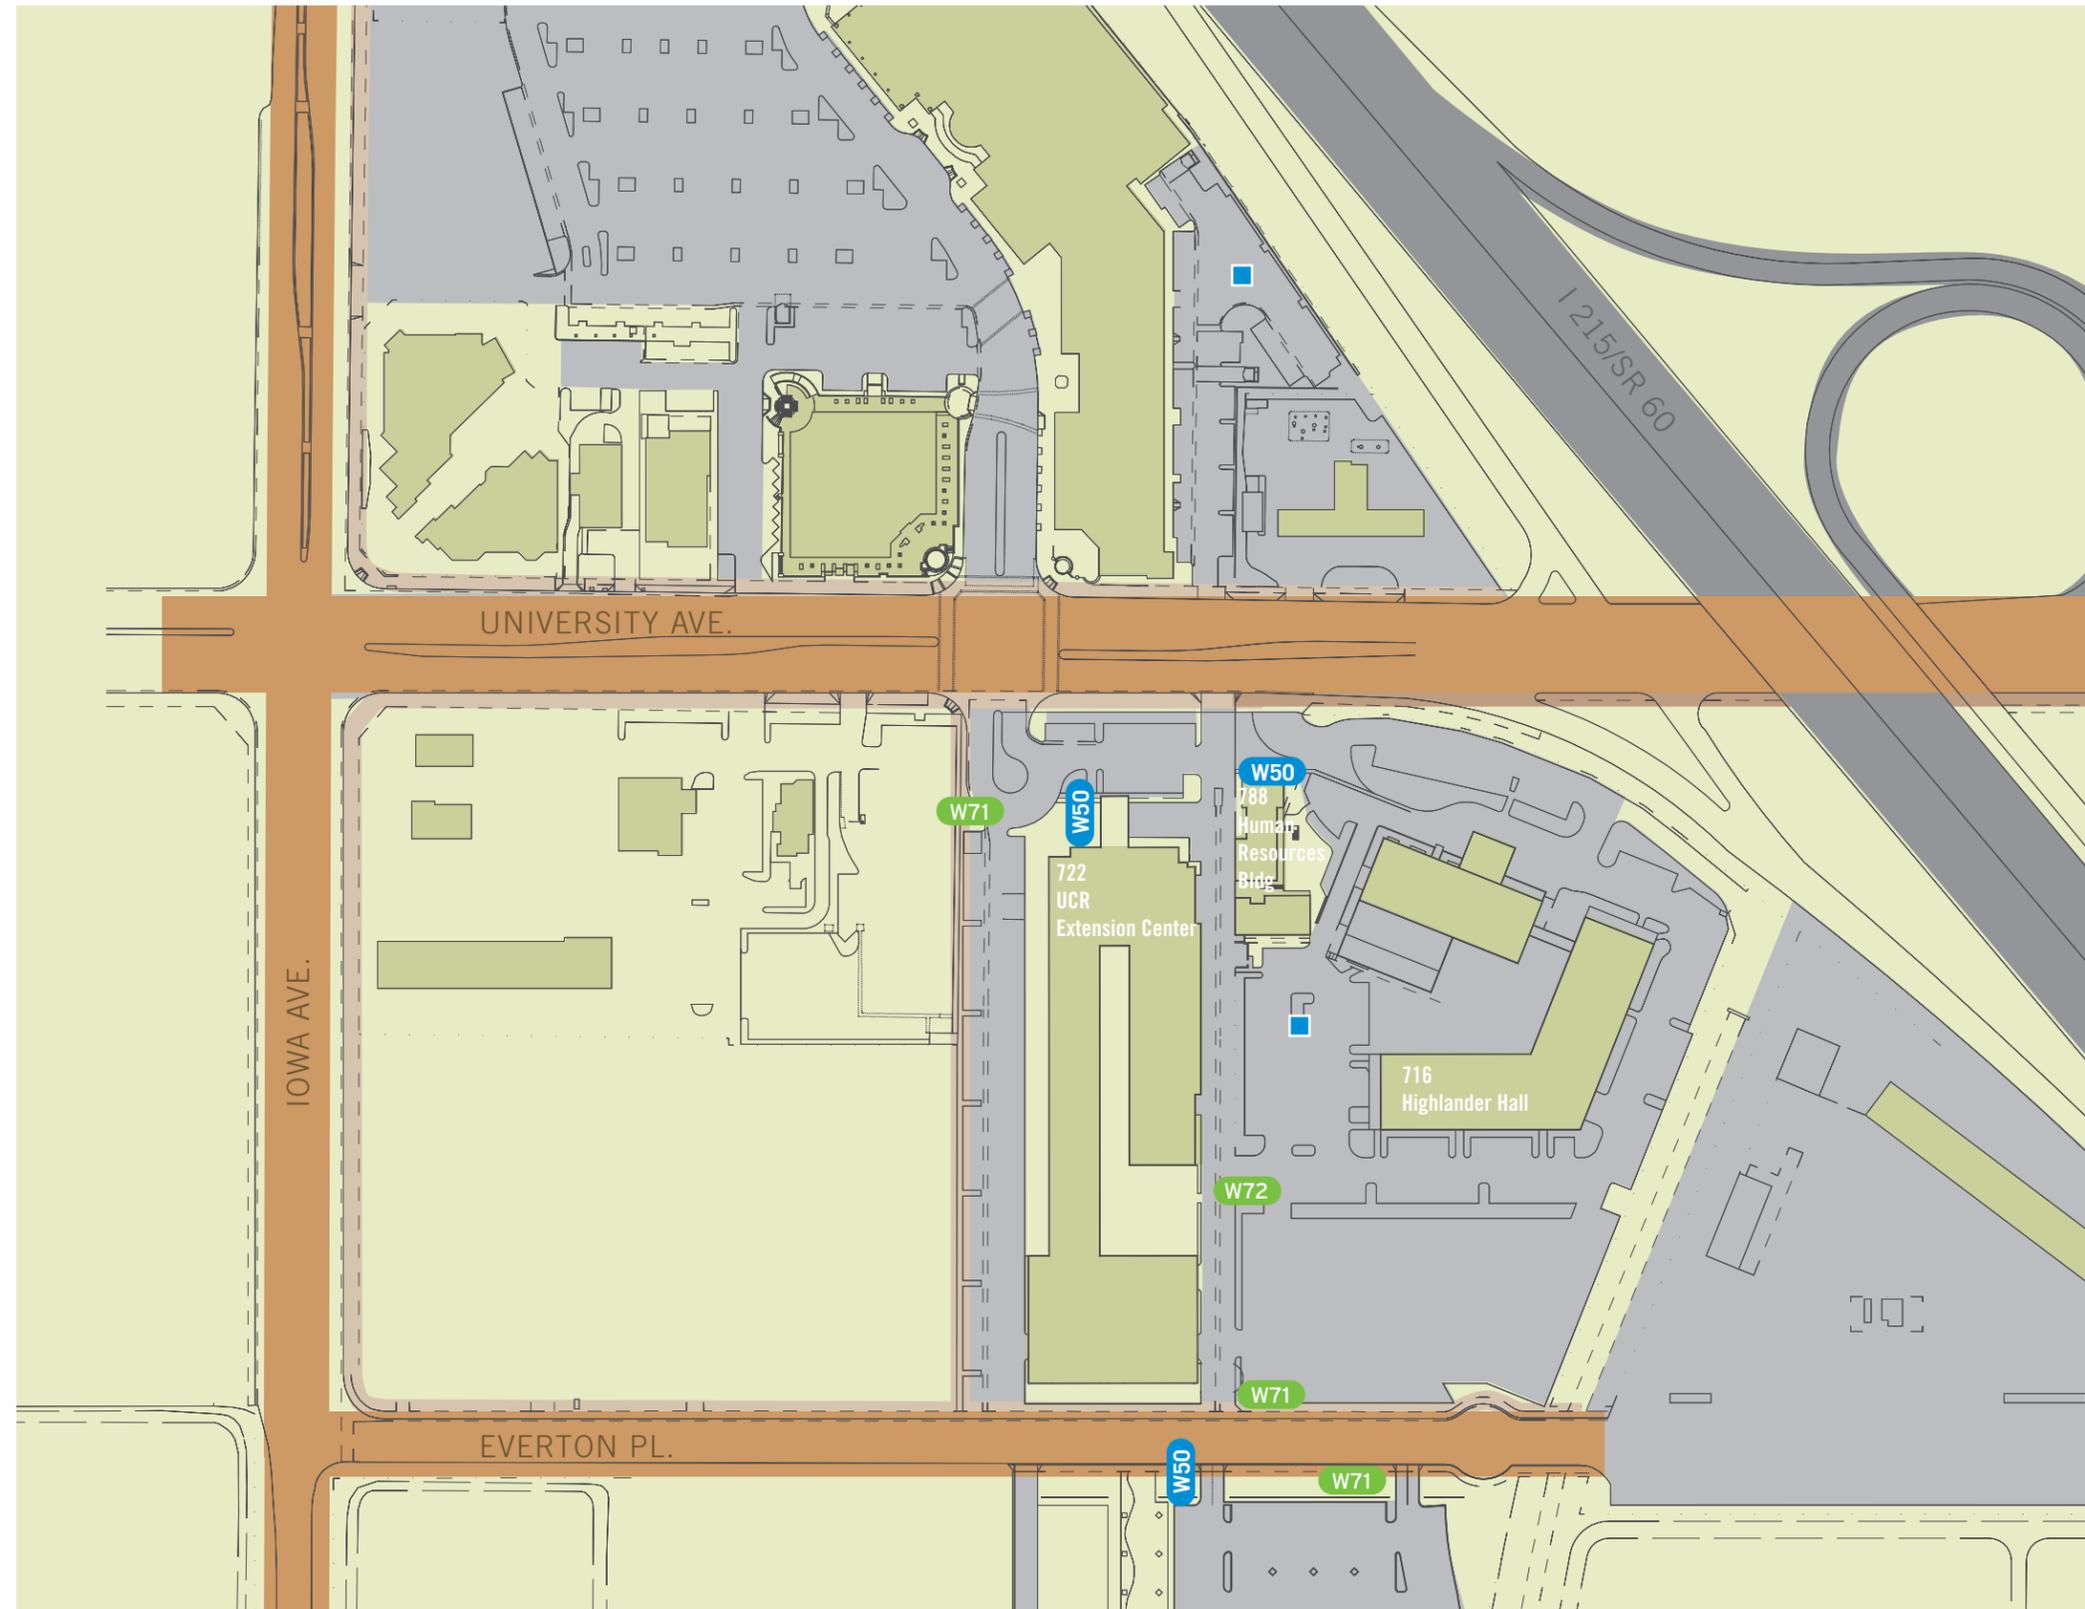

- Legend**
- Off campus vehicular circulation
 - On campus primary veh. circulation
 - On campus secondary veh. circulation
 - Primary Pedestrian Circulation
 - Secondary Pedestrian Circulation
 - Parking Lot Permit Zones
 - ★ Information Kiosk
 - ▲ Existing Postings
 - Electronic Message Boards**
W10 Site ID, Freeway
W11 Campus ID
 - Campus Entry Monument**
W15 Primary ID
W16 Secondary ID
 - Pedestrian Information**
W36 Accessible Pathway
 - Pedestrian Information**
W40 Freestanding Directory, primary
W41 Wall Mounted Directory
W42 Freestanding Directory, secondary
W46 Info Kiosk, Posted Messages
W48 Interactive Kiosk
 - Building Identity**
W50 Primary, vehicular
W51 Freestanding, Ped
 - Parking Lot Id/Info**
W70 Primary ID
W71 Secondary ID
W72 Pole Mounted ID
 - W97 Street Signs

Note:
Lozenge orientation does not necessarily represent accurate sign placement.

▲ I
L ▼

H ▲ E
H ◀



- Legend**
- Off campus vehicular circulation
 - On campus primary veh. circulation
 - On campus secondary veh. circulation
 - Primary Pedestrian Circulation
 - Secondary Pedestrian Circulation
 - Parking Lot Permit Zones
 - Information Kiosk
 - Existing Postings
 - Electronic Message Boards**
W10 Site ID, Freeway
W11 Campus ID
 - Campus Entry Monument**
W15 Primary ID
W16 Secondary ID
 - Pedestrian Information**
W36 Accessible Pathway
 - Pedestrian Information**
W40 Freestanding Directory, primary
W41 Wall Mounted Directory
W42 Freestanding Directory, secondary
W46 Info Kiosk, Posted Messages
W48 Interactive Kiosk
 - Building Identity**
W50 Primary, vehicular
W51 Freestanding, Ped
 - Parking Lot Id/Info**
W70 Primary ID
W71 Secondary ID
W72 Pole Mounted ID
 - W97 Street Signs

Note:
Lozenge orientation does not necessarily represent accurate sign placement.


▶ J
M ▼



- Legend**
- Off campus vehicular circulation
 - On campus primary veh. circulation
 - On campus secondary veh. circulation
 - Primary Pedestrian Circulation
 - Secondary Pedestrian Circulation
 - Parking Lot Permit Zones
 - Information Kiosk
 - Existing Postings
 - Electronic Message Boards**
W10 Site ID, Freeway
W11 Campus ID
 - Campus Entry Monument**
W15 Primary ID
W16 Secondary ID
 - Pedestrian Information**
W36 Accessible Pathway
 - Pedestrian Information**
W40 Freestanding Directory, primary
W41 Wall Mounted Directory
W42 Freestanding Directory, secondary
W46 Info Kiosk, Posted Messages
W48 Interactive Kiosk
 - Building Identity**
W50 Primary, vehicular
W51 Freestanding, Ped
 - Parking Lot Id/Info**
W70 Primary ID
W71 Secondary ID
W72 Pole Mounted ID
 - W97 Street Signs

Note:
Lozenge orientation does not necessarily represent accurate sign placement.

▲ H

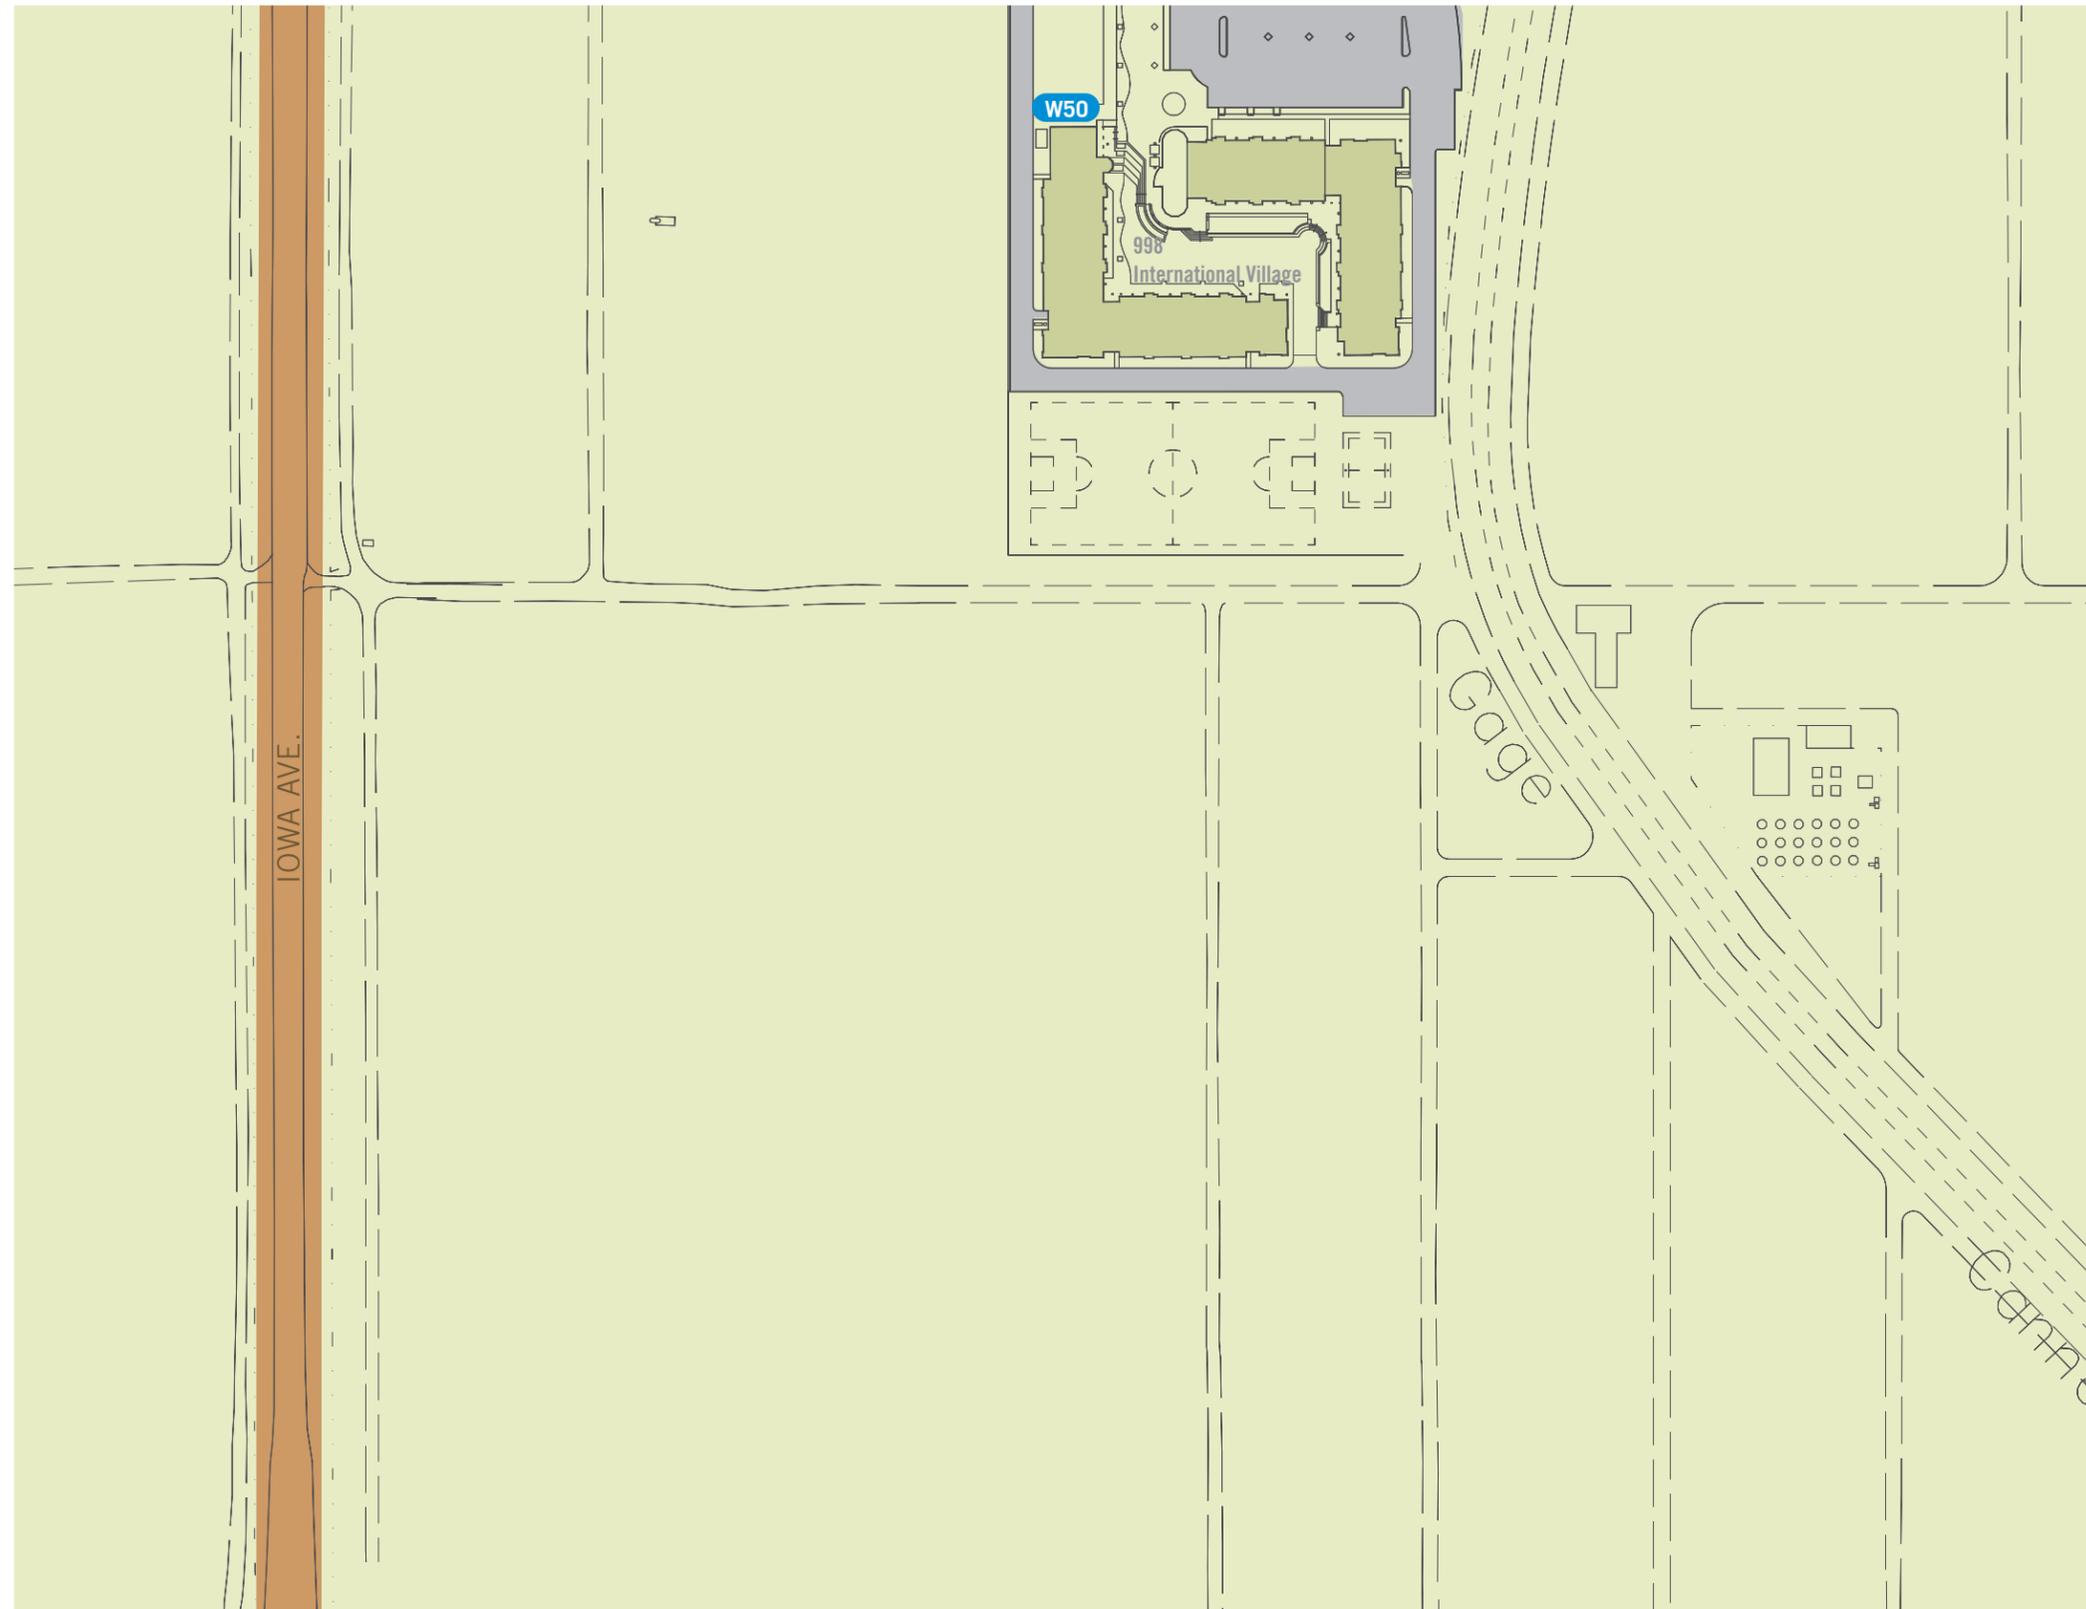

Legend

- Off campus vehicular circulation
- On campus primary veh. circulation
- On campus secondary veh. circulation
- Primary Pedestrian Circulation
- Secondary Pedestrian Circulation
- Parking Lot Permit Zones
- ★ Information Kiosk
- ▲ Existing Postings
- Electronic Message Boards**
W10 Site ID, Freeway
W11 Campus ID
- Campus Entry Monument**
W15 Primary ID
W16 Secondary ID
- Pedestrian Information**
W36 Accessible Pathway
- Pedestrian Information**
W40 Freestanding Directory, primary
W41 Wall Mounted Directory
W42 Freestanding Directory, secondary
W46 Info Kiosk, Posted Messages
W48 Interactive Kiosk
- Building Identity**
W50 Primary, vehicular
W51 Freestanding, Ped
- Parking Lot Id/Info**
W70 Primary ID
W71 Secondary ID
W72 Pole Mounted ID
- W97 Street Signs

Note:
Lozenge orientation does not necessarily represent accurate sign placement.

▶ M
P ▼



- Legend**
- Off campus vehicular circulation
 - On campus primary veh. circulation
 - On campus secondary veh. circulation
 - Primary Pedestrian Circulation
 - Secondary Pedestrian Circulation
 - Parking Lot Permit Zones
 - Information Kiosk
 - Existing Postings
 - Electronic Message Boards**
W10 Site ID, Freeway
W11 Campus ID
 - Campus Entry Monument**
W15 Primary ID
W16 Secondary ID
 - Pedestrian Information**
W36 Accessible Pathway
 - Pedestrian Information**
W40 Freestanding Directory, primary
W41 Wall Mounted Directory
W42 Freestanding Directory, secondary
W46 Info Kiosk, Posted Messages
W48 Interactive Kiosk
 - Building Identity**
W50 Primary, vehicular
W51 Freestanding, Ped
 - Parking Lot Id/Info**
W70 Primary ID
W71 Secondary ID
W72 Pole Mounted ID
 - W97 Street Signs

Note:
Lozenge orientation does not necessarily represent accurate sign placement.

J
M



- Legend**
- Off campus vehicular circulation
 - On campus primary veh. circulation
 - On campus secondary veh. circulation
 - Primary Pedestrian Circulation
 - Secondary Pedestrian Circulation
 - Parking Lot Permit Zones
 - Information Kiosk
 - Existing Postings
 - Electronic Message Boards**
W10 Site ID, Freeway
W11 Campus ID
 - Campus Entry Monument**
W15 Primary ID
W16 Secondary ID
 - Pedestrian Information**
W36 Accessible Pathway
 - Pedestrian Information**
W40 Freestanding Directory, primary
W41 Wall Mounted Directory
W42 Freestanding Directory, secondary
W46 Info Kiosk, Posted Messages
W48 Interactive Kiosk
 - Building Identity**
W50 Primary, vehicular
W51 Freestanding, Ped
 - Parking Lot Id/Info**
W70 Primary ID
W71 Secondary ID
W72 Pole Mounted ID
 - W97 Street Signs

Note:
Lozenge orientation does not necessarily represent accurate sign placement.

S 0


▲ K



T ▼

- Legend**
- Off campus vehicular circulation
 - On campus primary veh. circulation
 - On campus secondary veh. circulation
 - Primary Pedestrian Circulation
 - Secondary Pedestrian Circulation
 - Parking Lot Permit Zones
 - Information Kiosk
 - Existing Postings
 - Electronic Message Boards**
W10 Site ID, Freeway
W11 Campus ID
 - Campus Entry Monument**
W15 Primary ID
W16 Secondary ID
 - Pedestrian Information**
W36 Accessible Pathway
 - Pedestrian Information**
W40 Freestanding Directory, primary
W41 Wall Mounted Directory
W42 Freestanding Directory, secondary
W46 Info Kiosk, Posted Messages
W48 Interactive Kiosk
 - Building Identity**
W50 Primary, vehicular
W51 Freestanding, Ped
 - Parking Lot Id/Info**
W70 Primary ID
W71 Secondary ID
W72 Pole Mounted ID
 - W97 Street Signs


Note:
Lozenge orientation does not necessarily represent accurate sign placement.

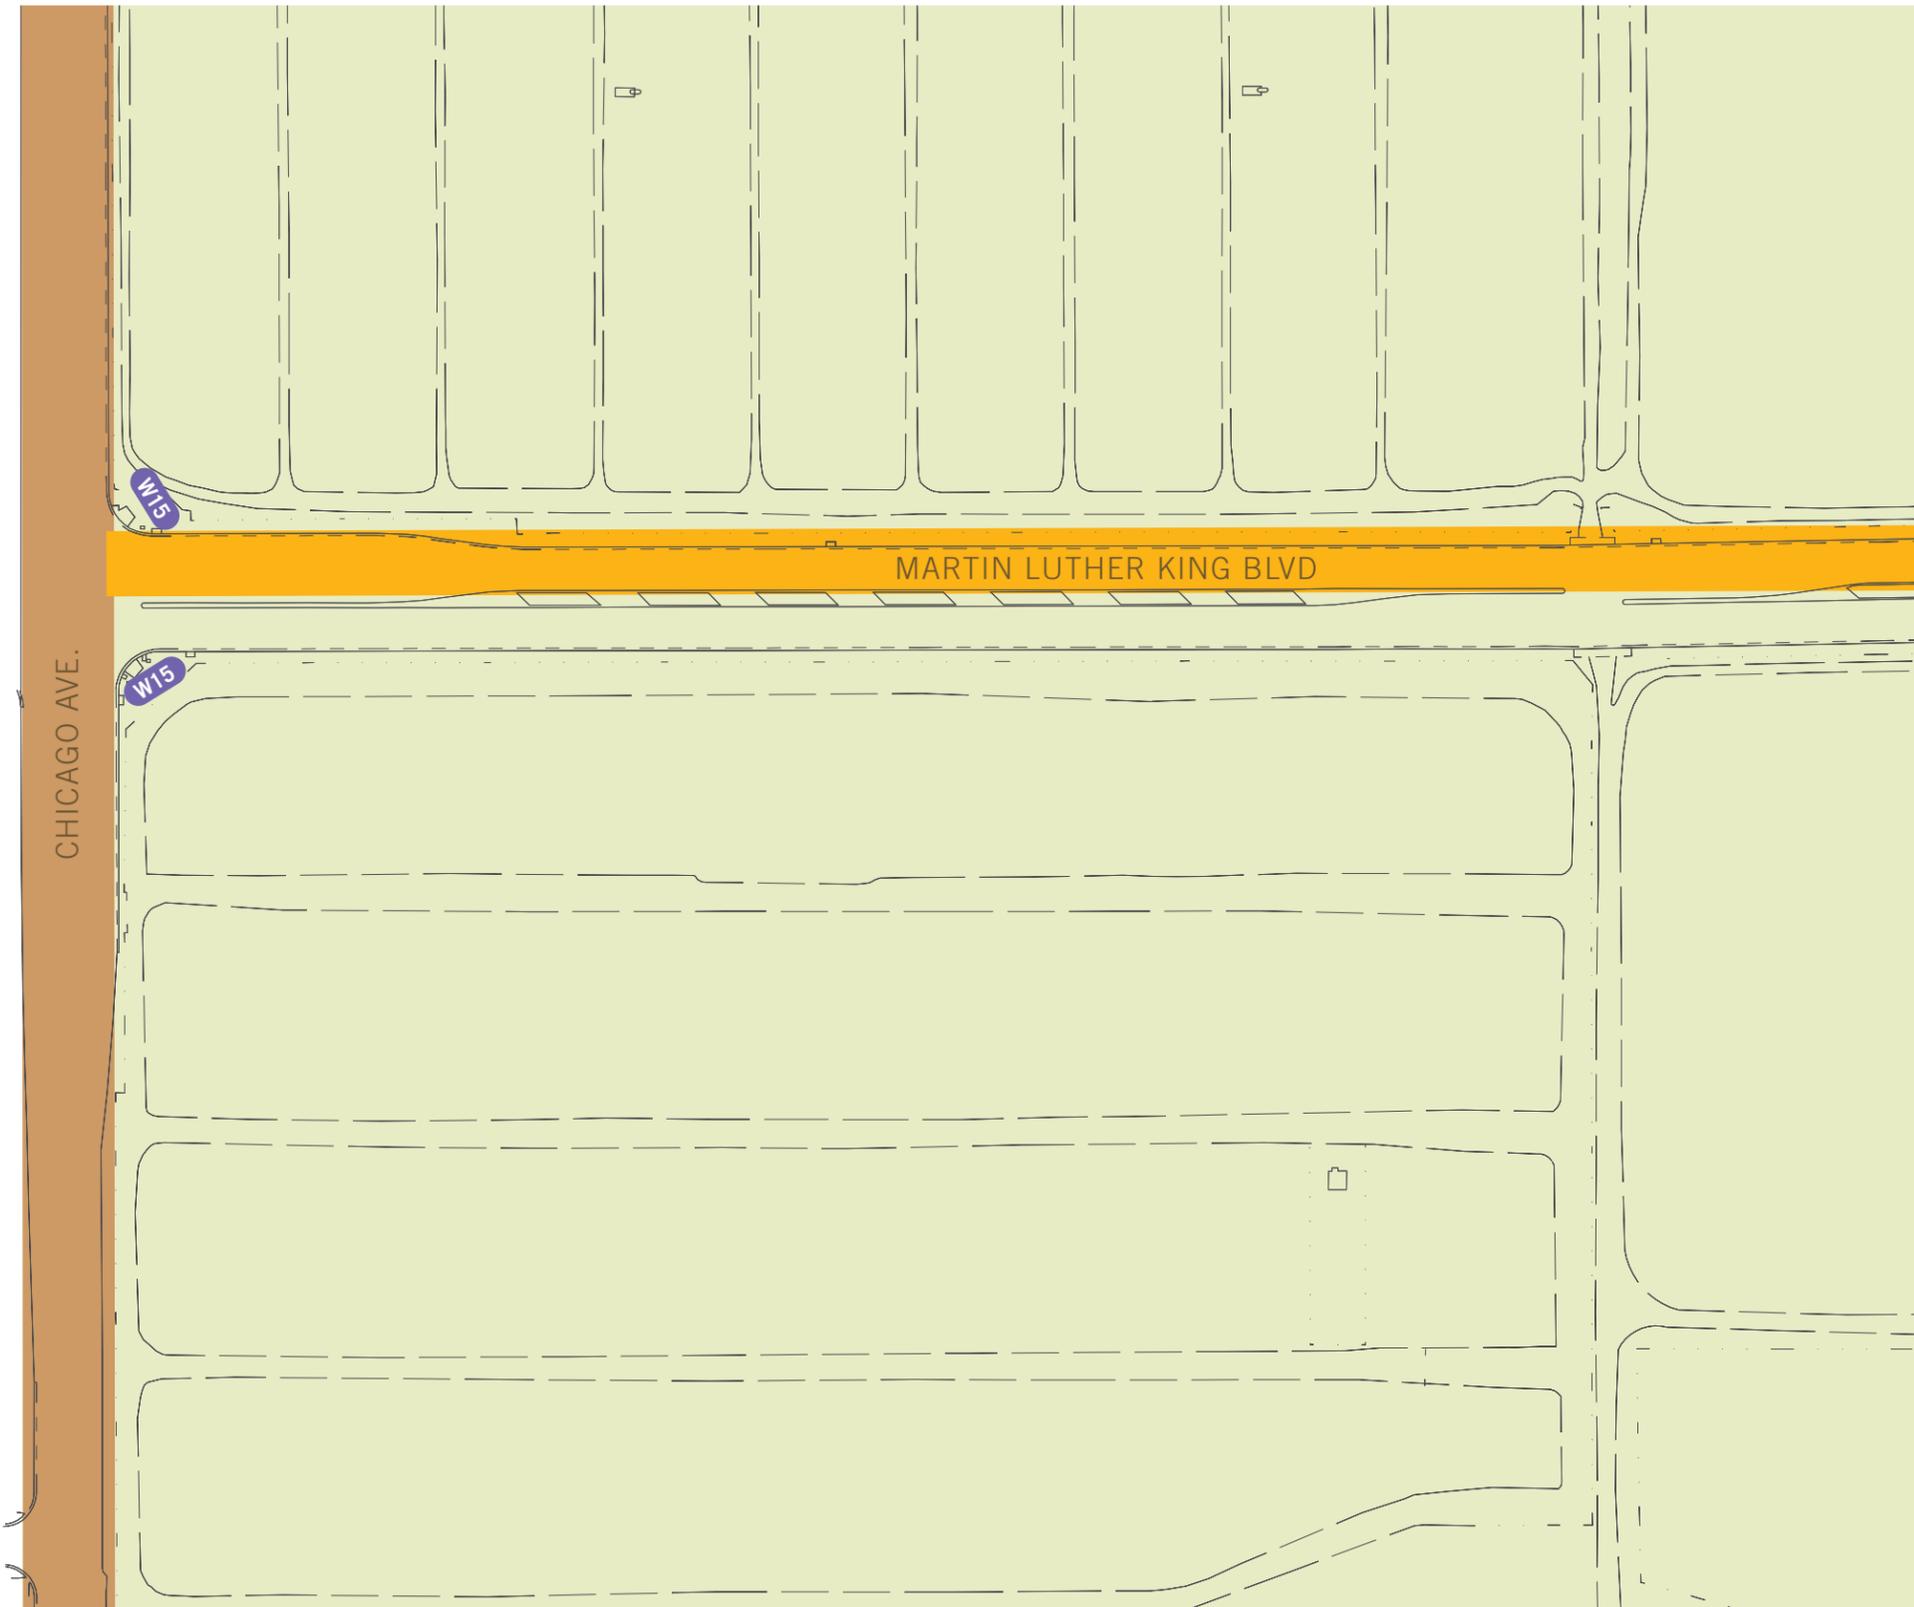

- Legend**
- Off campus vehicular circulation
 - On campus primary veh. circulation
 - On campus secondary veh. circulation
 - Primary Pedestrian Circulation
 - Secondary Pedestrian Circulation
 - Parking Lot Permit Zones
 - Information Kiosk
 - Existing Postings
 - Electronic Message Boards**
W10 Site ID, Freeway
W11 Campus ID
 - Campus Entry Monument**
W15 Primary ID
W16 Secondary ID
 - Pedestrian Information**
W36 Accessible Pathway
 - Pedestrian Information**
W40 Freestanding Directory, primary
W41 Wall Mounted Directory
W42 Freestanding Directory, secondary
W46 Info Kiosk, Posted Messages
W48 Interactive Kiosk
 - Building Identity**
W50 Primary, vehicular
W51 Freestanding, Ped
 - Parking Lot Id/Info**
W70 Primary ID
W71 Secondary ID
W72 Pole Mounted ID
 - W97 Street Signs

Note:
Lozenge orientation does not necessarily represent accurate sign placement.


Q ▲ M

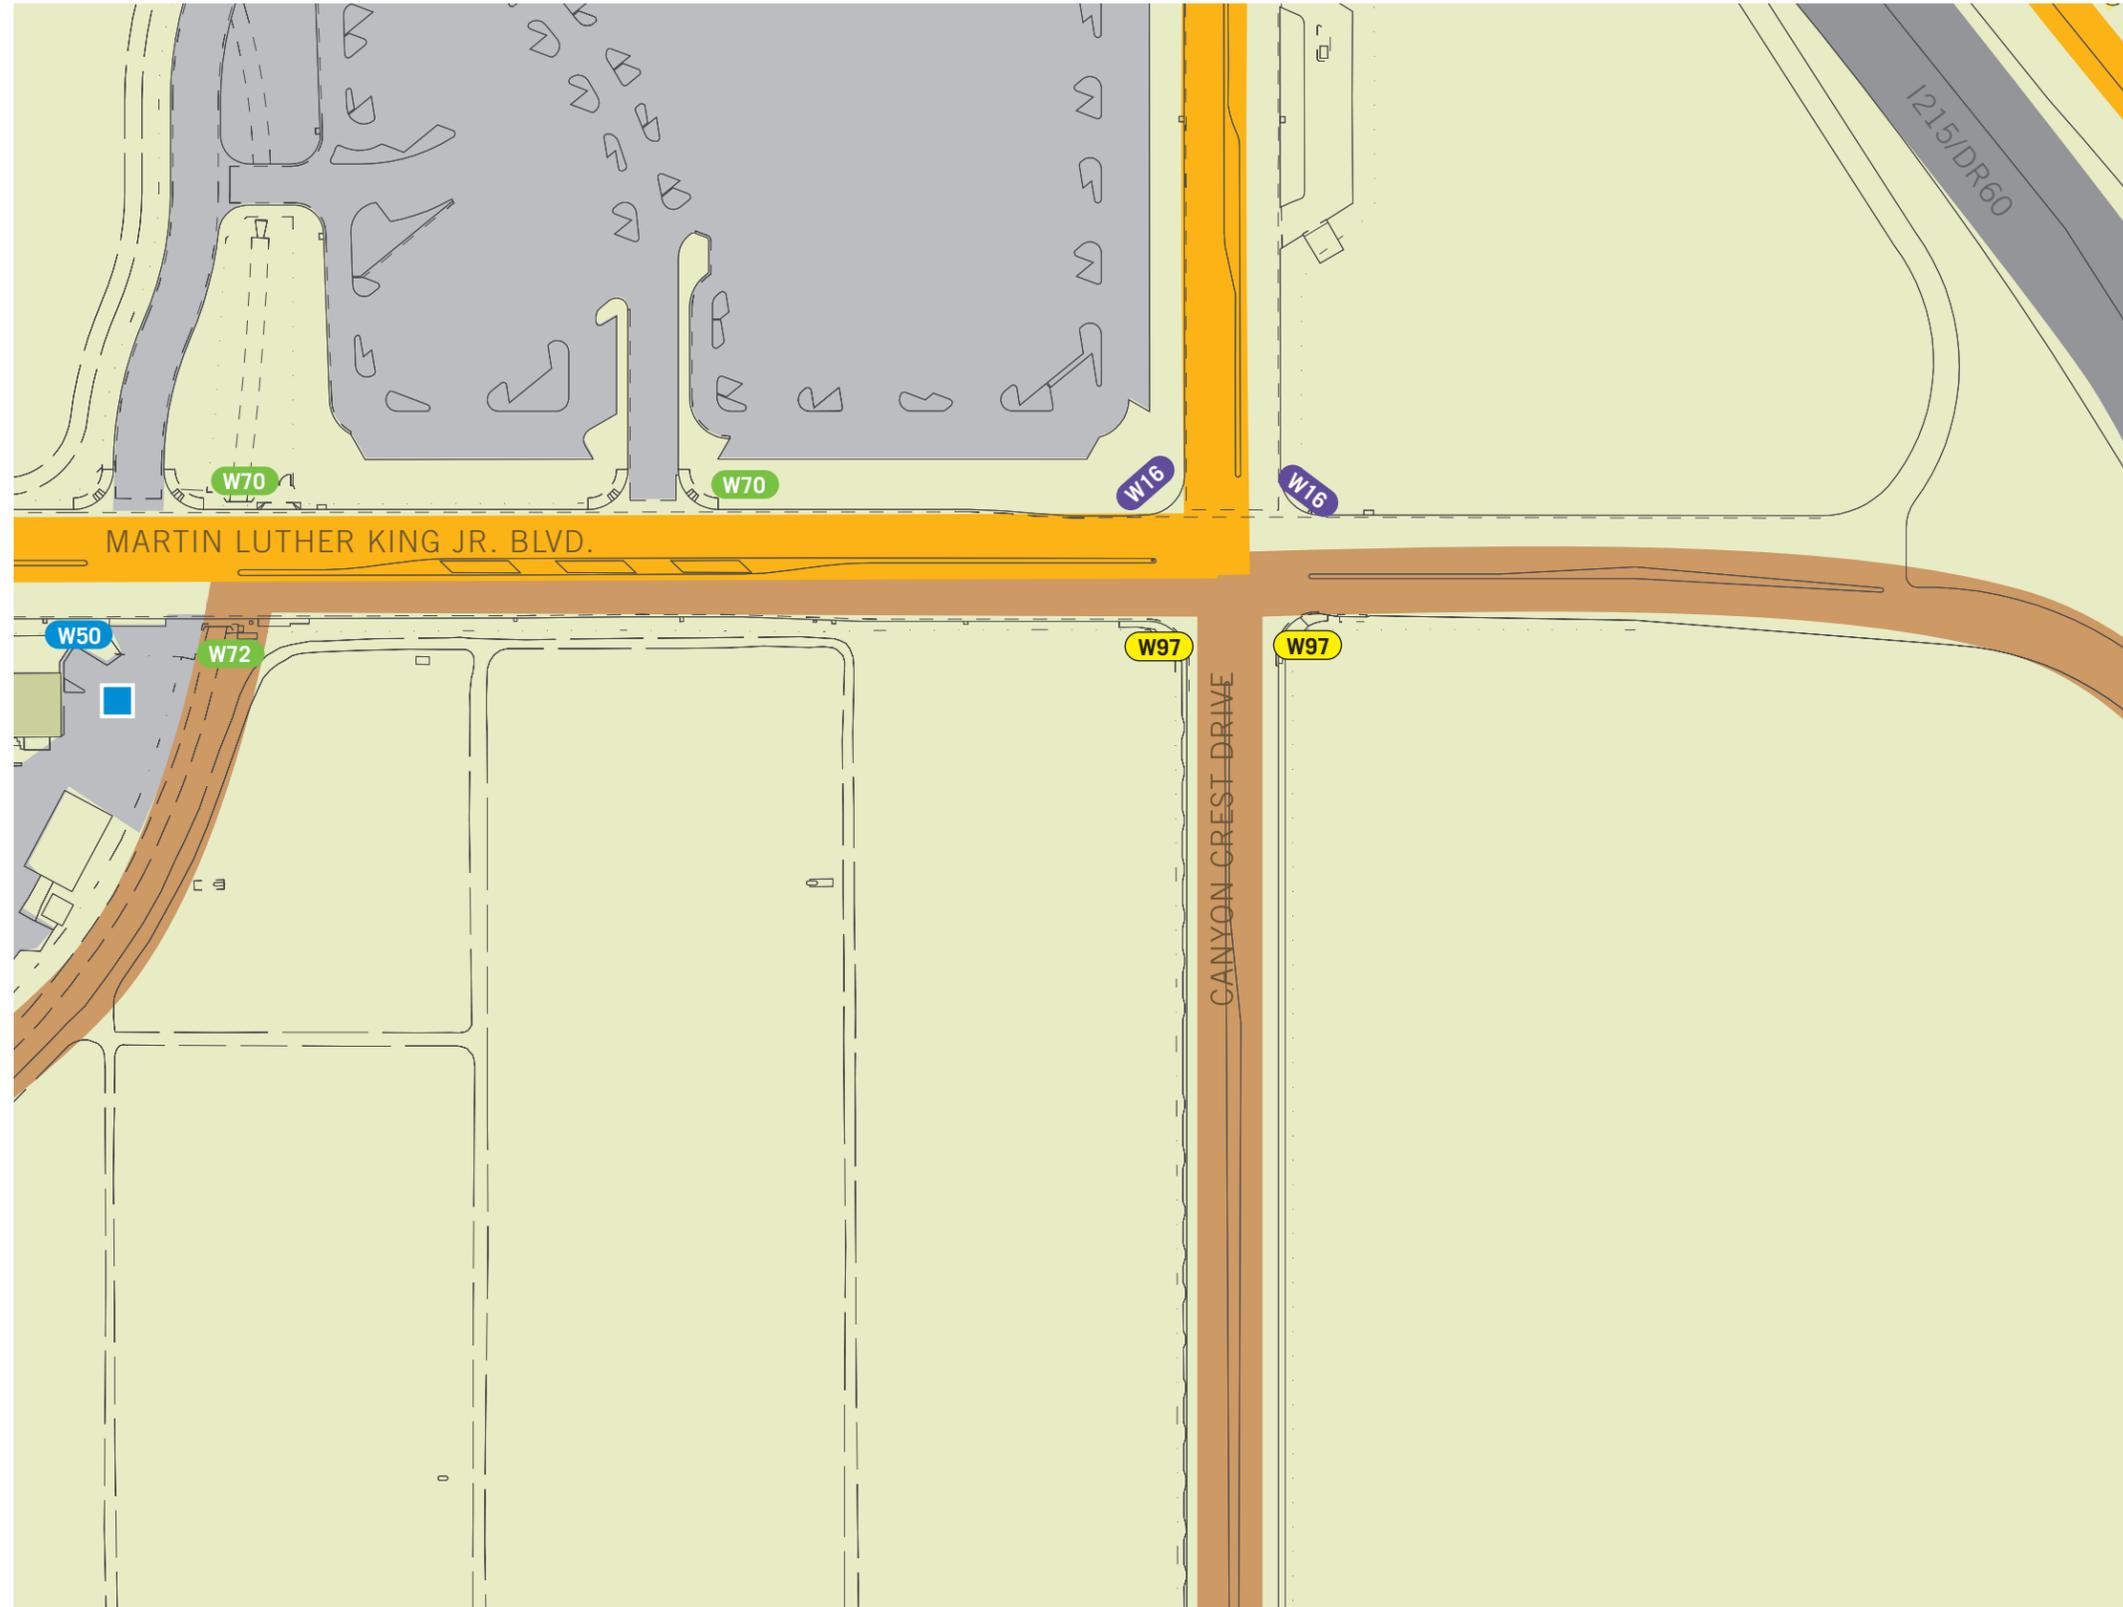

- Legend**
- Off campus vehicular circulation
 - On campus primary veh. circulation
 - On campus secondary veh. circulation
 - Primary Pedestrian Circulation
 - Secondary Pedestrian Circulation
 - Parking Lot Permit Zones
 - Information Kiosk
 - Existing Postings
 - Electronic Message Boards**
W10 Site ID, Freeway
W11 Campus ID
 - Campus Entry Monument**
W15 Primary ID
W16 Secondary ID
 - Pedestrian Information**
W36 Accessible Pathway
 - Pedestrian Information**
W40 Freestanding Directory, primary
W41 Wall Mounted Directory
W42 Freestanding Directory, secondary
W46 Info Kiosk, Posted Messages
W48 Interactive Kiosk
 - Building Identity**
W50 Primary, vehicular
W51 Freestanding, Ped
 - Parking Lot Id/Info**
W70 Primary ID
W71 Secondary ID
W72 Pole Mounted ID
 - W97 Street Signs

Note:
Lozenge orientation does not necessarily represent accurate sign placement.

▶ S

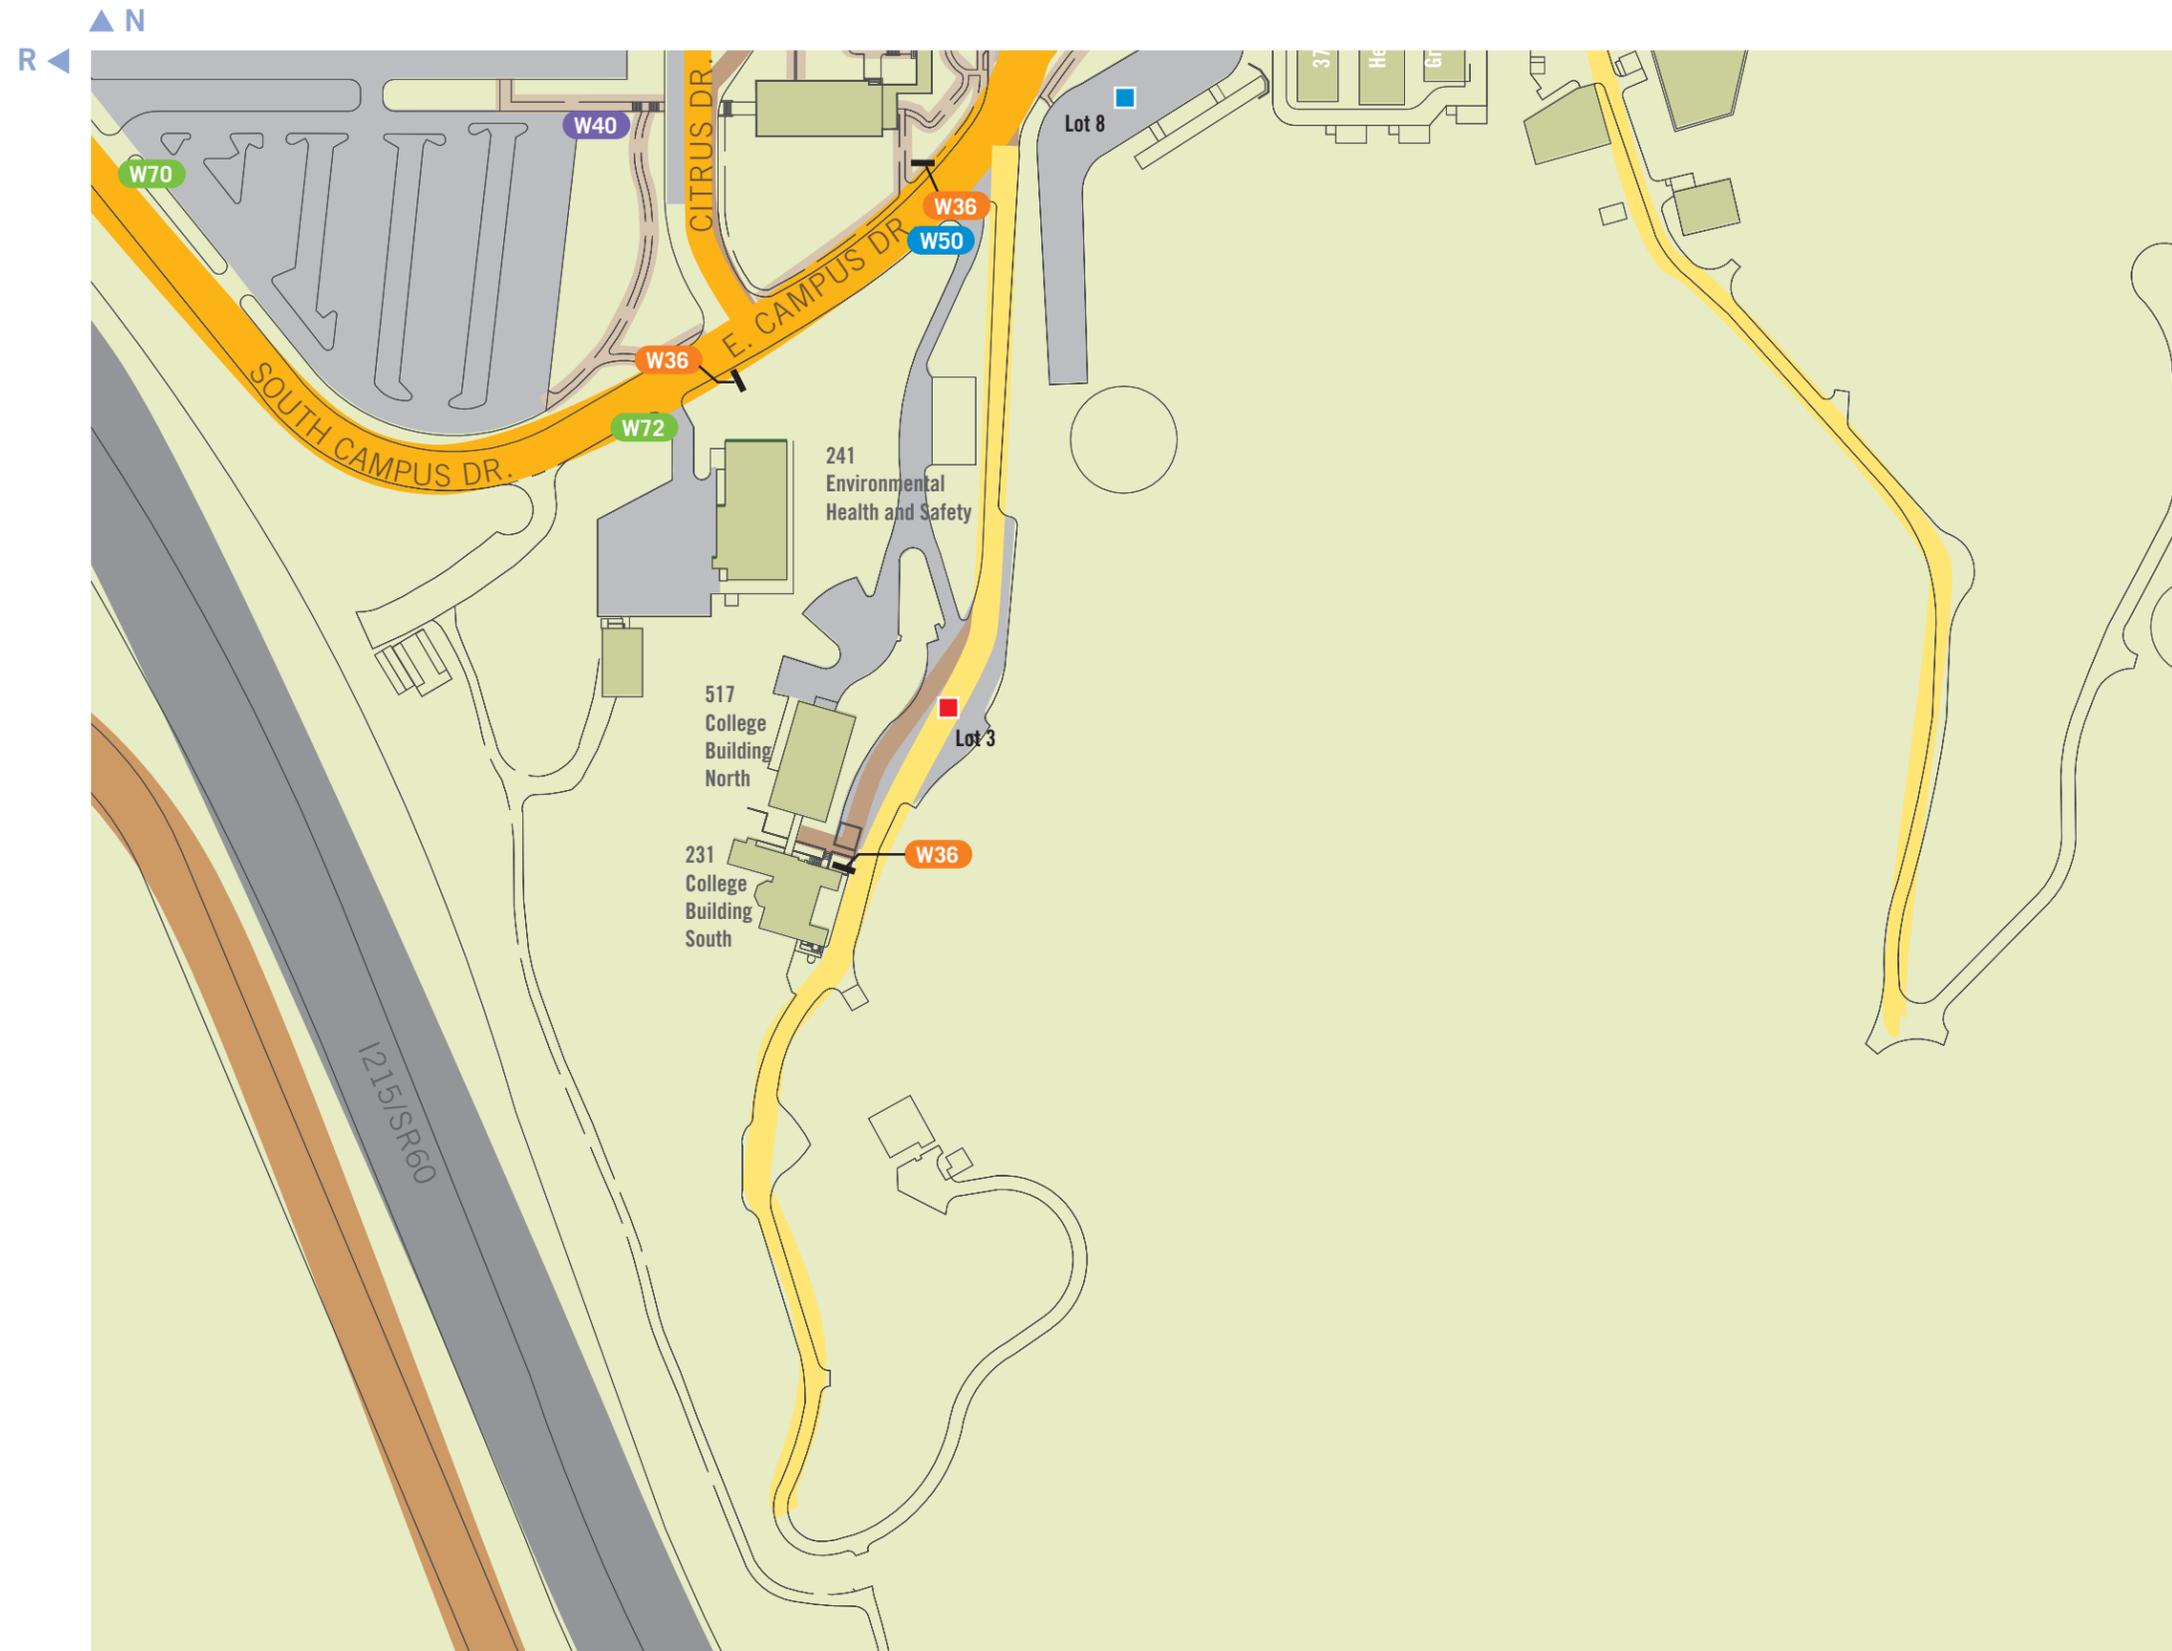

- Legend**
- Off campus vehicular circulation
 - On campus primary veh. circulation
 - On campus secondary veh. circulation
 - Primary Pedestrian Circulation
 - Secondary Pedestrian Circulation
 - Parking Lot Permit Zones
 - ★ Information Kiosk
 - ▲ Existing Postings
 - Electronic Message Boards**
W10 Site ID, Freeway
W11 Campus ID
 - Campus Entry Monument**
W15 Primary ID
W16 Secondary ID
 - Pedestrian Information**
W36 Accessible Pathway
 - Pedestrian Information**
W40 Freestanding Directory, primary
W41 Wall Mounted Directory
W42 Freestanding Directory, secondary
W46 Info Kiosk, Posted Messages
W48 Interactive Kiosk
 - Building Identity**
W50 Primary, vehicular
W51 Freestanding, Ped
 - Parking Lot Id/Info**
W70 Primary ID
W71 Secondary ID
W72 Pole Mounted ID
 - W97 Street Signs

Note:
Lozenge orientation does not necessarily represent accurate sign placement.

Location Plans and Messages

In order to provide clarity to the vehicular sign type locations, the following plans only show Vehicular Directional sign types.

Included are the following sign types:


W20

W21

W22



A ◀

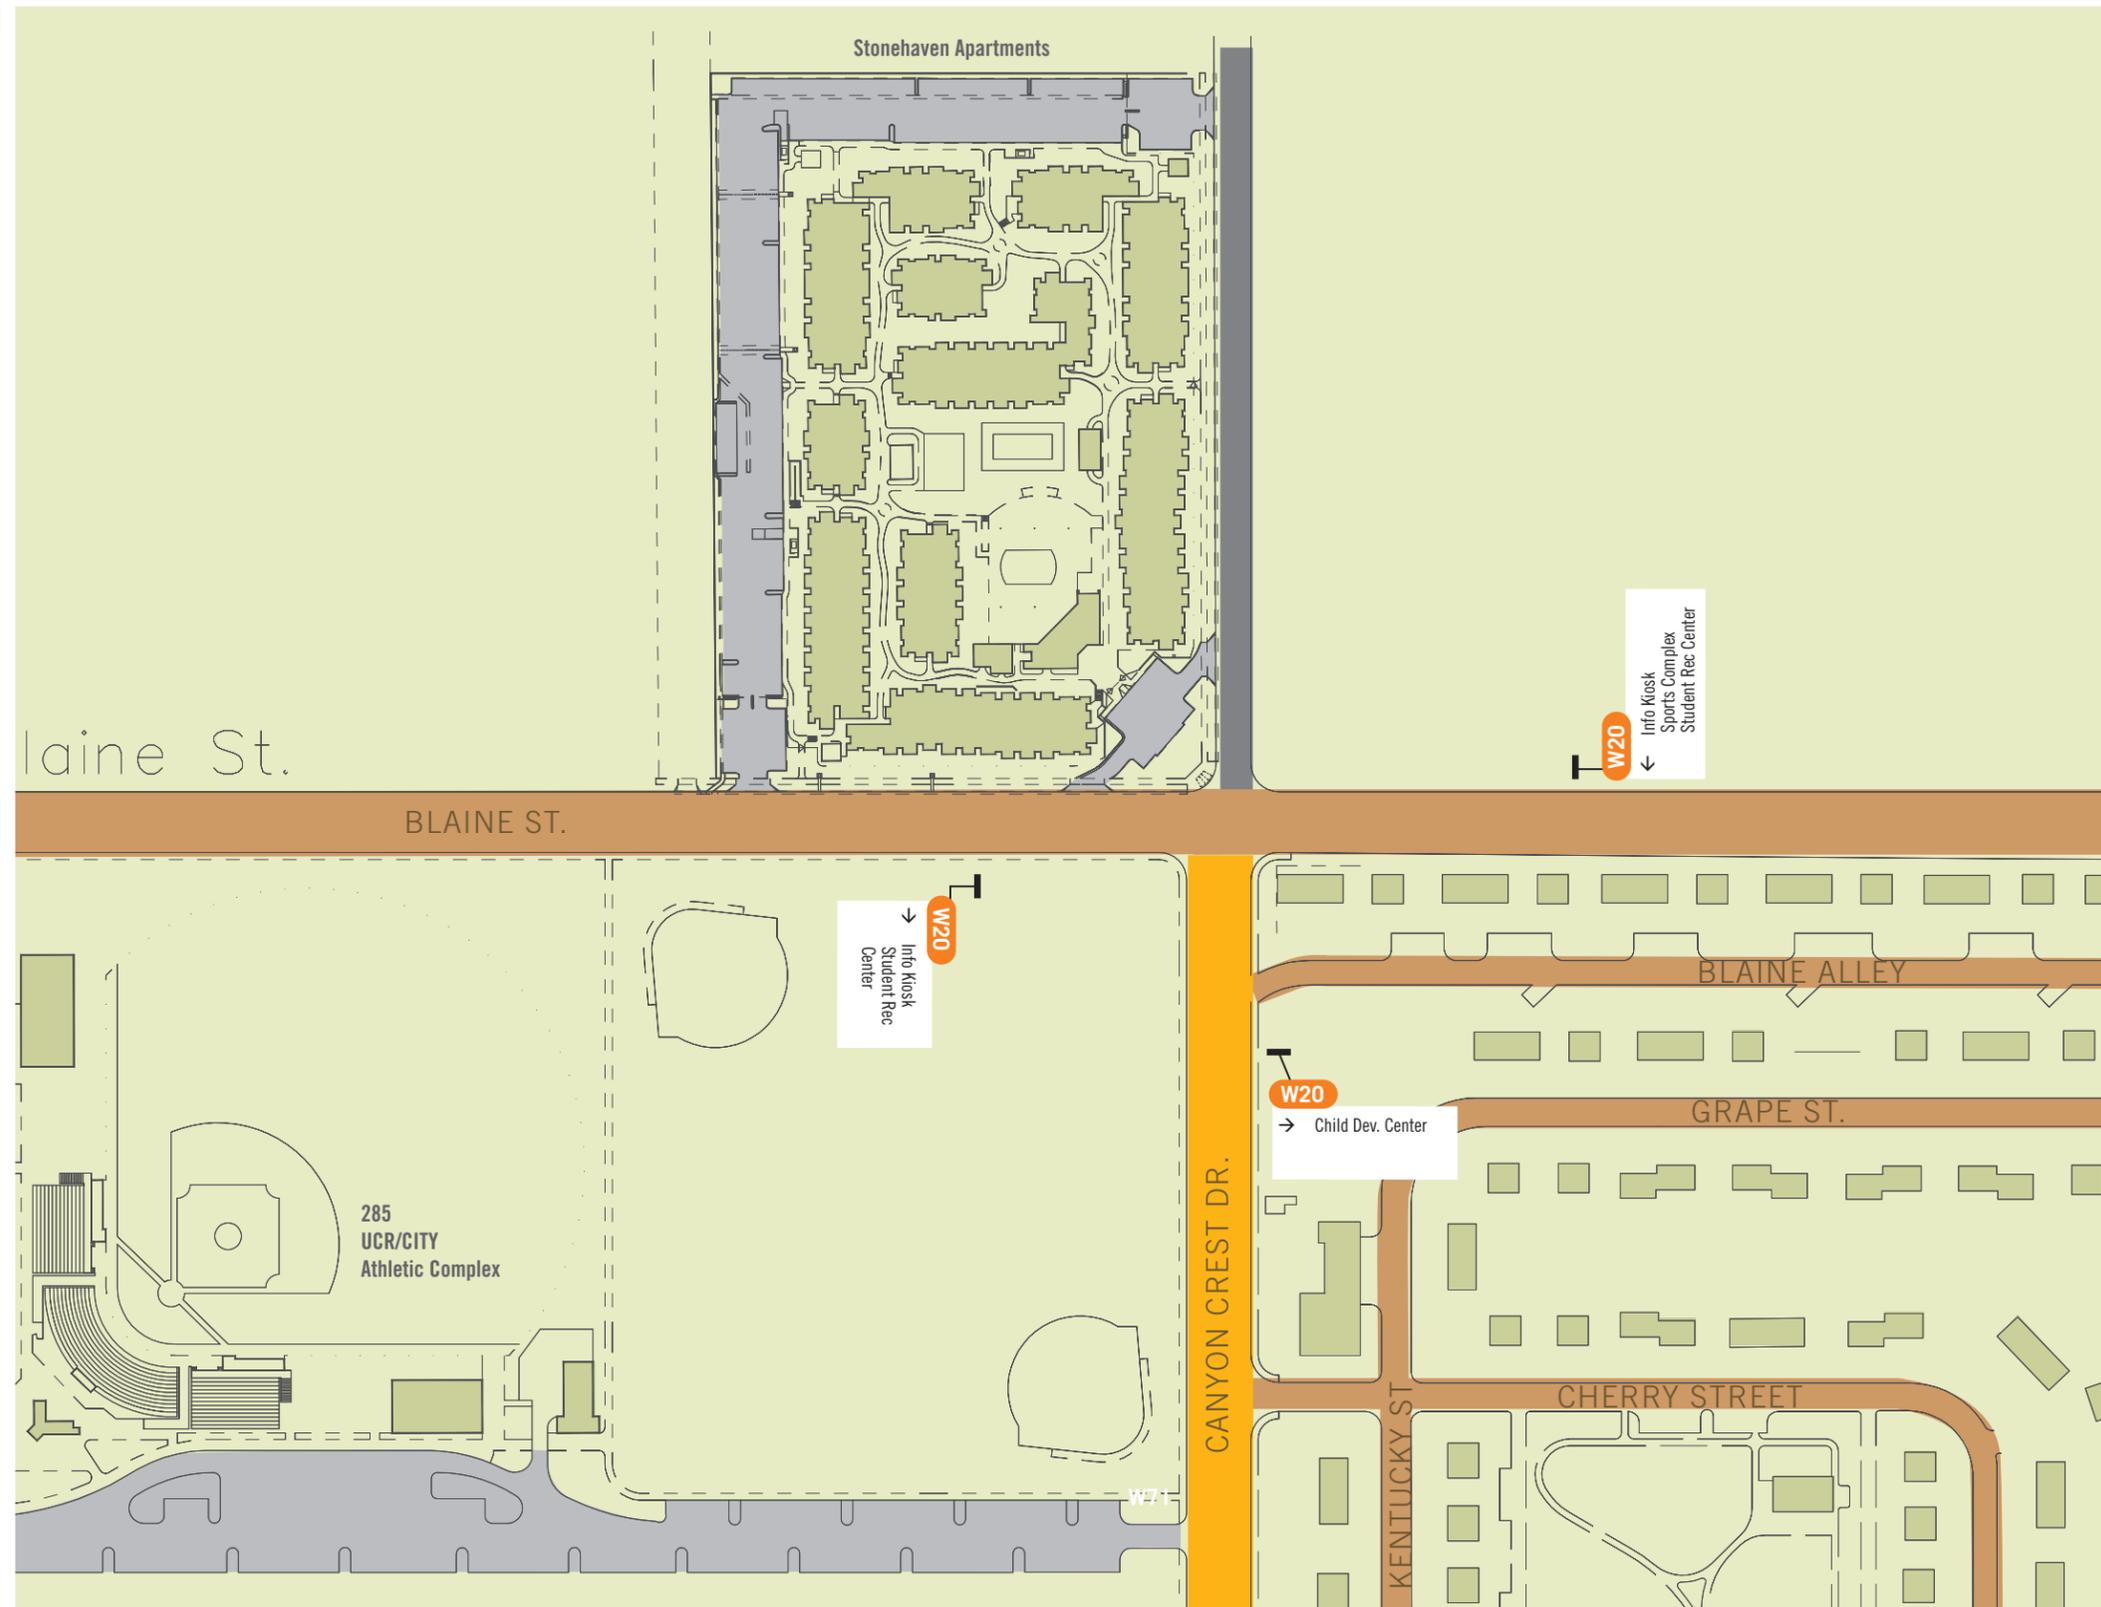

▶ C
E ▼

Vehicular Legend

- Off campus vehicular circulation
- On campus primary veh. circulation
- On campus secondary veh. circulation
- Parking Lot Permit Zones
- Information Kiosk
- Vehicular Directional**
- W20 Primary
- W21 Secondary
- W22 Pole Mounted

Note:
Lozenge orientation does not necessarily represent accurate sign placement.

Vehicular Destinations

Direct from Perimeter of Campus

- Info Kiosk
- Botanical Gardens
- University Theater

Direct from 2-3 decision points away

- Child Dev. Center
- Corporation Yard
- East Campus
- Lothian Hall
- Parking Lot 10
- Parking Lot 13
- Parking Lot 24
- Parking Lot 30
- Parking Services
- Res. Halls
- Sports Complex
- Student Rec Center
- Health Services
- West Campus

Direct from 1 decision point away

- Ag. Operations
- Bannockburn
- Biomedical Teaching C omplex
- Riviera Library Parking
- USDA Lab

B ◀

Vehicular Legend

- Off campus vehicular circulation
- On campus primary veh. circulation
- On campus secondary veh. circulation
- Parking Lot Permit Zones
- ★ Information Kiosk

- Vehicular Directional**
- W20 Primary
- W21 Secondary
- W22 Pole Mounted

Note:
Lozenge orientation does not necessarily represent accurate sign placement.

Vehicular Destinations

Direct from Perimeter of Campus
Info Kiosk
Botanical Gardens
University Theater

Direct from 2-3 decision points away
Child Dev. Center
Corporation Yard
East Campus
Lothian Hall
Parking Lot 10
Parking Lot 13
Parking Lot 24
Parking Lot 30
Parking Services
Res. Halls
Sports Complex
Student Rec Center
Health Services
West Campus

Direct from 1 decision point away
Ag. Operations
Bannockburn
Biomedical Teaching Complex
Riviera Library Parking
USDA Lab



F ▼

▲ B
D ◀



Vehicular Legend

- Off campus vehicular circulation
- On campus primary veh. circulation
- On campus secondary veh. circulation
- Parking Lot Permit Zones
- Information Kiosk
- Vehicular Directional
 - W20 Primary
 - W21 Secondary
 - W22 Pole Mounted

Note:
Lozenge orientation does not necessarily represent accurate sign placement.

Vehicular Destinations

Direct from Perimeter of Campus

- Info Kiosk
- Botanical Gardens
- University Theater


Direct from 2-3 decision points away

- Child Dev. Center
- Corporation Yard
- East Campus
- Lothian Hall
- Parking Lot 10
- Parking Lot 13
- Parking Lot 24
- Parking Lot 30
- Parking Services
- Res. Halls
- Sports Complex
- Student Rec Center
- Health Services
- West Campus

Direct from 1 decision point away

- Ag. Operations
- Bannockburn
- Biomedical Teaching C omplex
- Riviera Library Parking
- USDA Lab

▶ F
I ▼

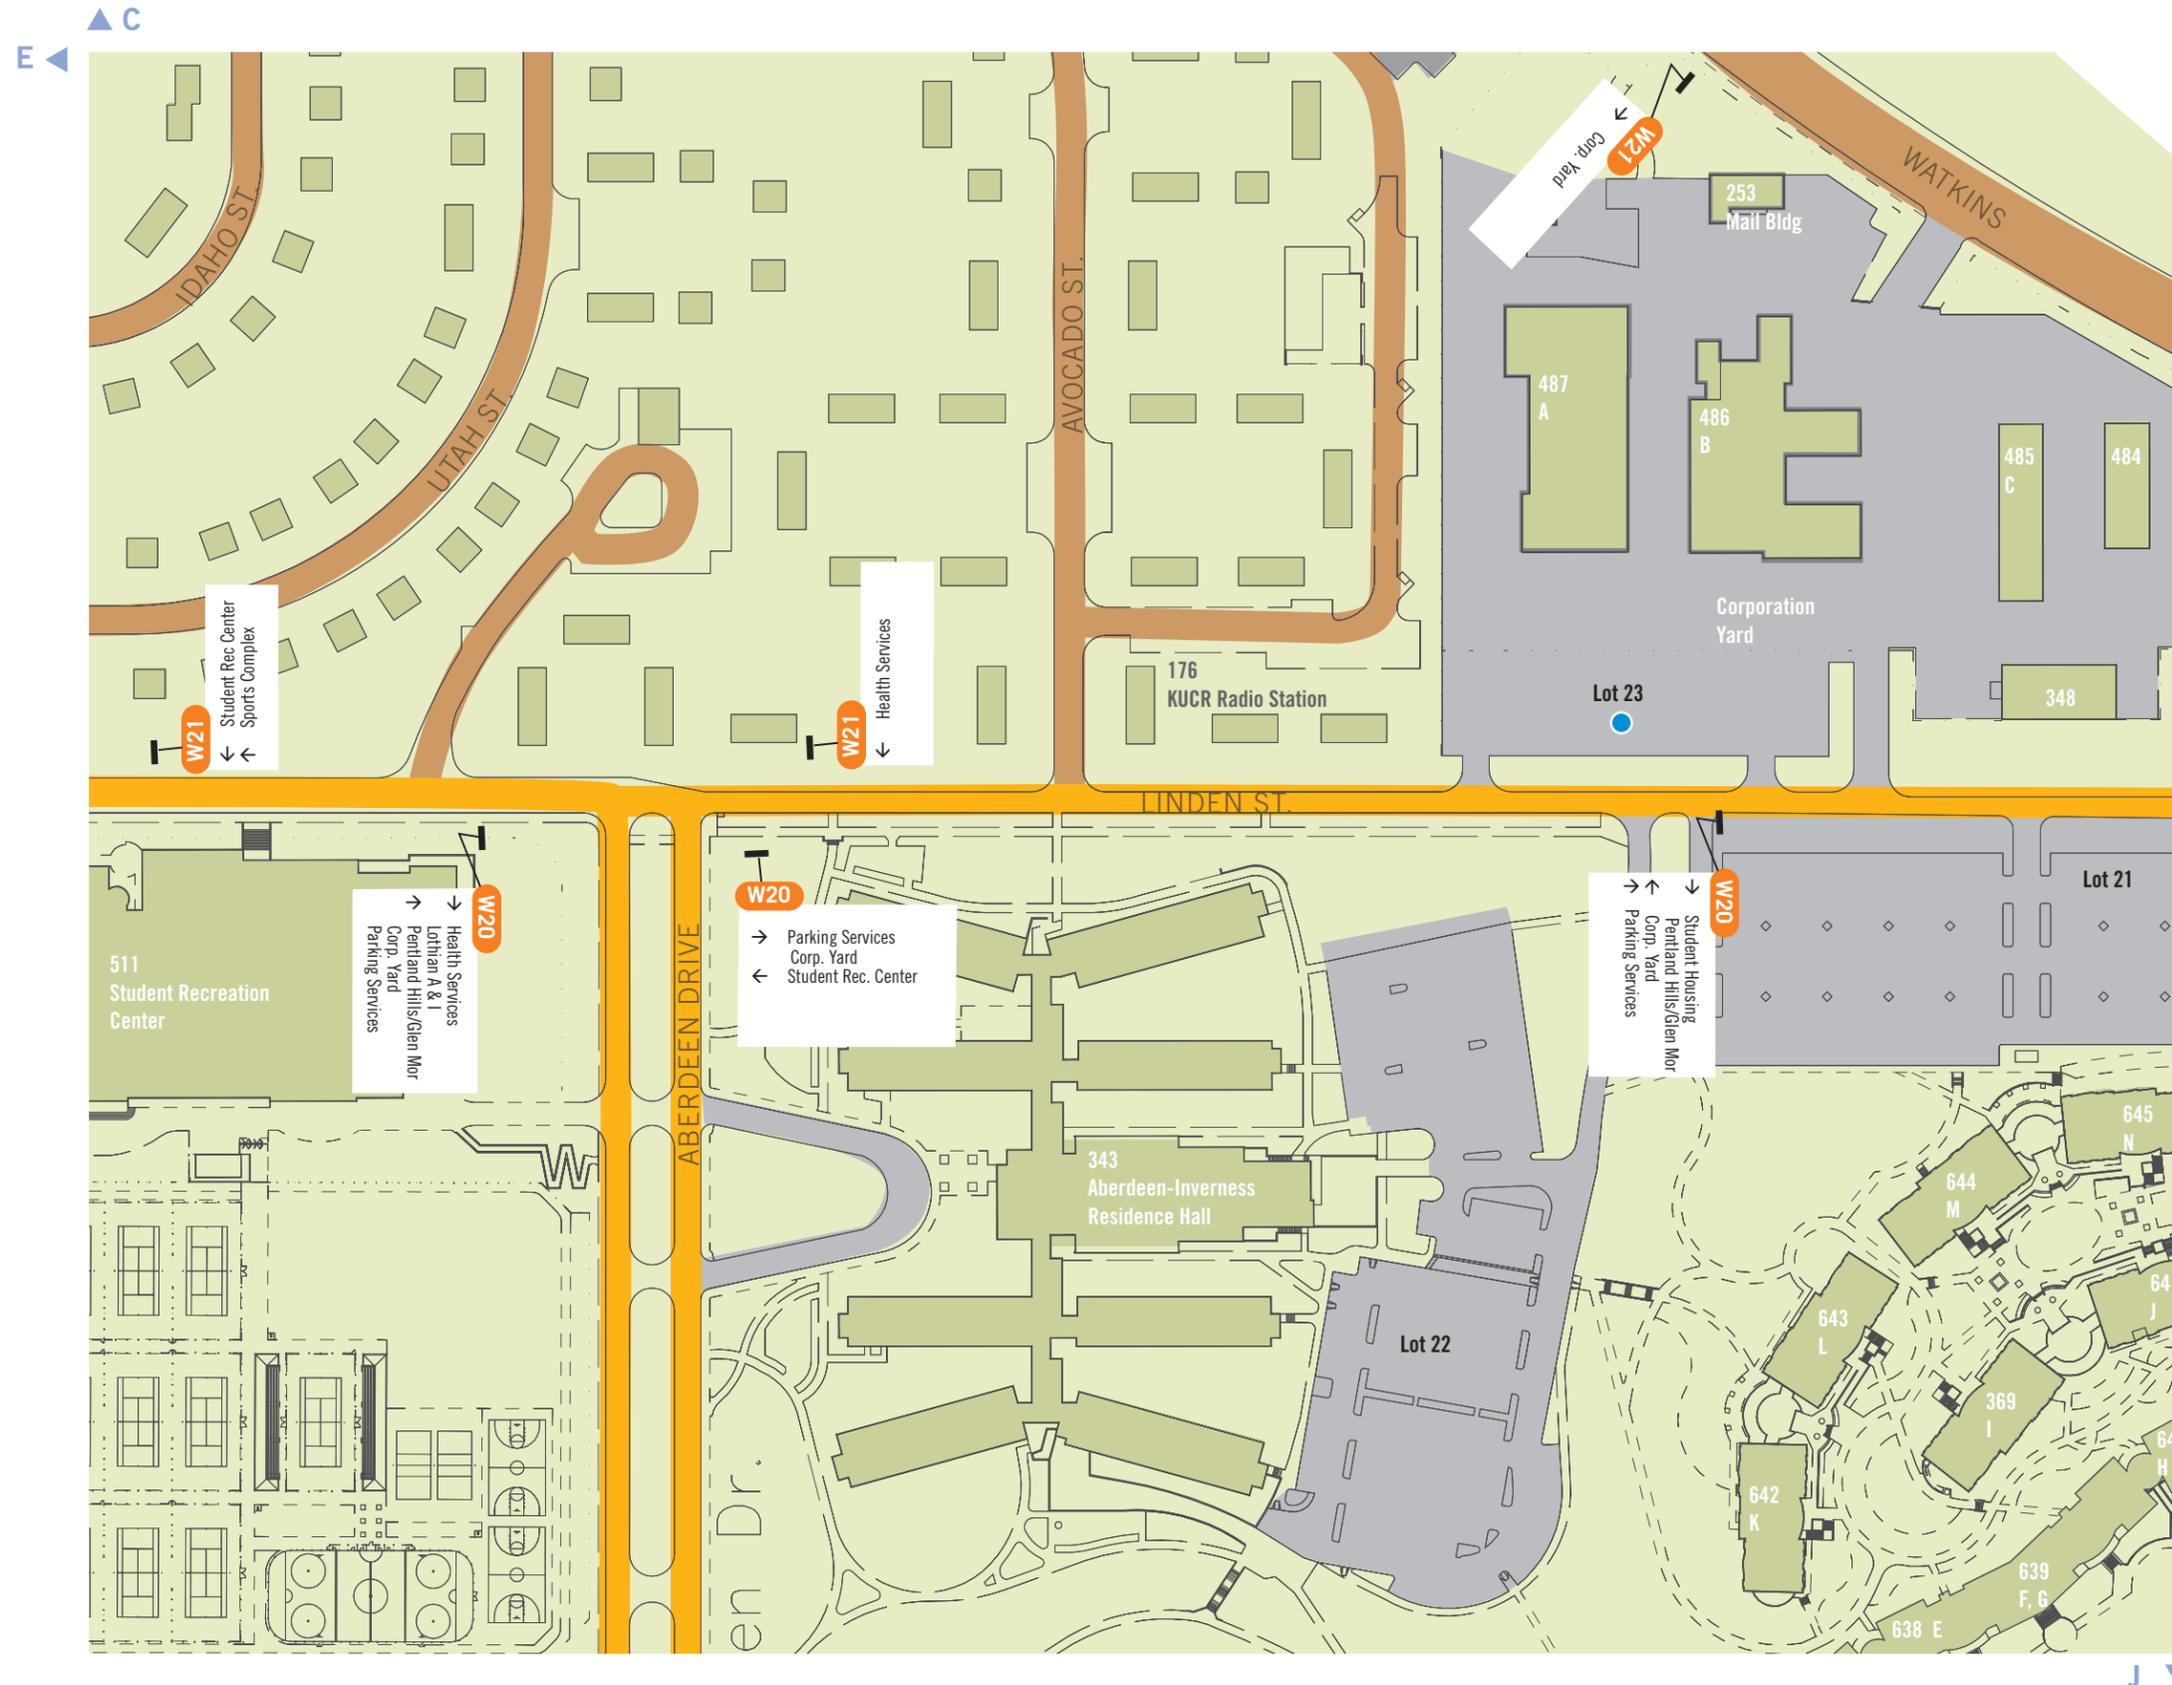

Vehicular Legend

- Off campus vehicular circulation
- On campus primary veh. circulation
- On campus secondary veh. circulation
- Parking Lot Permit Zones
- Information Kiosk
- Vehicular Directional**
- W20 Primary
- W21 Secondary
- W22 Pole Mounted

Note:
Lozenge orientation does not necessarily represent accurate sign placement.


Vehicular Destinations

Direct from Perimeter of Campus
Info Kiosk
Botanical Gardens
University Theater

Direct from 2-3 decision points away
Child Dev. Center
Corporation Yard
East Campus
Lothian Hall
Parking Lot 10
Parking Lot 13
Parking Lot 24
Parking Lot 30
Parking Services
Res. Halls
Sports Complex
Student Rec Center
Health Services
West Campus

Direct from 1 decision point away
Ag. Operations
Bannockburn
Biomedical Teaching C omplex
Riviera Library Parking
USDA Lab

F ◀

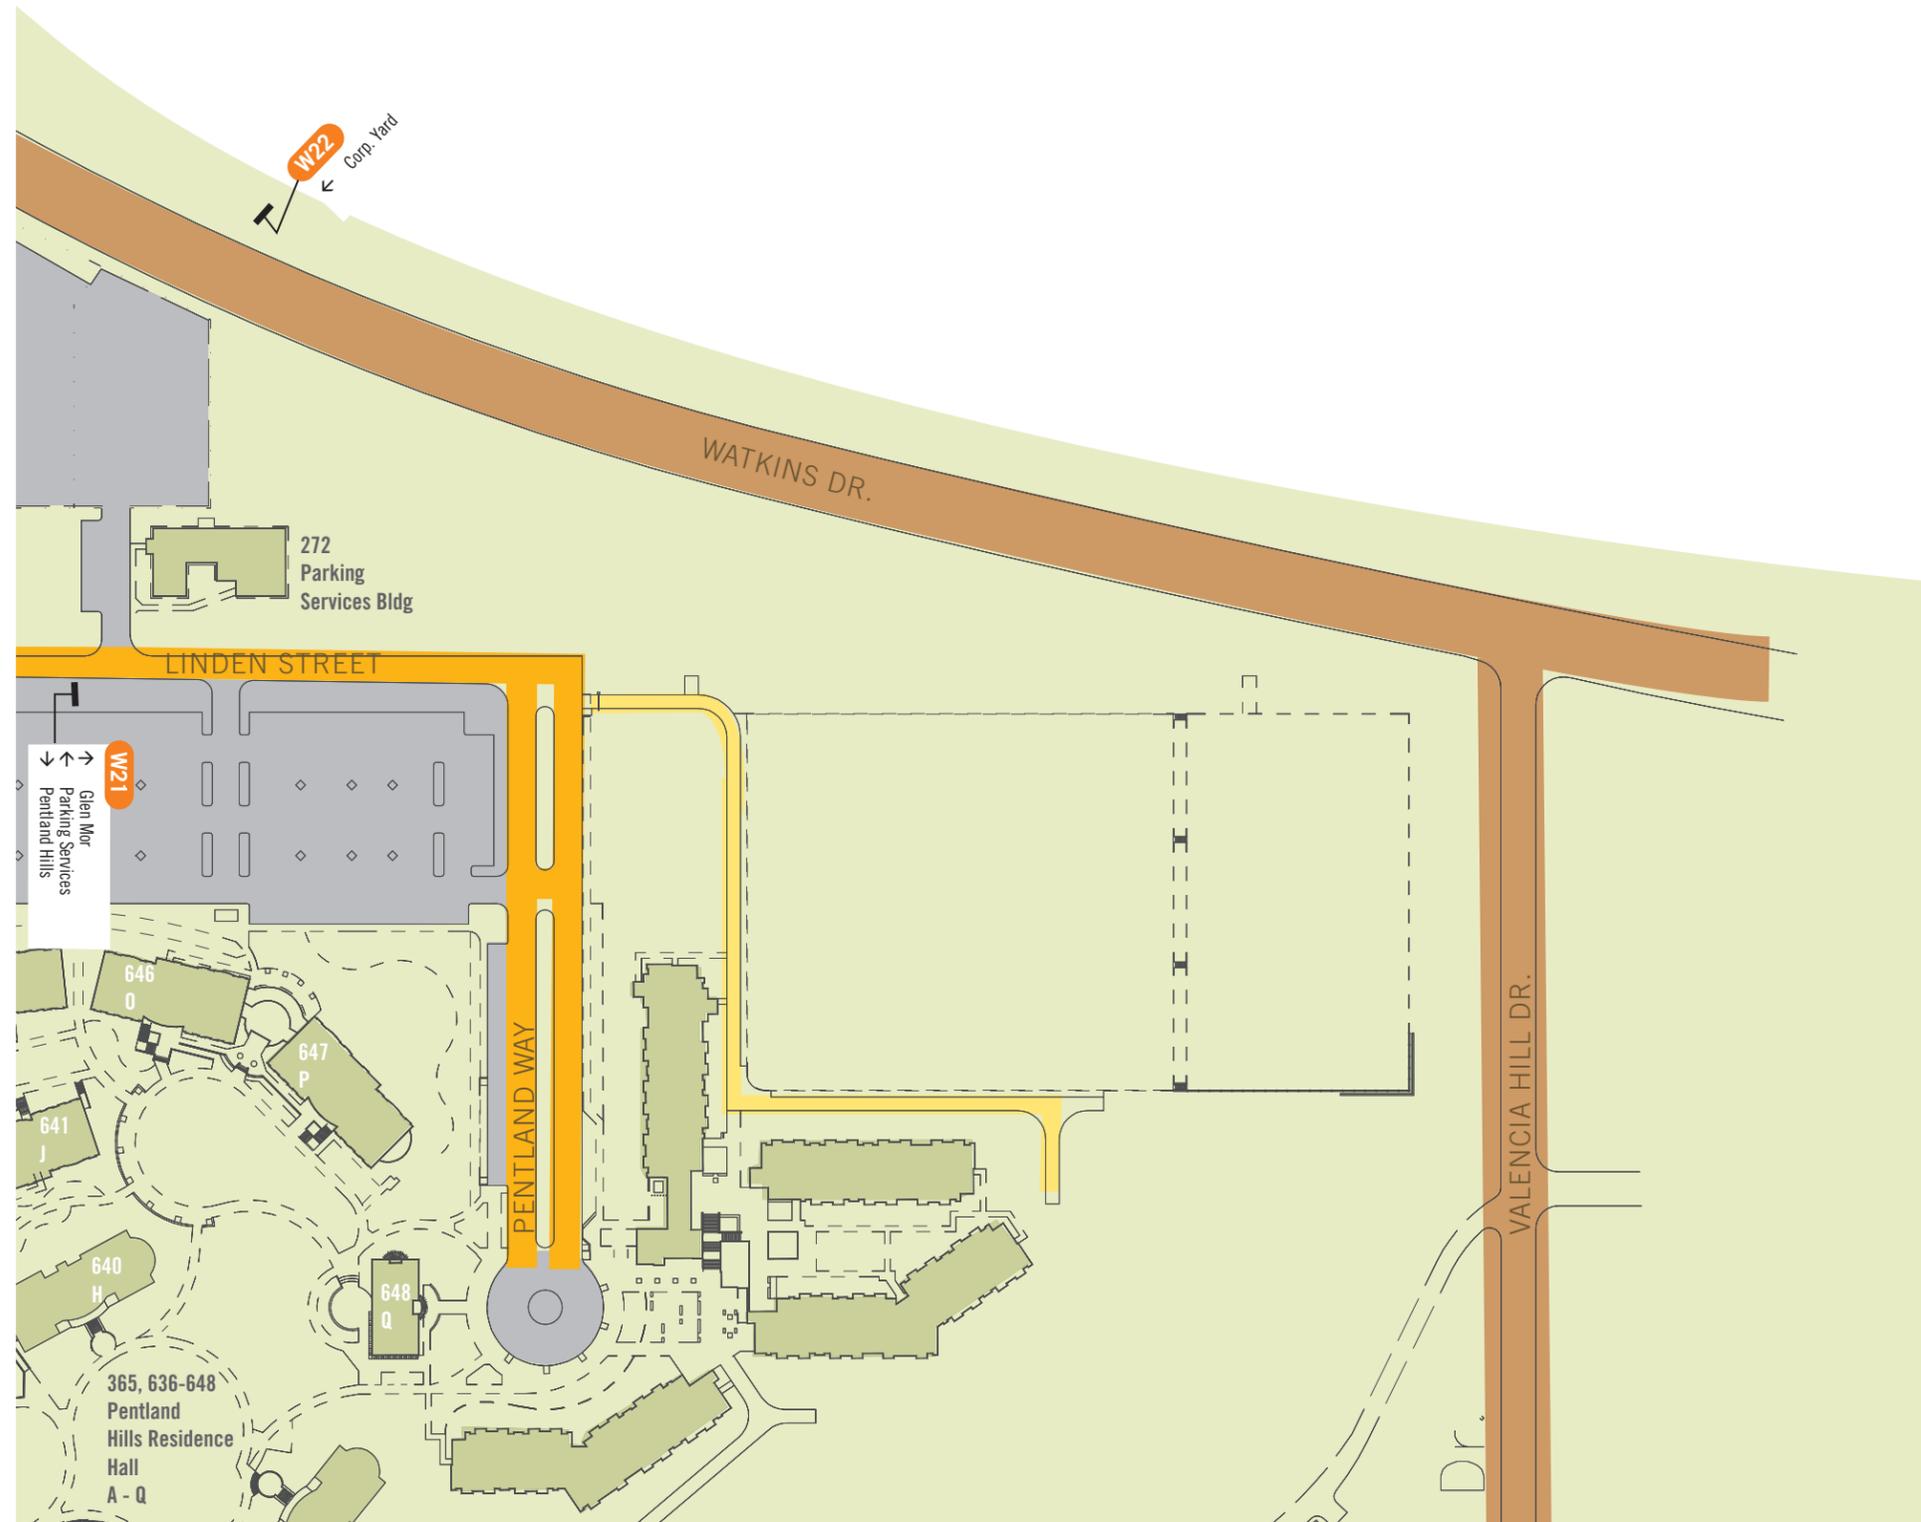

Vehicular Legend

- Off campus vehicular circulation
 - On campus primary veh. circulation
 - On campus secondary veh. circulation
 - Parking Lot Permit Zones
 - Information Kiosk
-
- Vehicular Directional**
 - W20 Primary
 - W21 Secondary
 - W22 Pole Mounted

Note:
Lozenge orientation does not necessarily represent accurate sign placement.

Vehicular Destinations

Direct from Perimeter of Campus

- Info Kiosk
- Botanical Gardens
- University Theater

Direct from 2-3 decision points away


- Child Dev. Center
- Corporation Yard
- East Campus
- Lothian Hall
- Parking Lot 10
- Parking Lot 13
- Parking Lot 24
- Parking Lot 30
- Parking Services
- Res. Halls
- Sports Complex
- Student Rec Center
- Health Services
- West Campus

Direct from 1 decision point away

- Ag. Operations
- Bannockburn
- Biomedical Teaching C omplex
- Riviera Library Parking
- USDA Lab

K ▼

▲ D

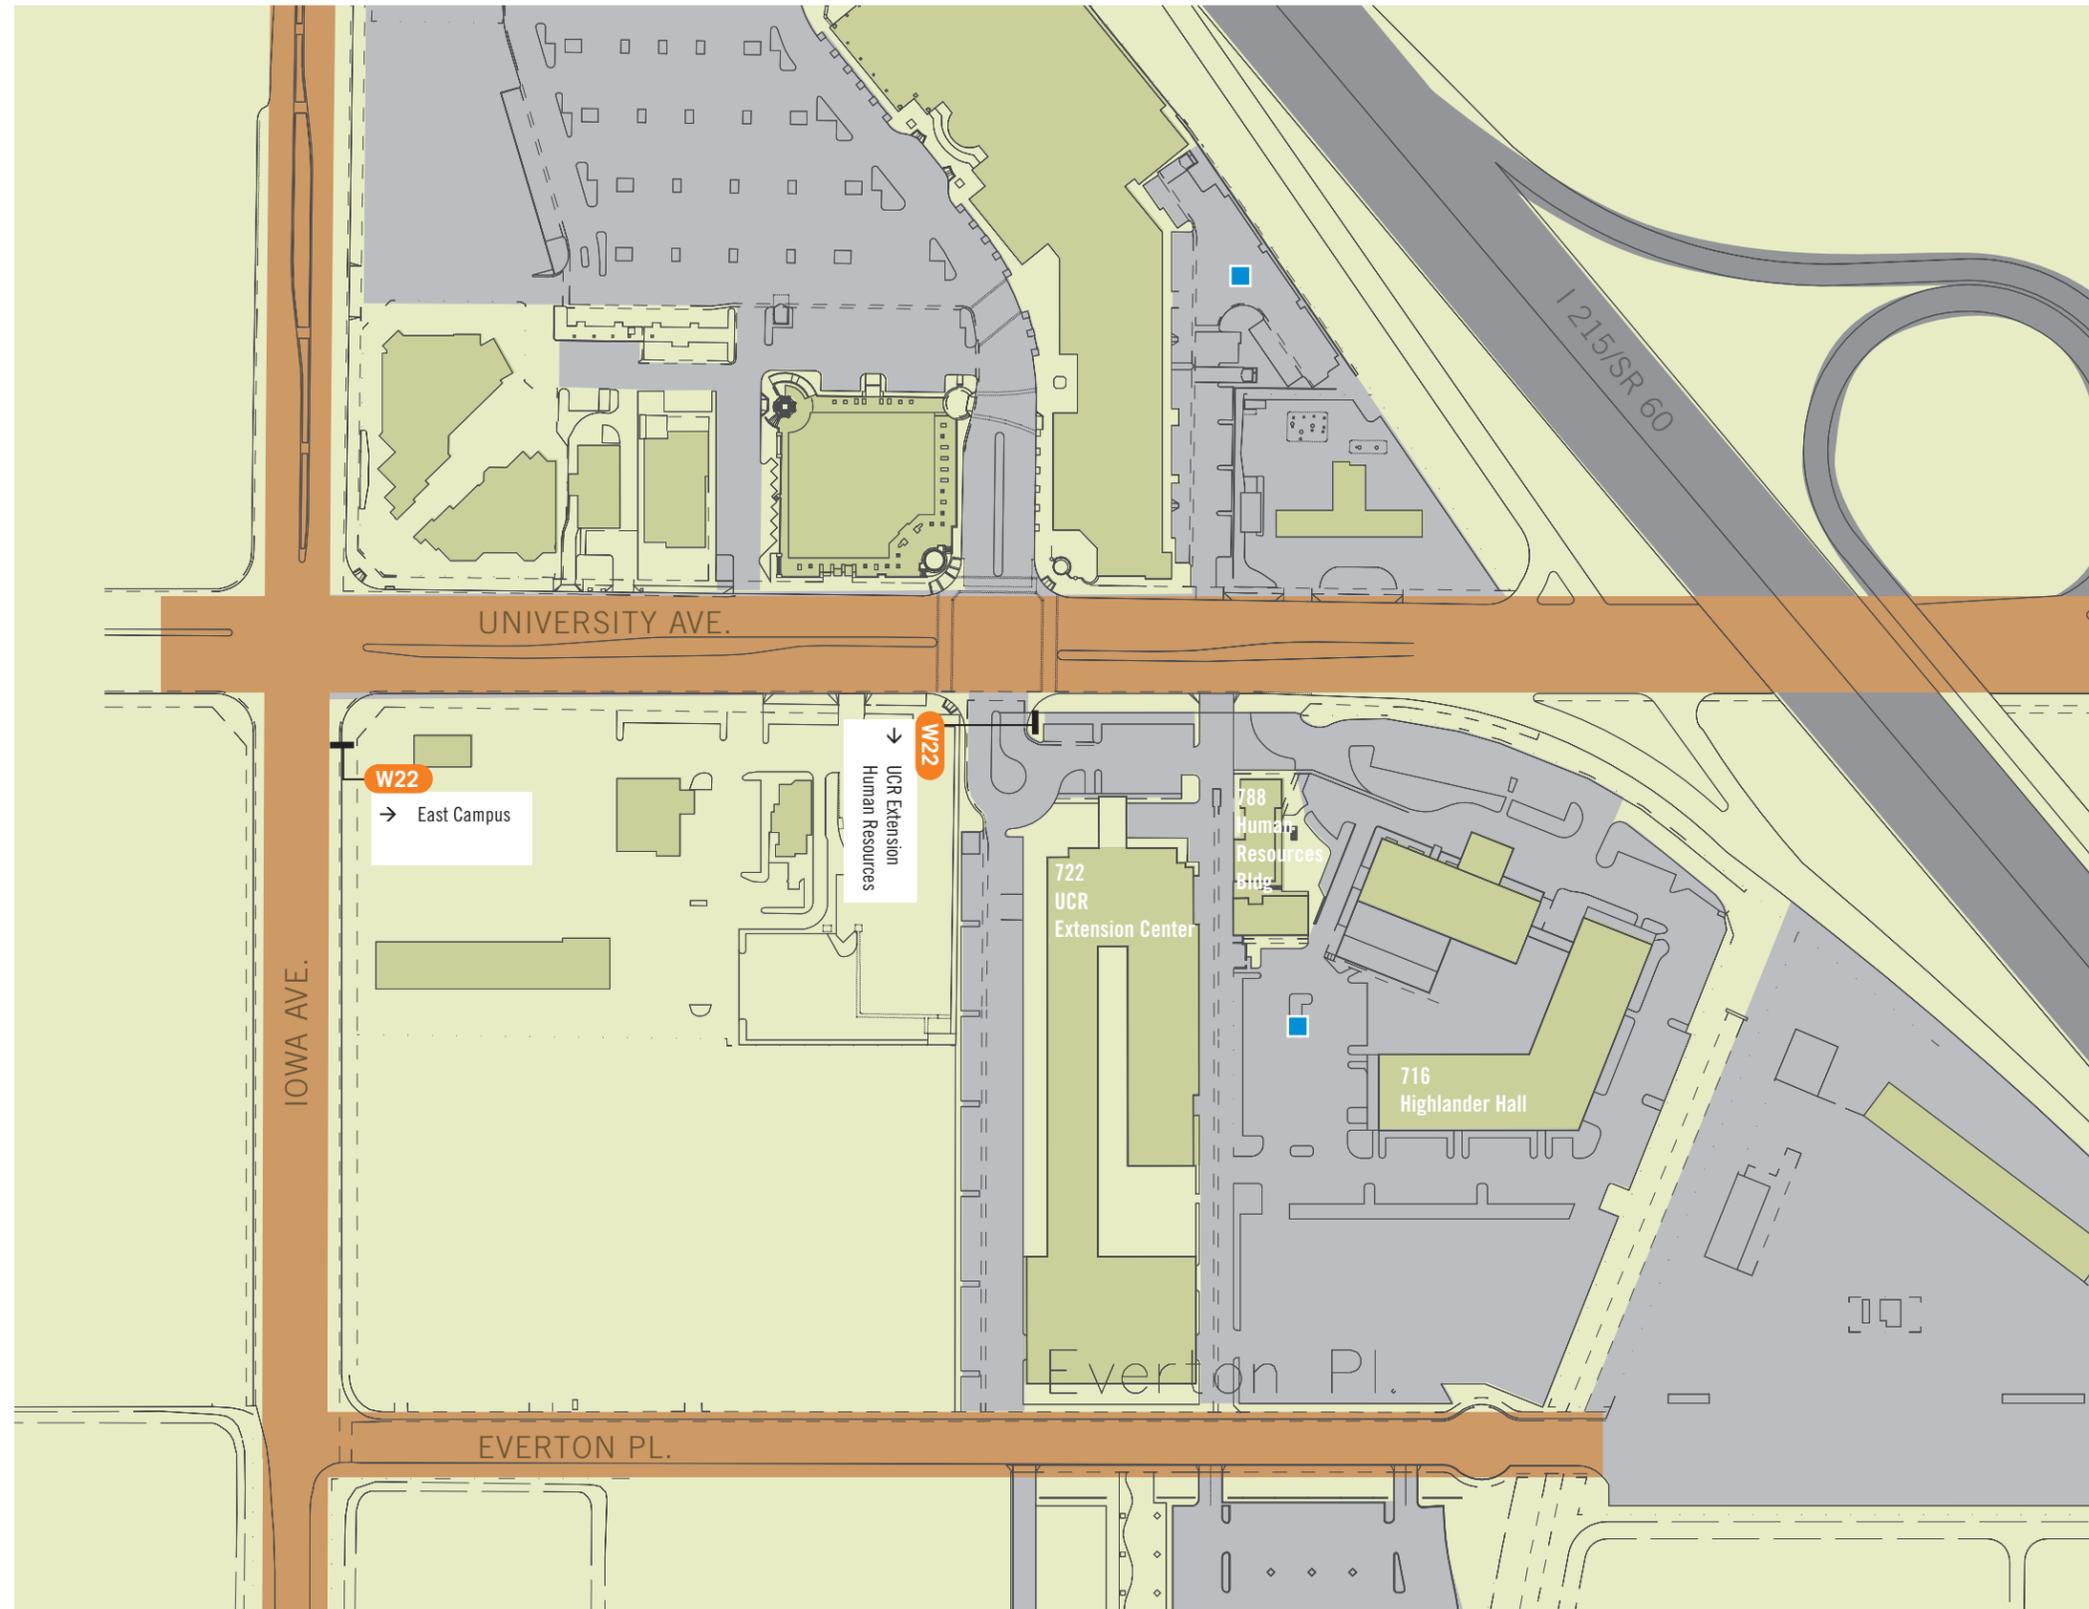

Vehicular Legend

- Off campus vehicular circulation
- On campus primary veh. circulation
- On campus secondary veh. circulation
- Parking Lot Permit Zones
- ★ Information Kiosk

- Vehicular Directional
- W20 Primary
- W21 Secondary
- W22 Pole Mounted

Note:
Lozenge orientation does not necessarily represent accurate sign placement.


Vehicular Destinations

Direct from Perimeter of Campus
Info Kiosk
Botanical Gardens
University Theater

Direct from 2-3 decision points away
Child Dev. Center
Corporation Yard
East Campus
Lothian Hall
Parking Lot 10
Parking Lot 13
Parking Lot 24
Parking Lot 30
Parking Services
Res. Halls
Sports Complex
Student Rec Center
Health Services
West Campus

Direct from 1 decision point away
Ag. Operations
Bannockburn
Biomedical Teaching C omplex
Riviera Library Parking
USDA Lab

H ▲ E

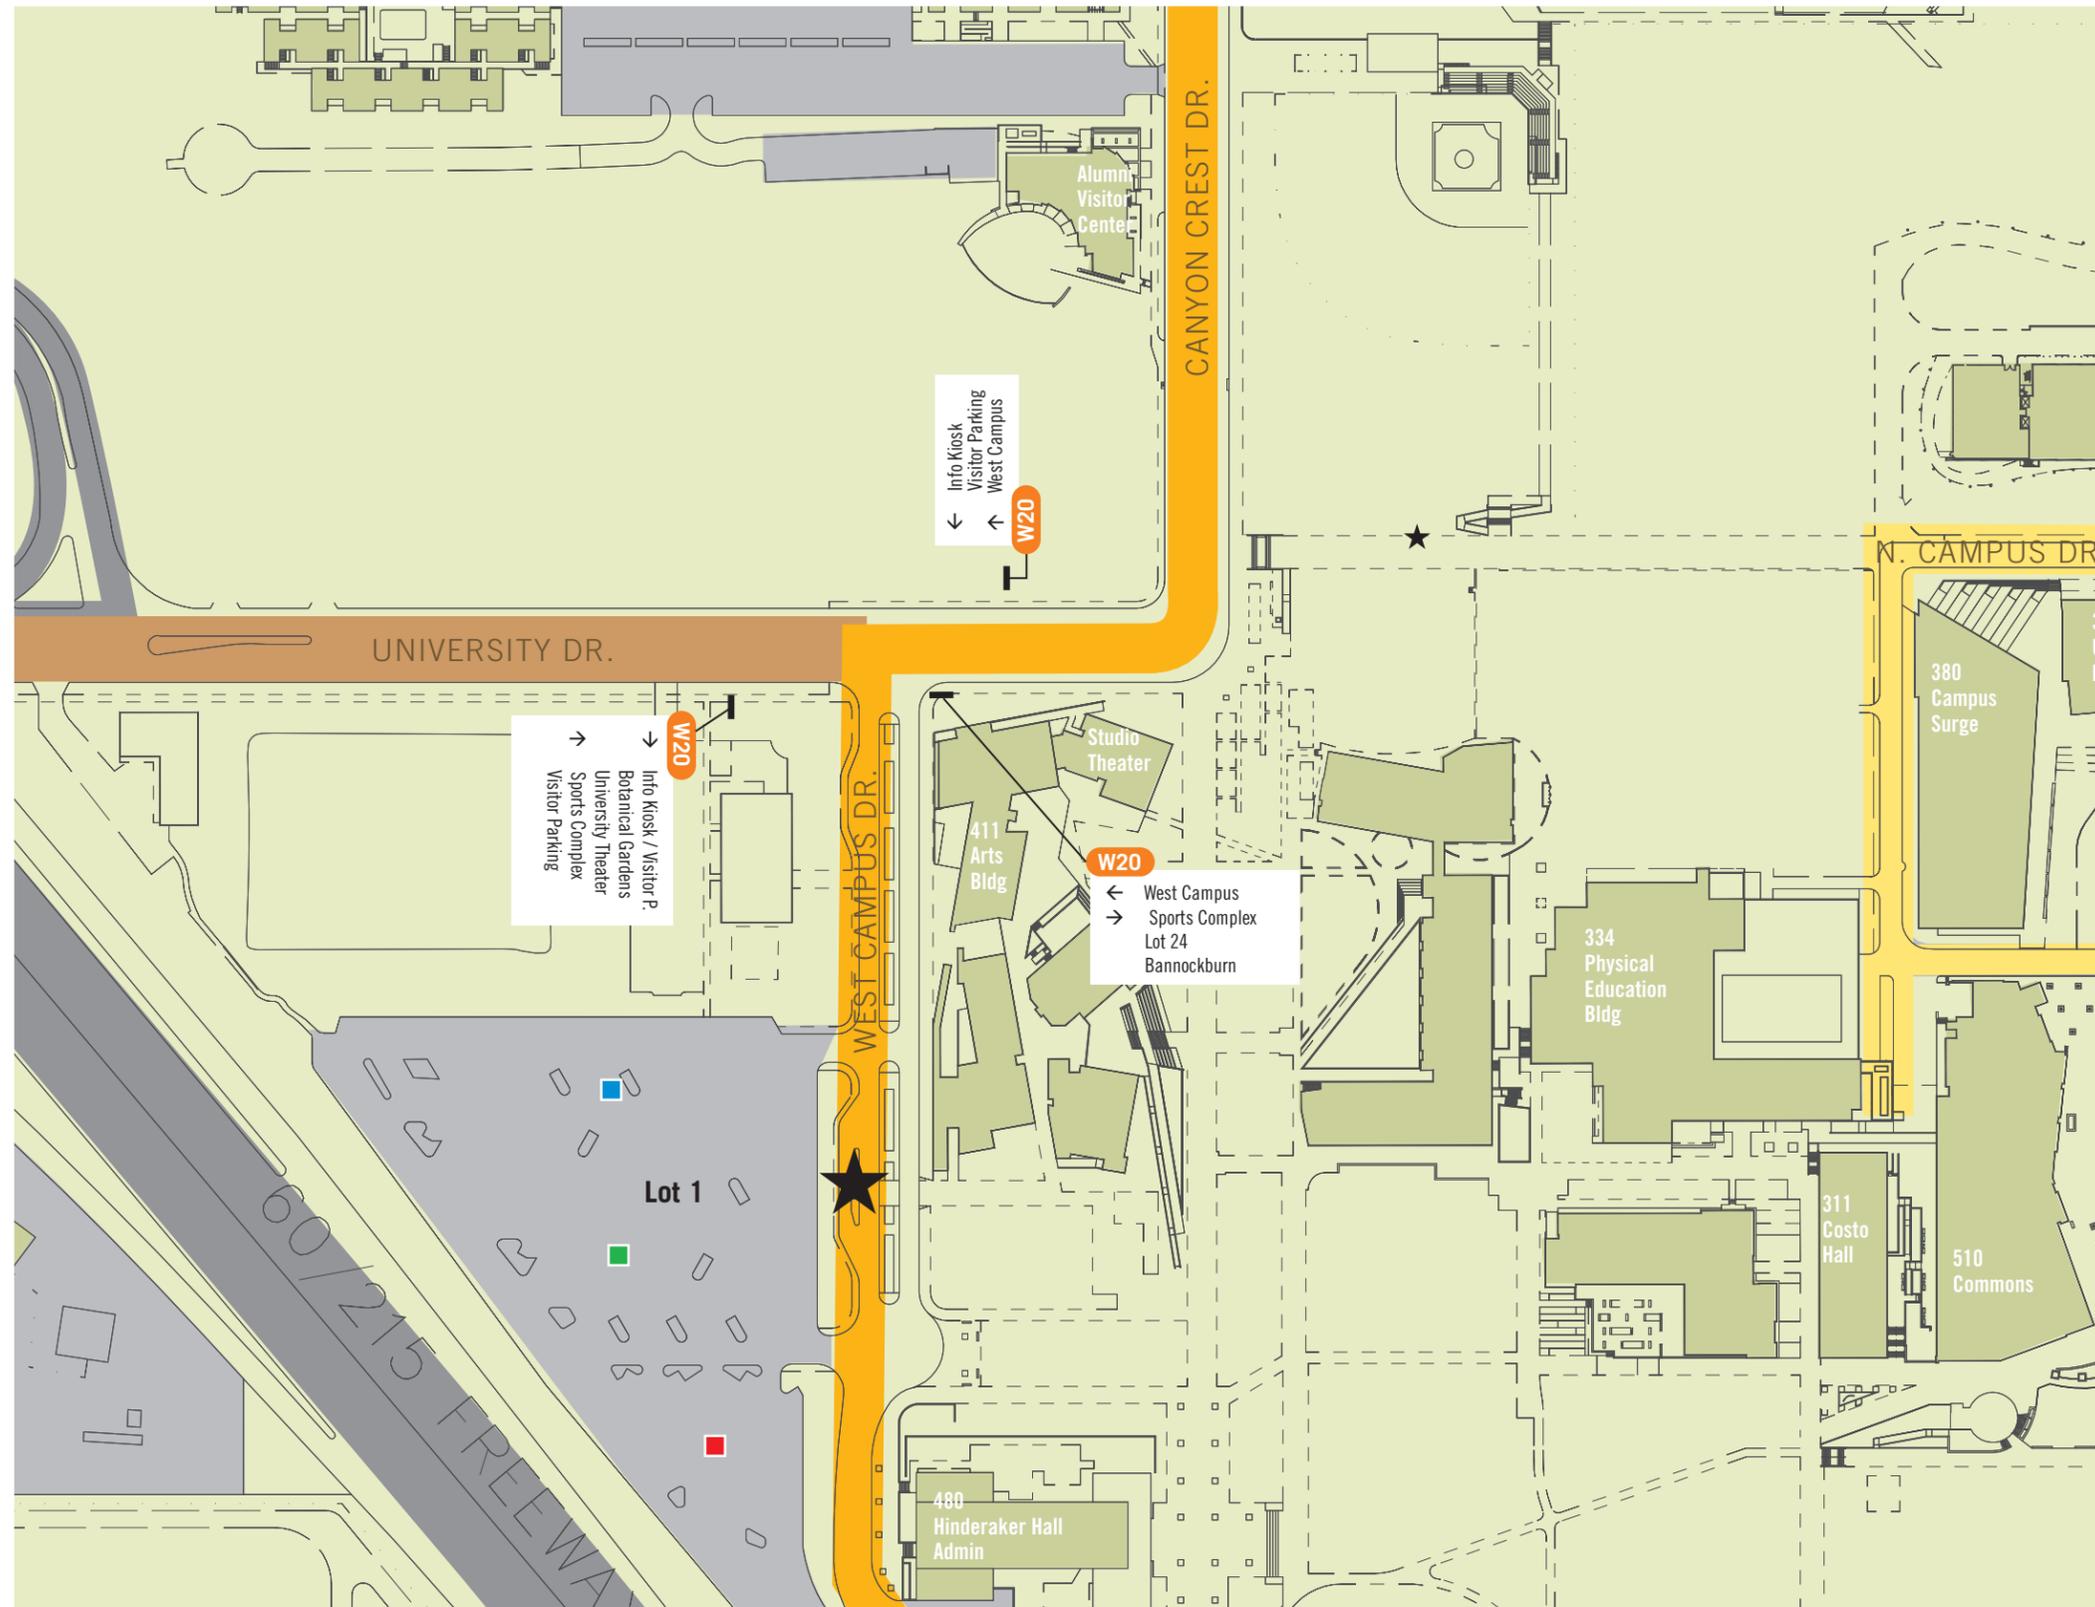

Vehicular Legend

- Off campus vehicular circulation
- On campus primary veh. circulation
- On campus secondary veh. circulation
- Parking Lot Permit Zones
- Information Kiosk
- Vehicular Directional**
- W20 Primary
- W21 Secondary
- W22 Pole Mounted

Note:
Lozenge orientation does not necessarily represent accurate sign placement.

Vehicular Destinations

Direct from Perimeter of Campus

- Info Kiosk
- Botanical Gardens
- University Theater


Direct from 2-3 decision points away

- Child Dev. Center
- Corporation Yard
- East Campus
- Lothian Hall
- Parking Lot 10
- Parking Lot 13
- Parking Lot 24
- Parking Lot 30
- Parking Services
- Res. Halls
- Sports Complex
- Student Rec Center
- Health Services
- West Campus

Direct from 1 decision point away

- Ag. Operations
- Bannockburn
- Biomedical Teaching C omplex
- Riviera Library Parking
- USDA Lab

▲ J
M ▼

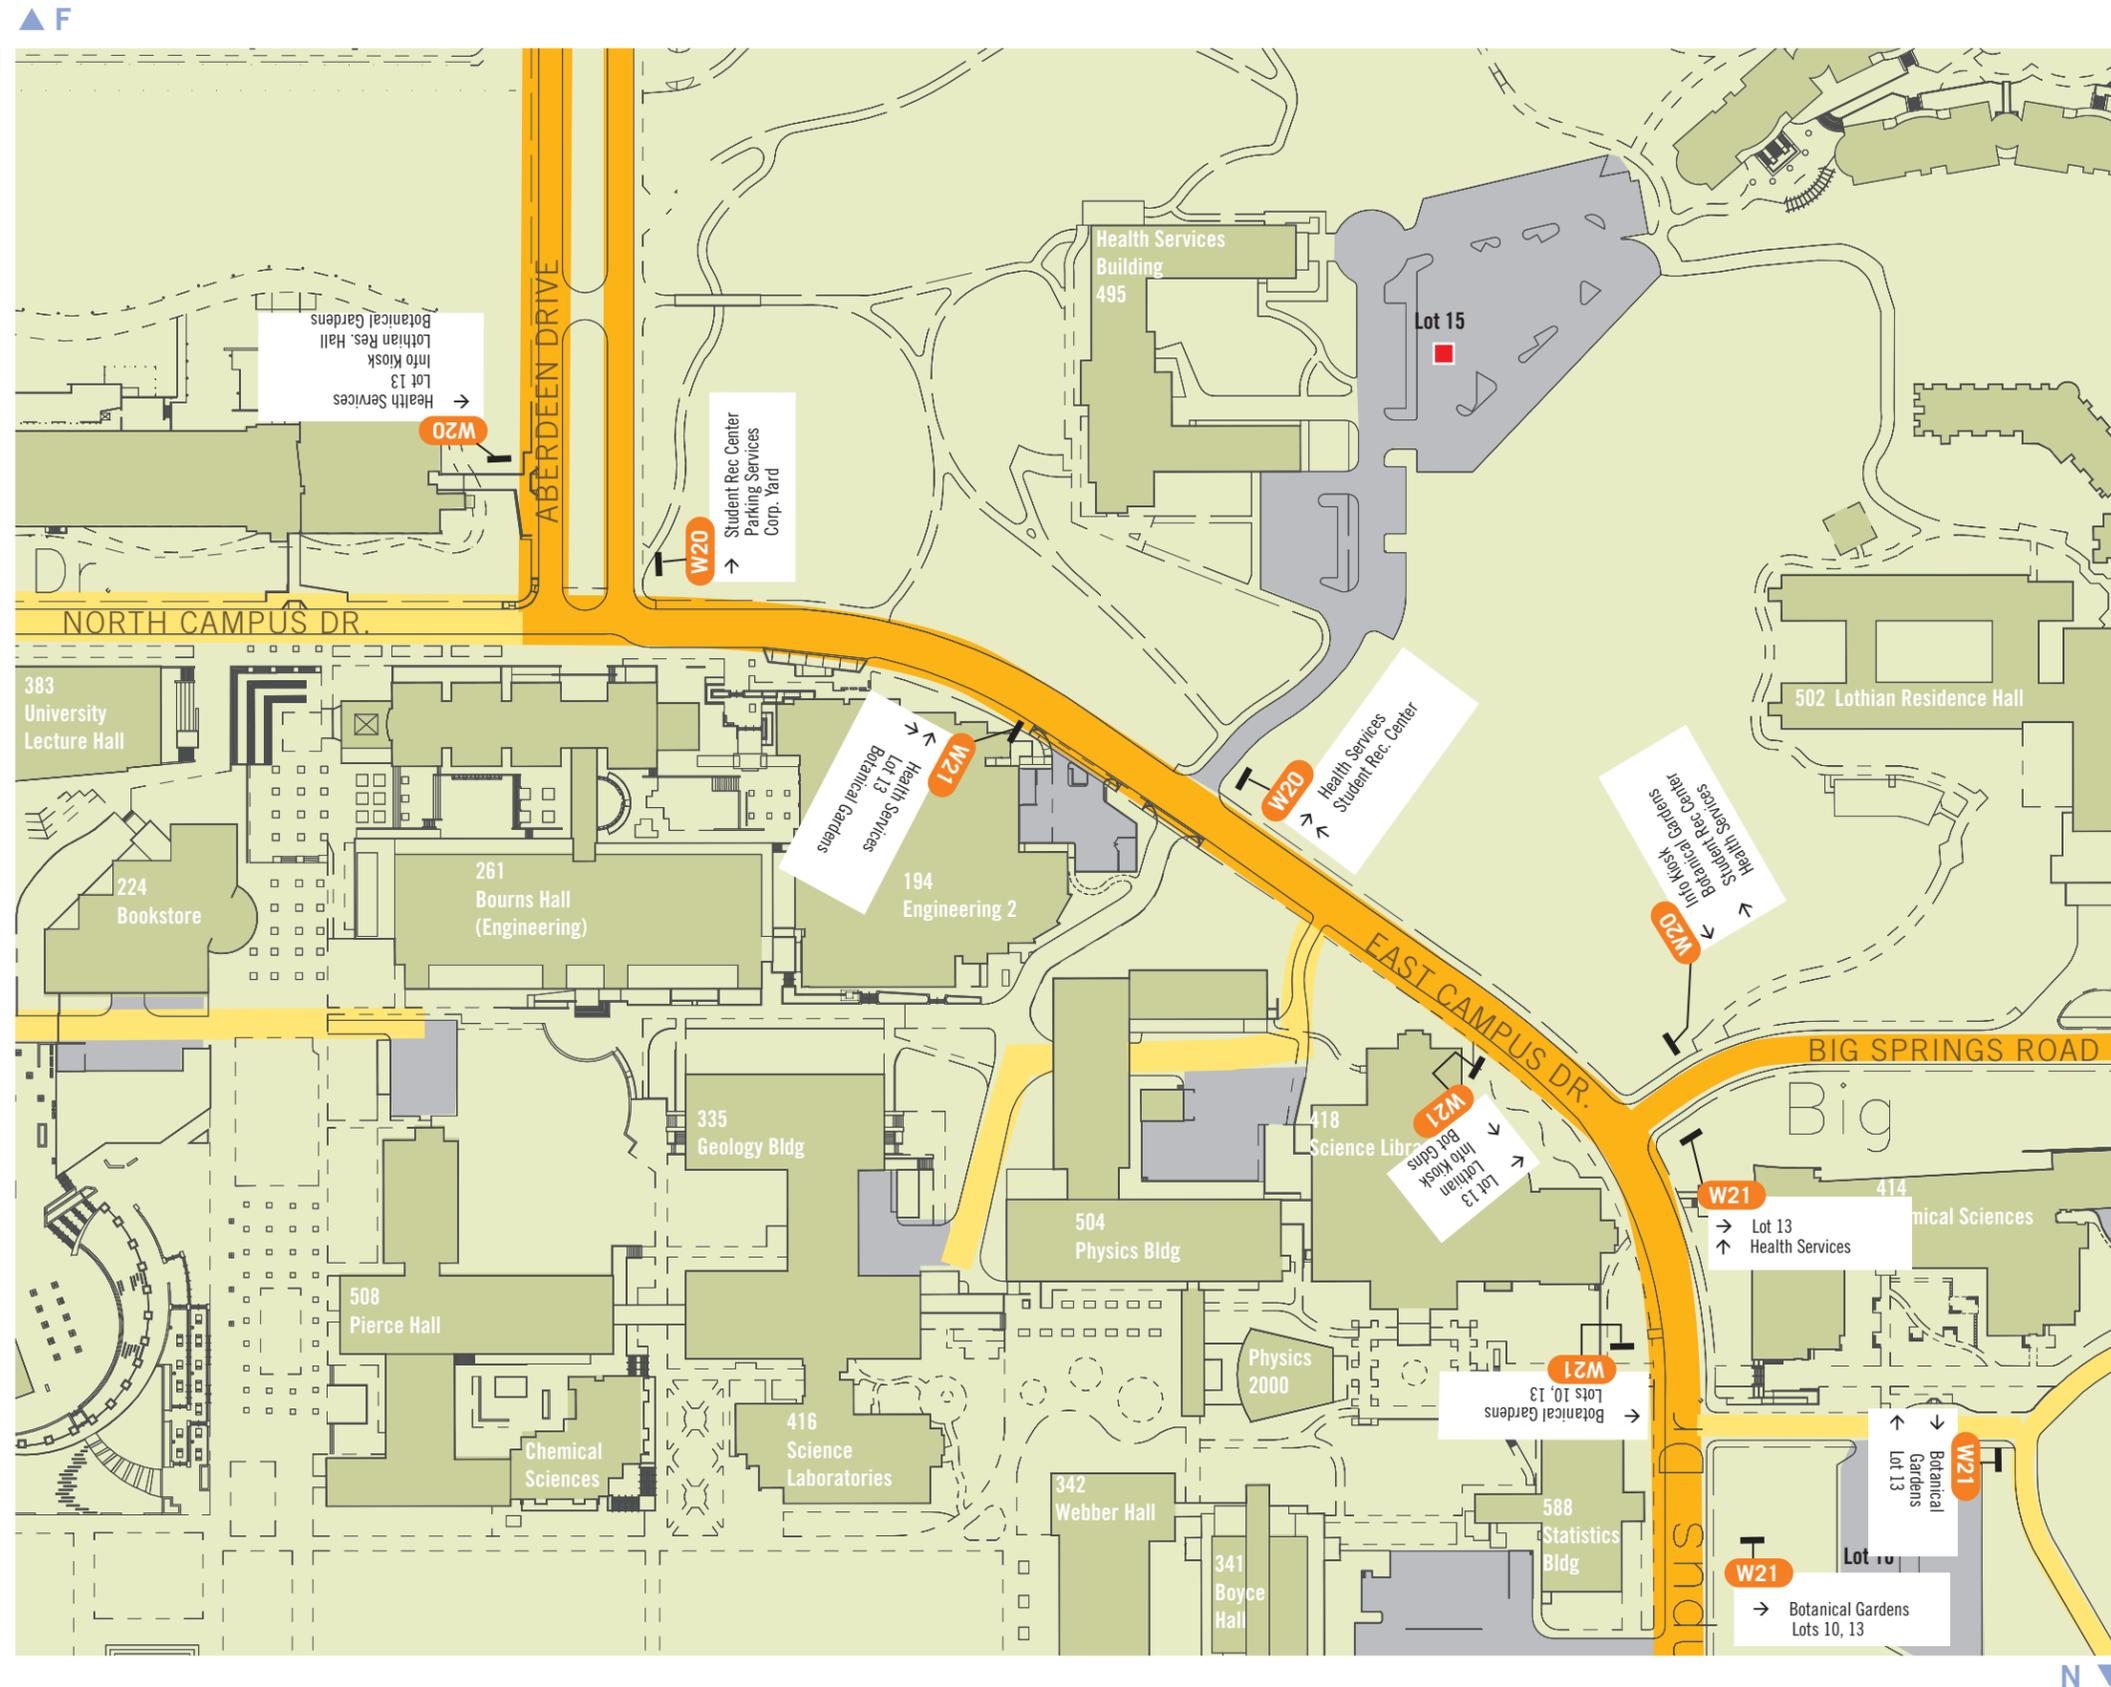

Vehicular Legend

- Off campus vehicular circulation
- On campus primary veh. circulation
- On campus secondary veh. circulation
- Parking Lot Permit Zones
- Information Kiosk
- Vehicular Directional
 - W20 Primary
 - W21 Secondary
 - W22 Pole Mounted

Note:
Lozenge orientation does not necessarily represent accurate sign placement.

Vehicular Destinations

Direct from Perimeter of Campus

- Info Kiosk
- Botanical Gardens
- University Theater

Direct from 2-3 decision points away

- Child Dev. Center
- Corporation Yard
- East Campus
- Lothian Hall
- Parking Lot 10
- Parking Lot 13
- Parking Lot 24
- Parking Lot 30
- Parking Services
- Res. Halls
- Sports Complex
- Student Rec Center
- Health Services
- West Campus

Direct from 1 decision point away

- Ag. Operations
- Bannockburn
- Biomedical Teaching C omplex
- Riviera Library Parking
- USDA Lab



Vehicular Legend

- Off campus vehicular circulation
 - On campus primary veh. circulation
 - On campus secondary veh. circulation
 - Parking Lot Permit Zones
 - Information Kiosk
-
- Vehicular Directional**
 - W20 Primary
 - W21 Secondary
 - W22 Pole Mounted


Note:
Lozenge orientation does not necessarily represent accurate sign placement.

Vehicular Destinations

Direct from Perimeter of Campus
Info Kiosk
Botanical Gardens
University Theater

Direct from 2-3 decision points away
Child Dev. Center
Corporation Yard
East Campus
Lothian Hall
Parking Lot 10
Parking Lot 13
Parking Lot 24
Parking Lot 30
Parking Services
Res. Halls
Sports Complex
Student Rec Center
Health Services
West Campus

Direct from 1 decision point away
Ag. Operations
Bannockburn
Biomedical Teaching Complex
Riviera Library Parking
USDA Lab

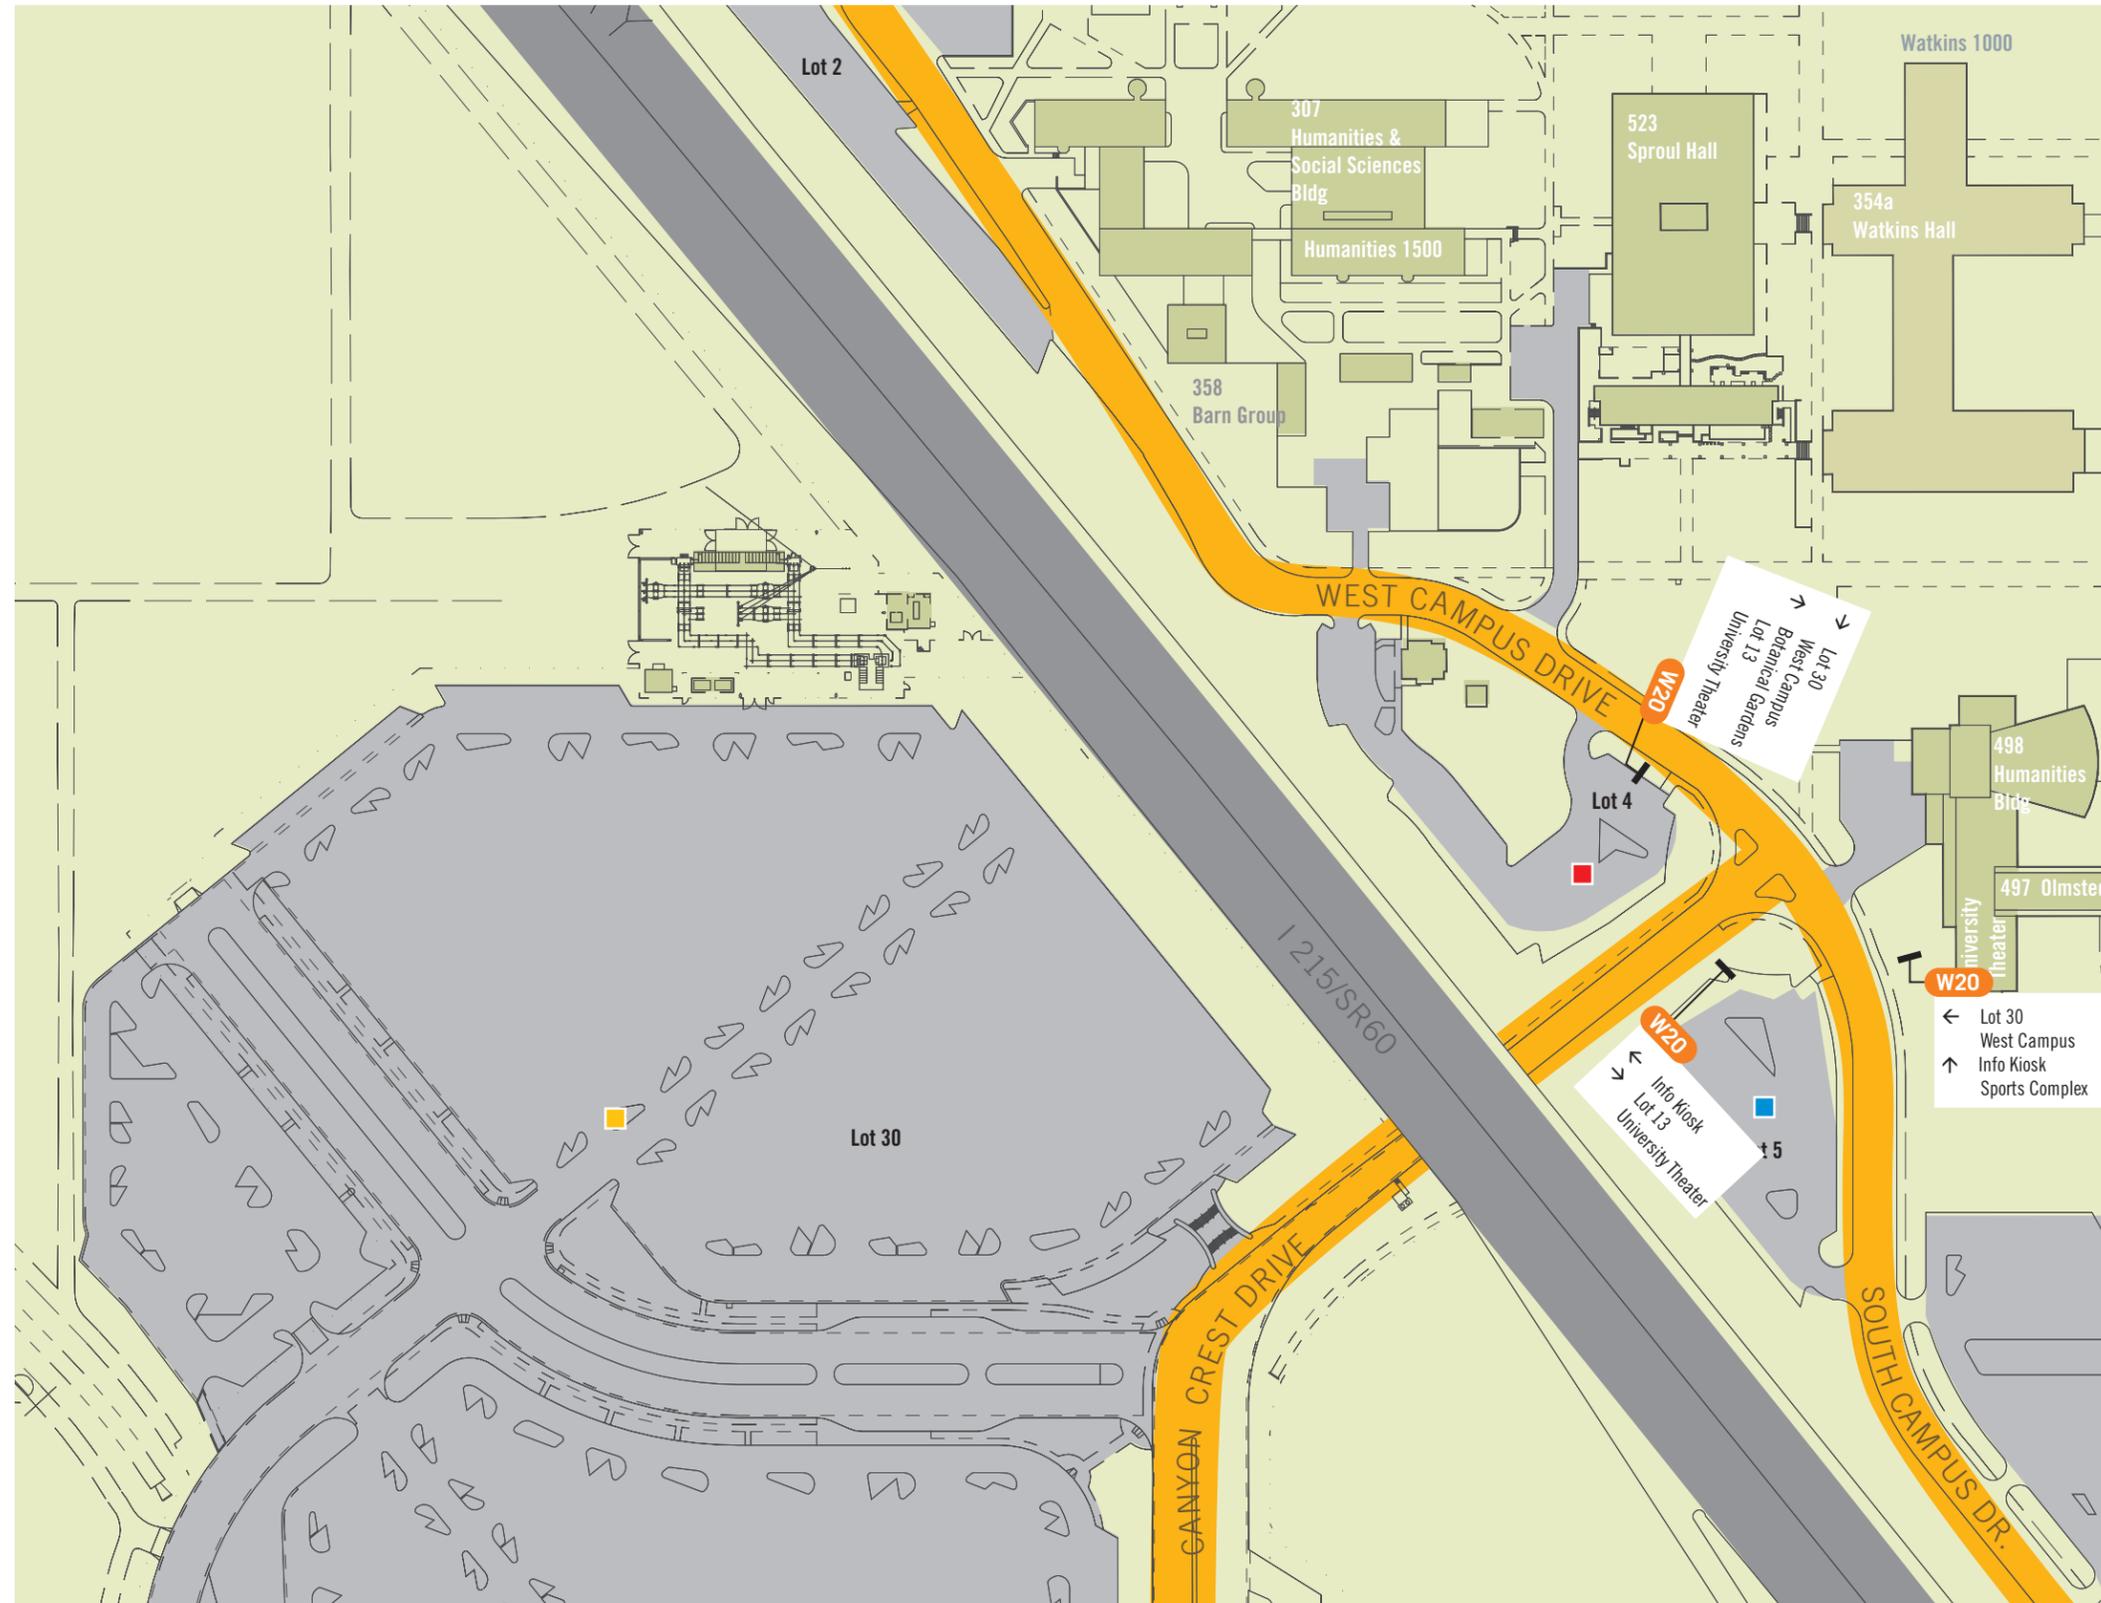

Vehicular Legend

- Off campus vehicular circulation
 - On campus primary veh. circulation
 - On campus secondary veh. circulation
 - Parking Lot Permit Zones
 - Information Kiosk
-
- Vehicular Directional
 - W20 Primary
 - W21 Secondary
 - W22 Pole Mounted

Note:
Lozenge orientation does not necessarily represent accurate sign placement.

Vehicular Destinations

Direct from Perimeter of Campus

- Info Kiosk
- Botanical Gardens
- University Theater

Direct from 2-3 decision points away


- Child Dev. Center
- Corporation Yard
- East Campus
- Lothian Hall
- Parking Lot 10
- Parking Lot 13
- Parking Lot 24
- Parking Lot 30
- Parking Services
- Res. Halls
- Sports Complex
- Student Rec Center
- Health Services
- West Campus

Direct from 1 decision point away

- Ag. Operations
- Bannockburn
- Biomedical Teaching C omplex
- Riviera Library Parking
- USDA Lab



J
M

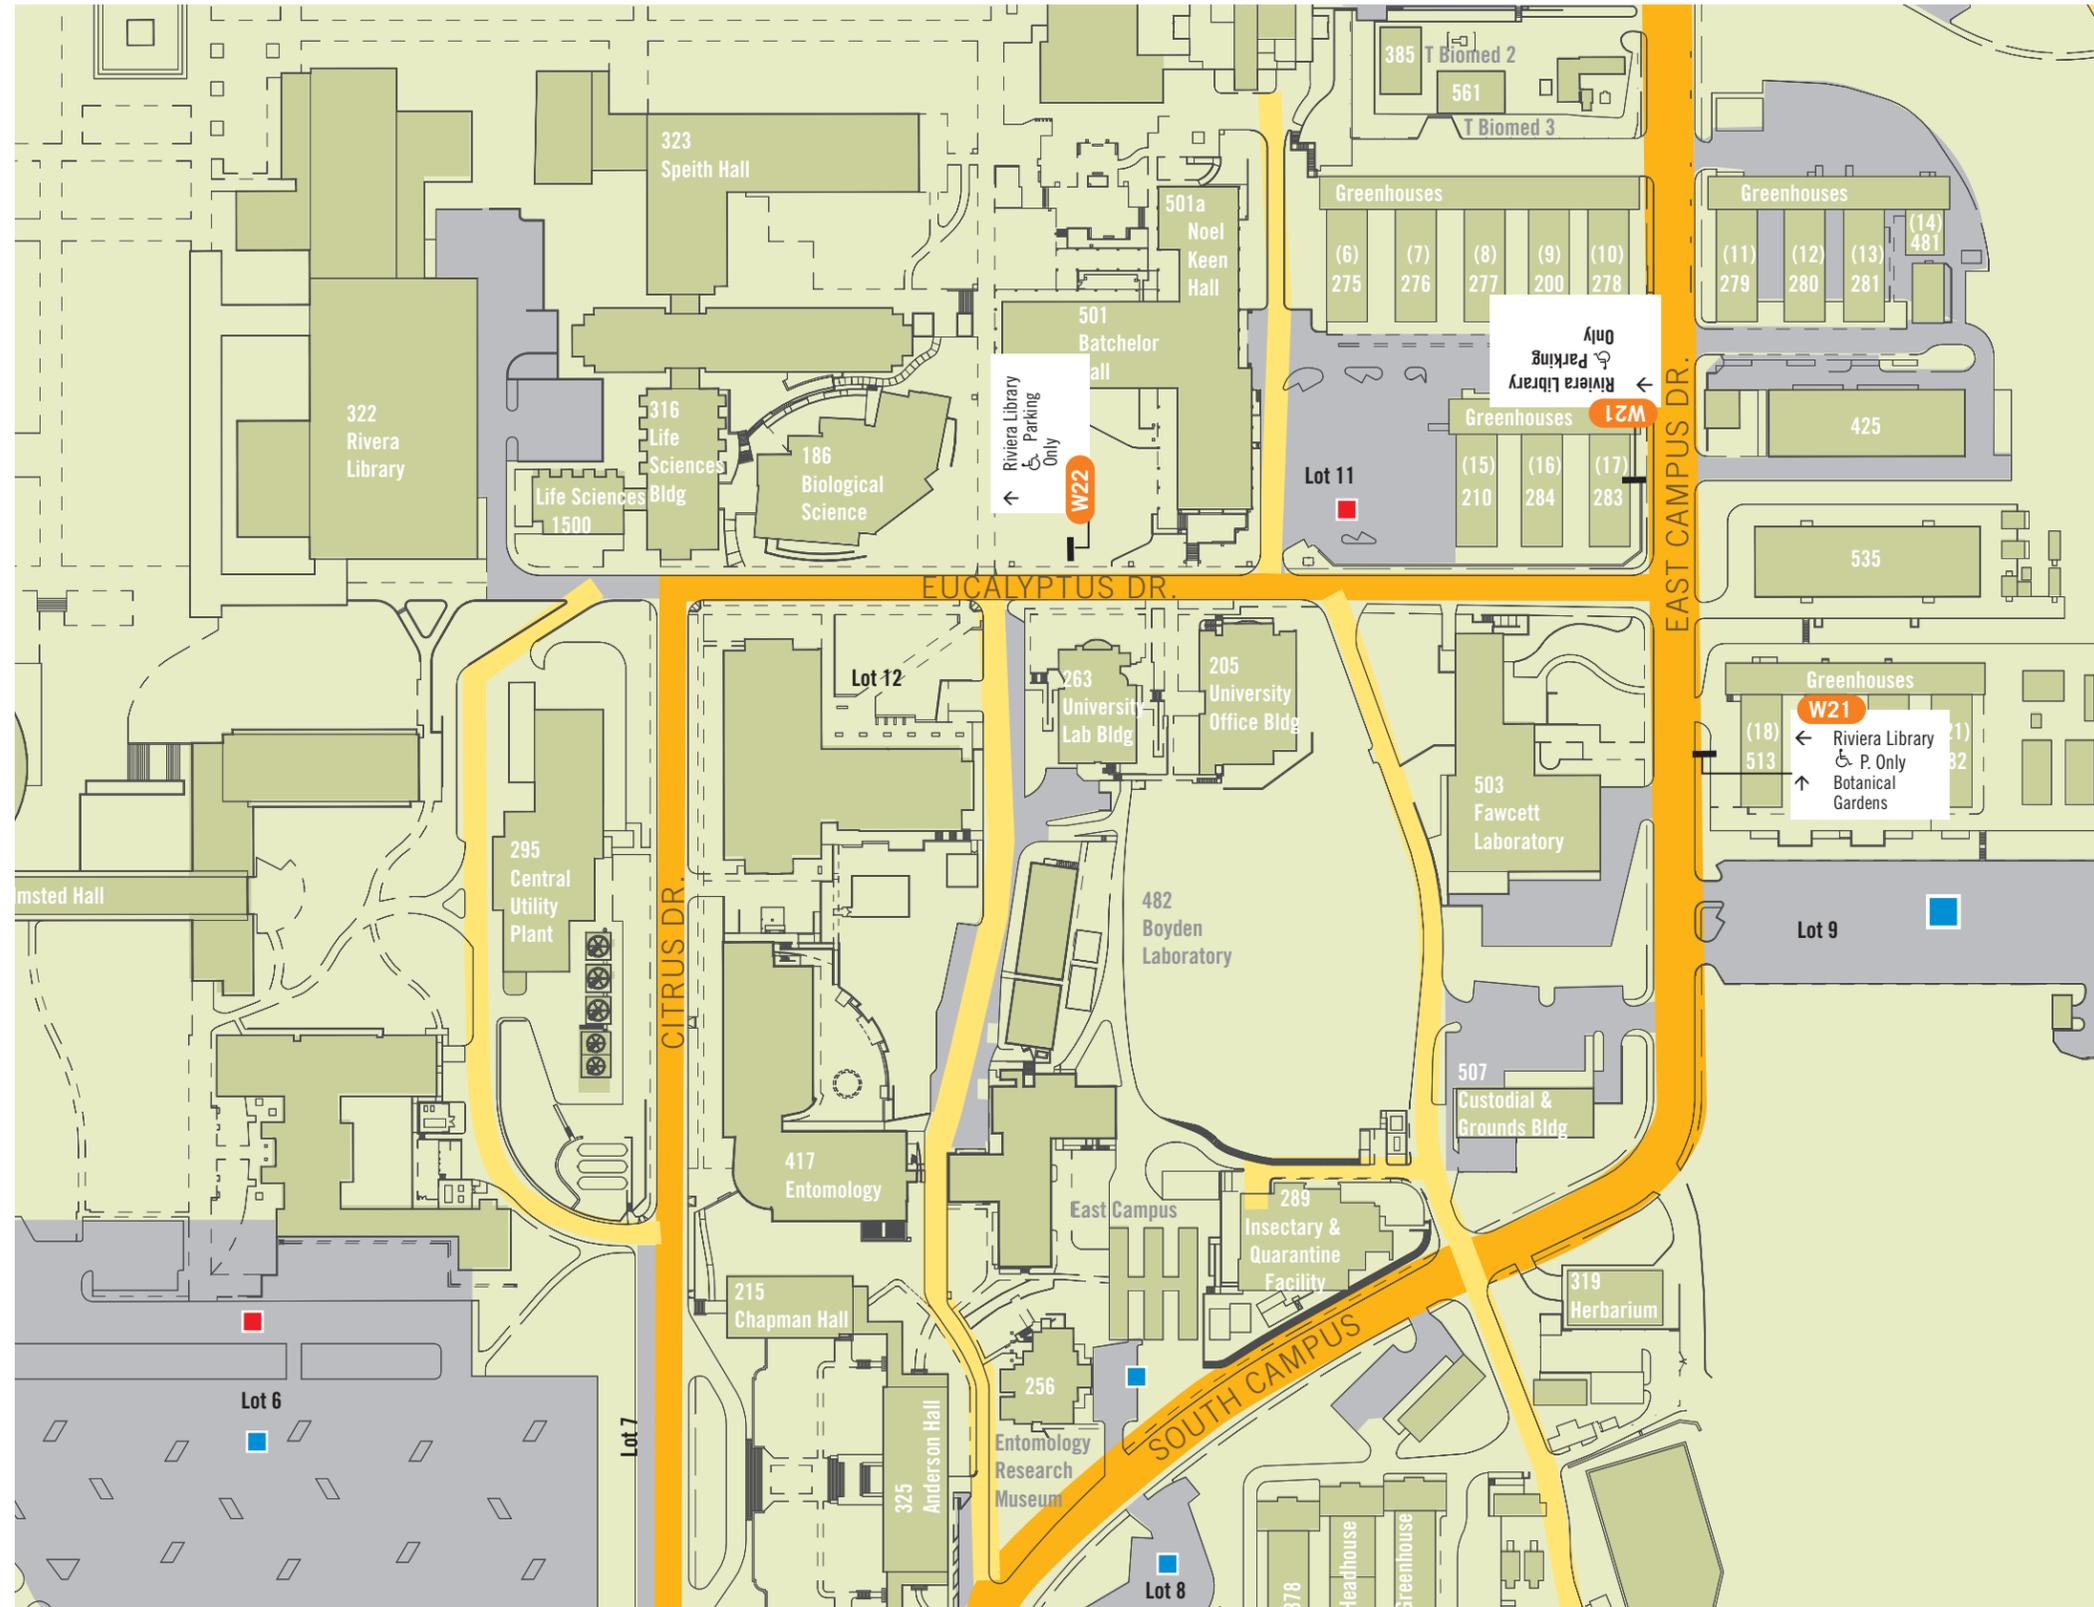

Vehicular Legend

- Off campus vehicular circulation
- On campus primary veh. circulation
- On campus secondary veh. circulation
- Parking Lot Permit Zones
- Information Kiosk
- Vehicular Directional
 - W20 Primary
 - W21 Secondary
 - W22 Pole Mounted

Note:
Lozenge orientation does not necessarily represent accurate sign placement.

Vehicular Destinations

Direct from Perimeter of Campus
Info Kiosk
Botanical Gardens
University Theater

Direct from 2-3 decision points away
Child Dev. Center
Corporation Yard
East Campus
Lothian Hall
Parking Lot 10
Parking Lot 13
Parking Lot 24
Parking Lot 30
Parking Services
Res. Halls
Sports Complex
Student Rec Center
Health Services
West Campus

Direct from 1 decision point away
Ag. Operations
Bannockburn
Biomedical Teaching C omplex
Riviera Library Parking
USDA Lab

S
O

P ▲ L



Vehicular Legend

- Off campus vehicular circulation
 - On campus primary veh. circulation
 - On campus secondary veh. circulation
 - Parking Lot Permit Zones
 - ★ Information Kiosk
-
- Vehicular Directional**
 - W20 Primary
 - W21 Secondary
 - W22 Pole Mounted

Note:
Lozenge orientation does not necessarily represent accurate sign placement.


Vehicular Destinations

Direct from Perimeter of Campus
Info Kiosk
Botanical Gardens
University Theater

Direct from 2-3 decision points away
Child Dev. Center
Corporation Yard
East Campus
Lothian Hall
Parking Lot 10
Parking Lot 13
Parking Lot 24
Parking Lot 30
Parking Services
Res. Halls
Sports Complex
Student Rec Center
Health Services
West Campus

Direct from 1 decision point away
Ag. Operations
Bannockburn
Biomedical Teaching C omplex
Riviera Library Parking
USDA Lab

▶ R

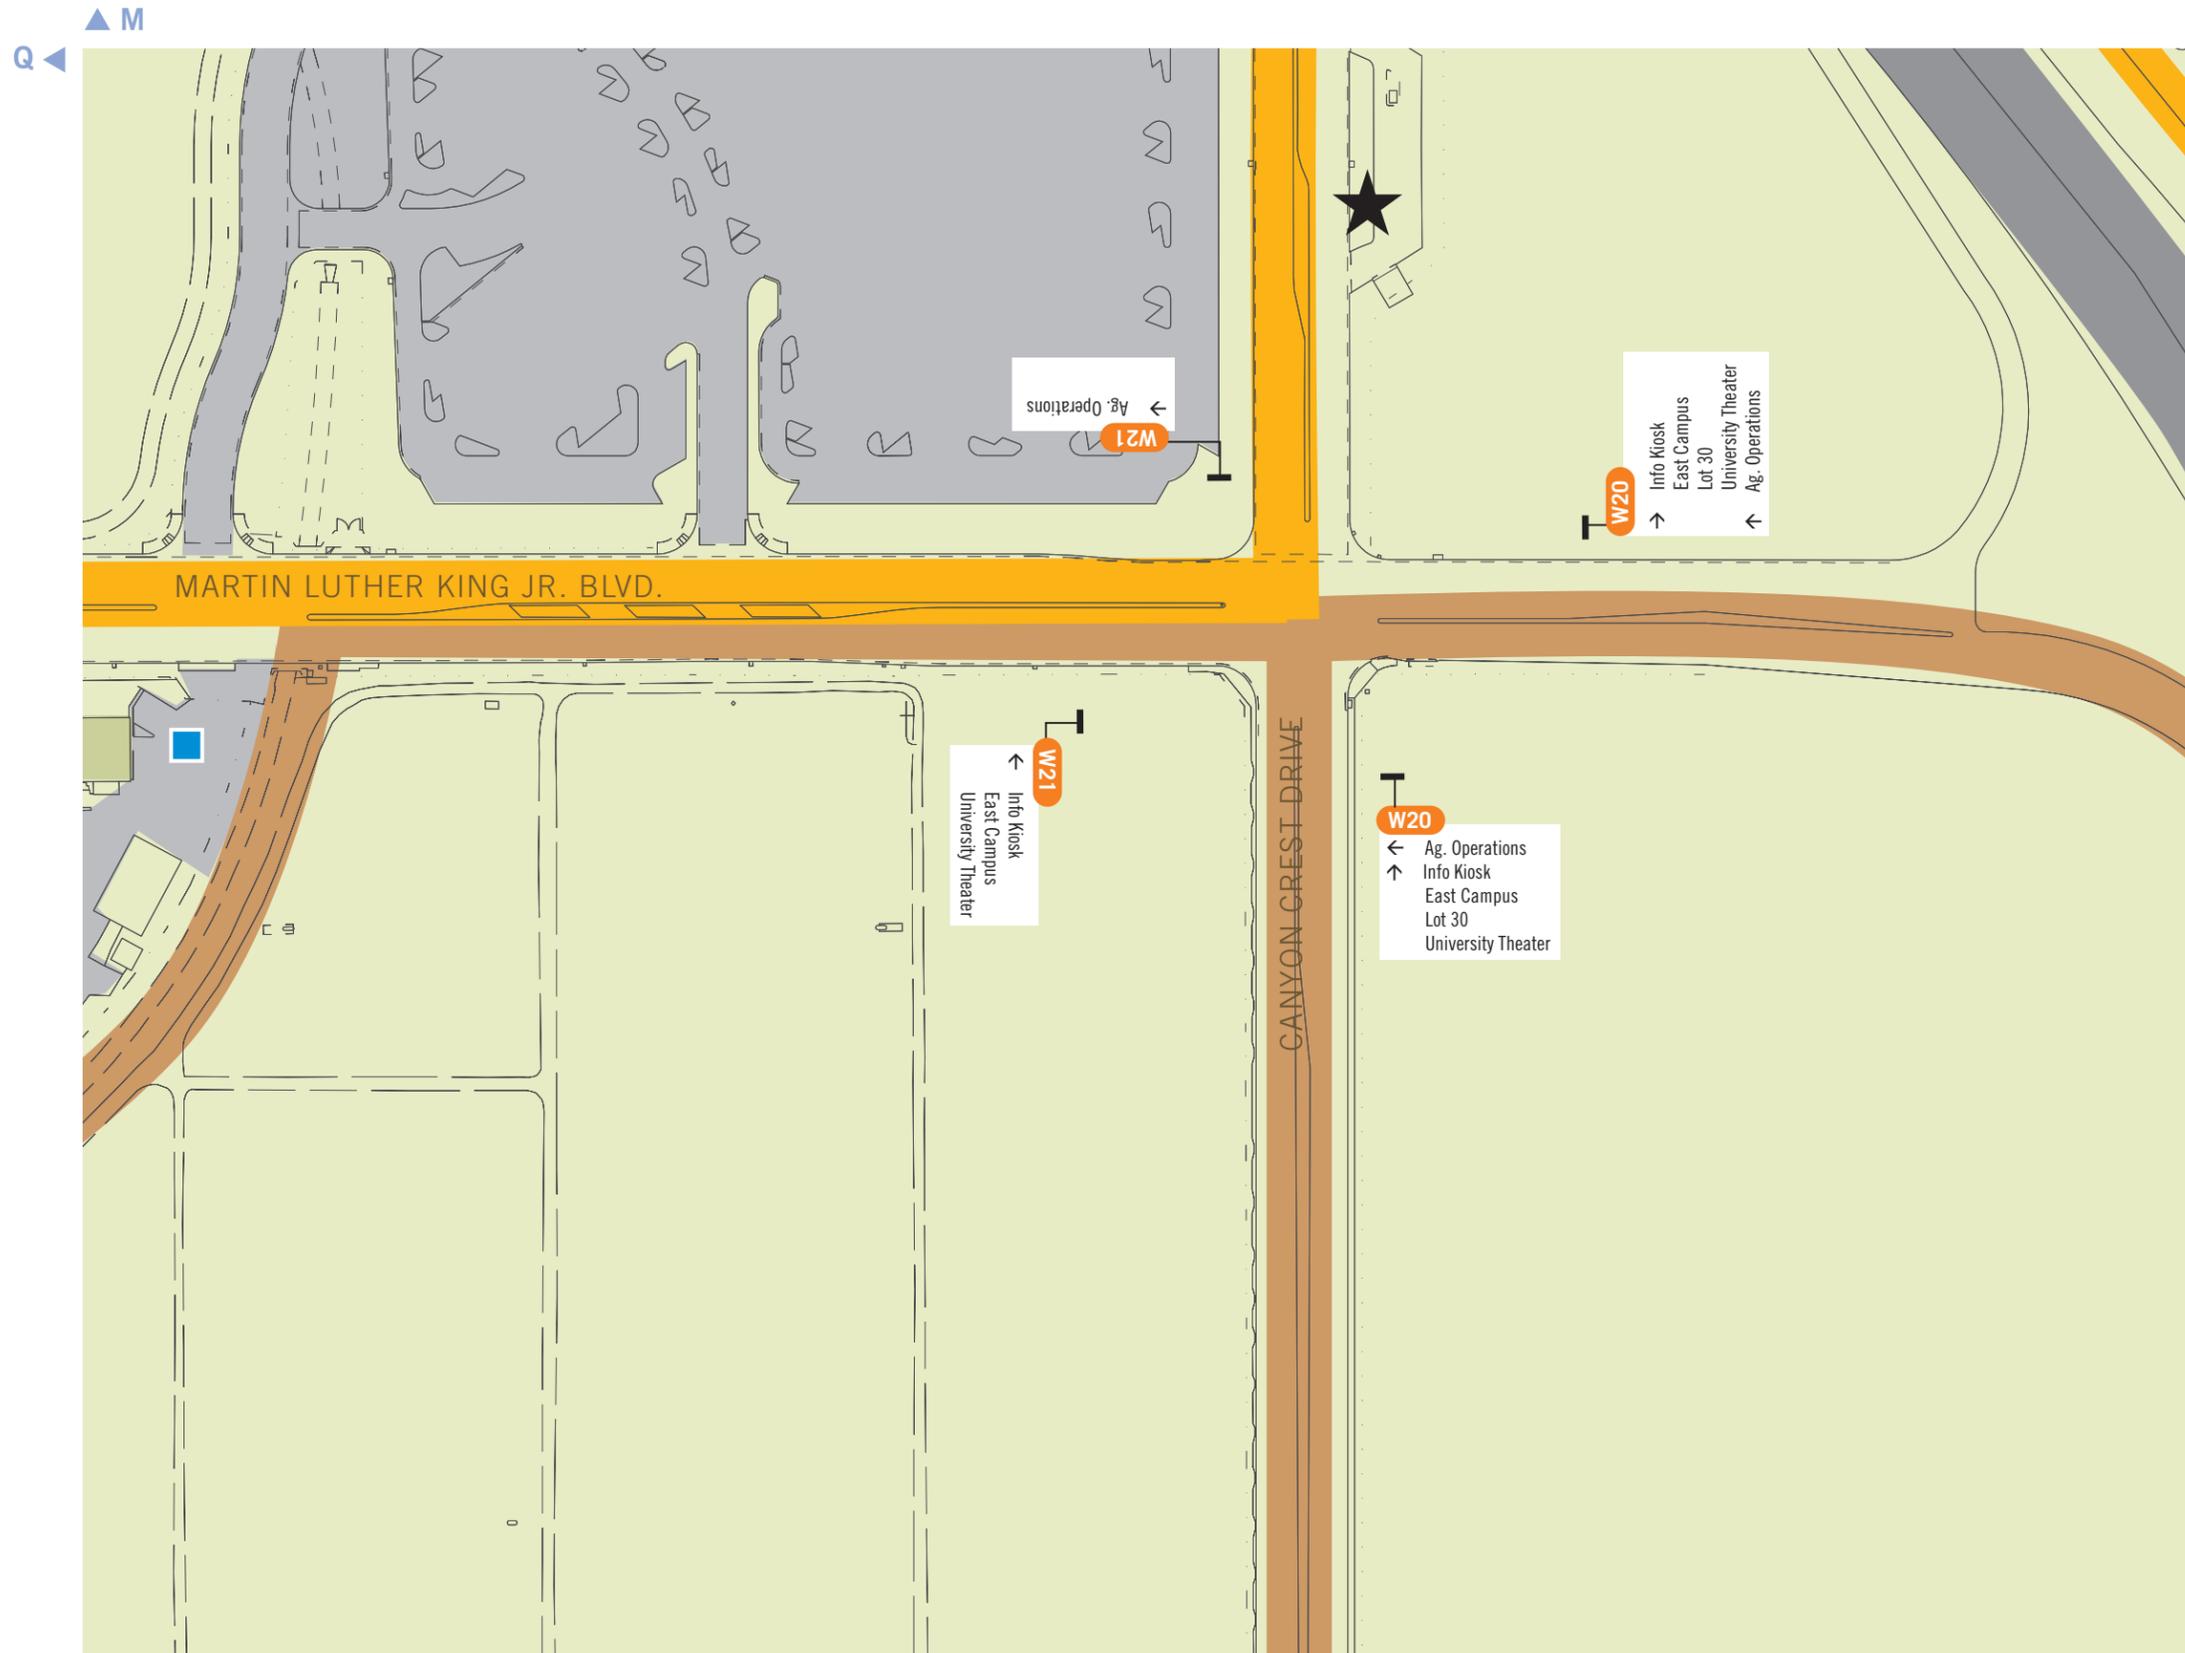

Vehicular Legend


- Off campus vehicular circulation
- On campus primary veh. circulation
- On campus secondary veh. circulation
- Parking Lot Permit Zones
- ★ Information Kiosk

Vehicular Directional

- W20 Primary
- W21 Secondary
- W22 Pole Mounted

Note:
Lozenge orientation does not necessarily represent accurate sign placement.

- Vehicular Destinations**
- Direct from Perimeter of Campus**
 - Info Kiosk
 - Botanical Gardens
 - University Theater
 - Direct from 2-3 decision points away**
 - Child Dev. Center
 - Corporation Yard
 - East Campus
 - Lothian Hall
 - Parking Lot 10
 - Parking Lot 13
 - Parking Lot 24
 - Parking Lot 30
 - Parking Services
 - Res. Halls
 - Sports Complex
 - Student Rec Center
 - Health Services
 - West Campus
 - Direct from 1 decision point away**
 - Ag. Operations
 - Bannockburn
 - Biomedical Teaching Complex
 - Riviera Library Parking
 - USDA Lab

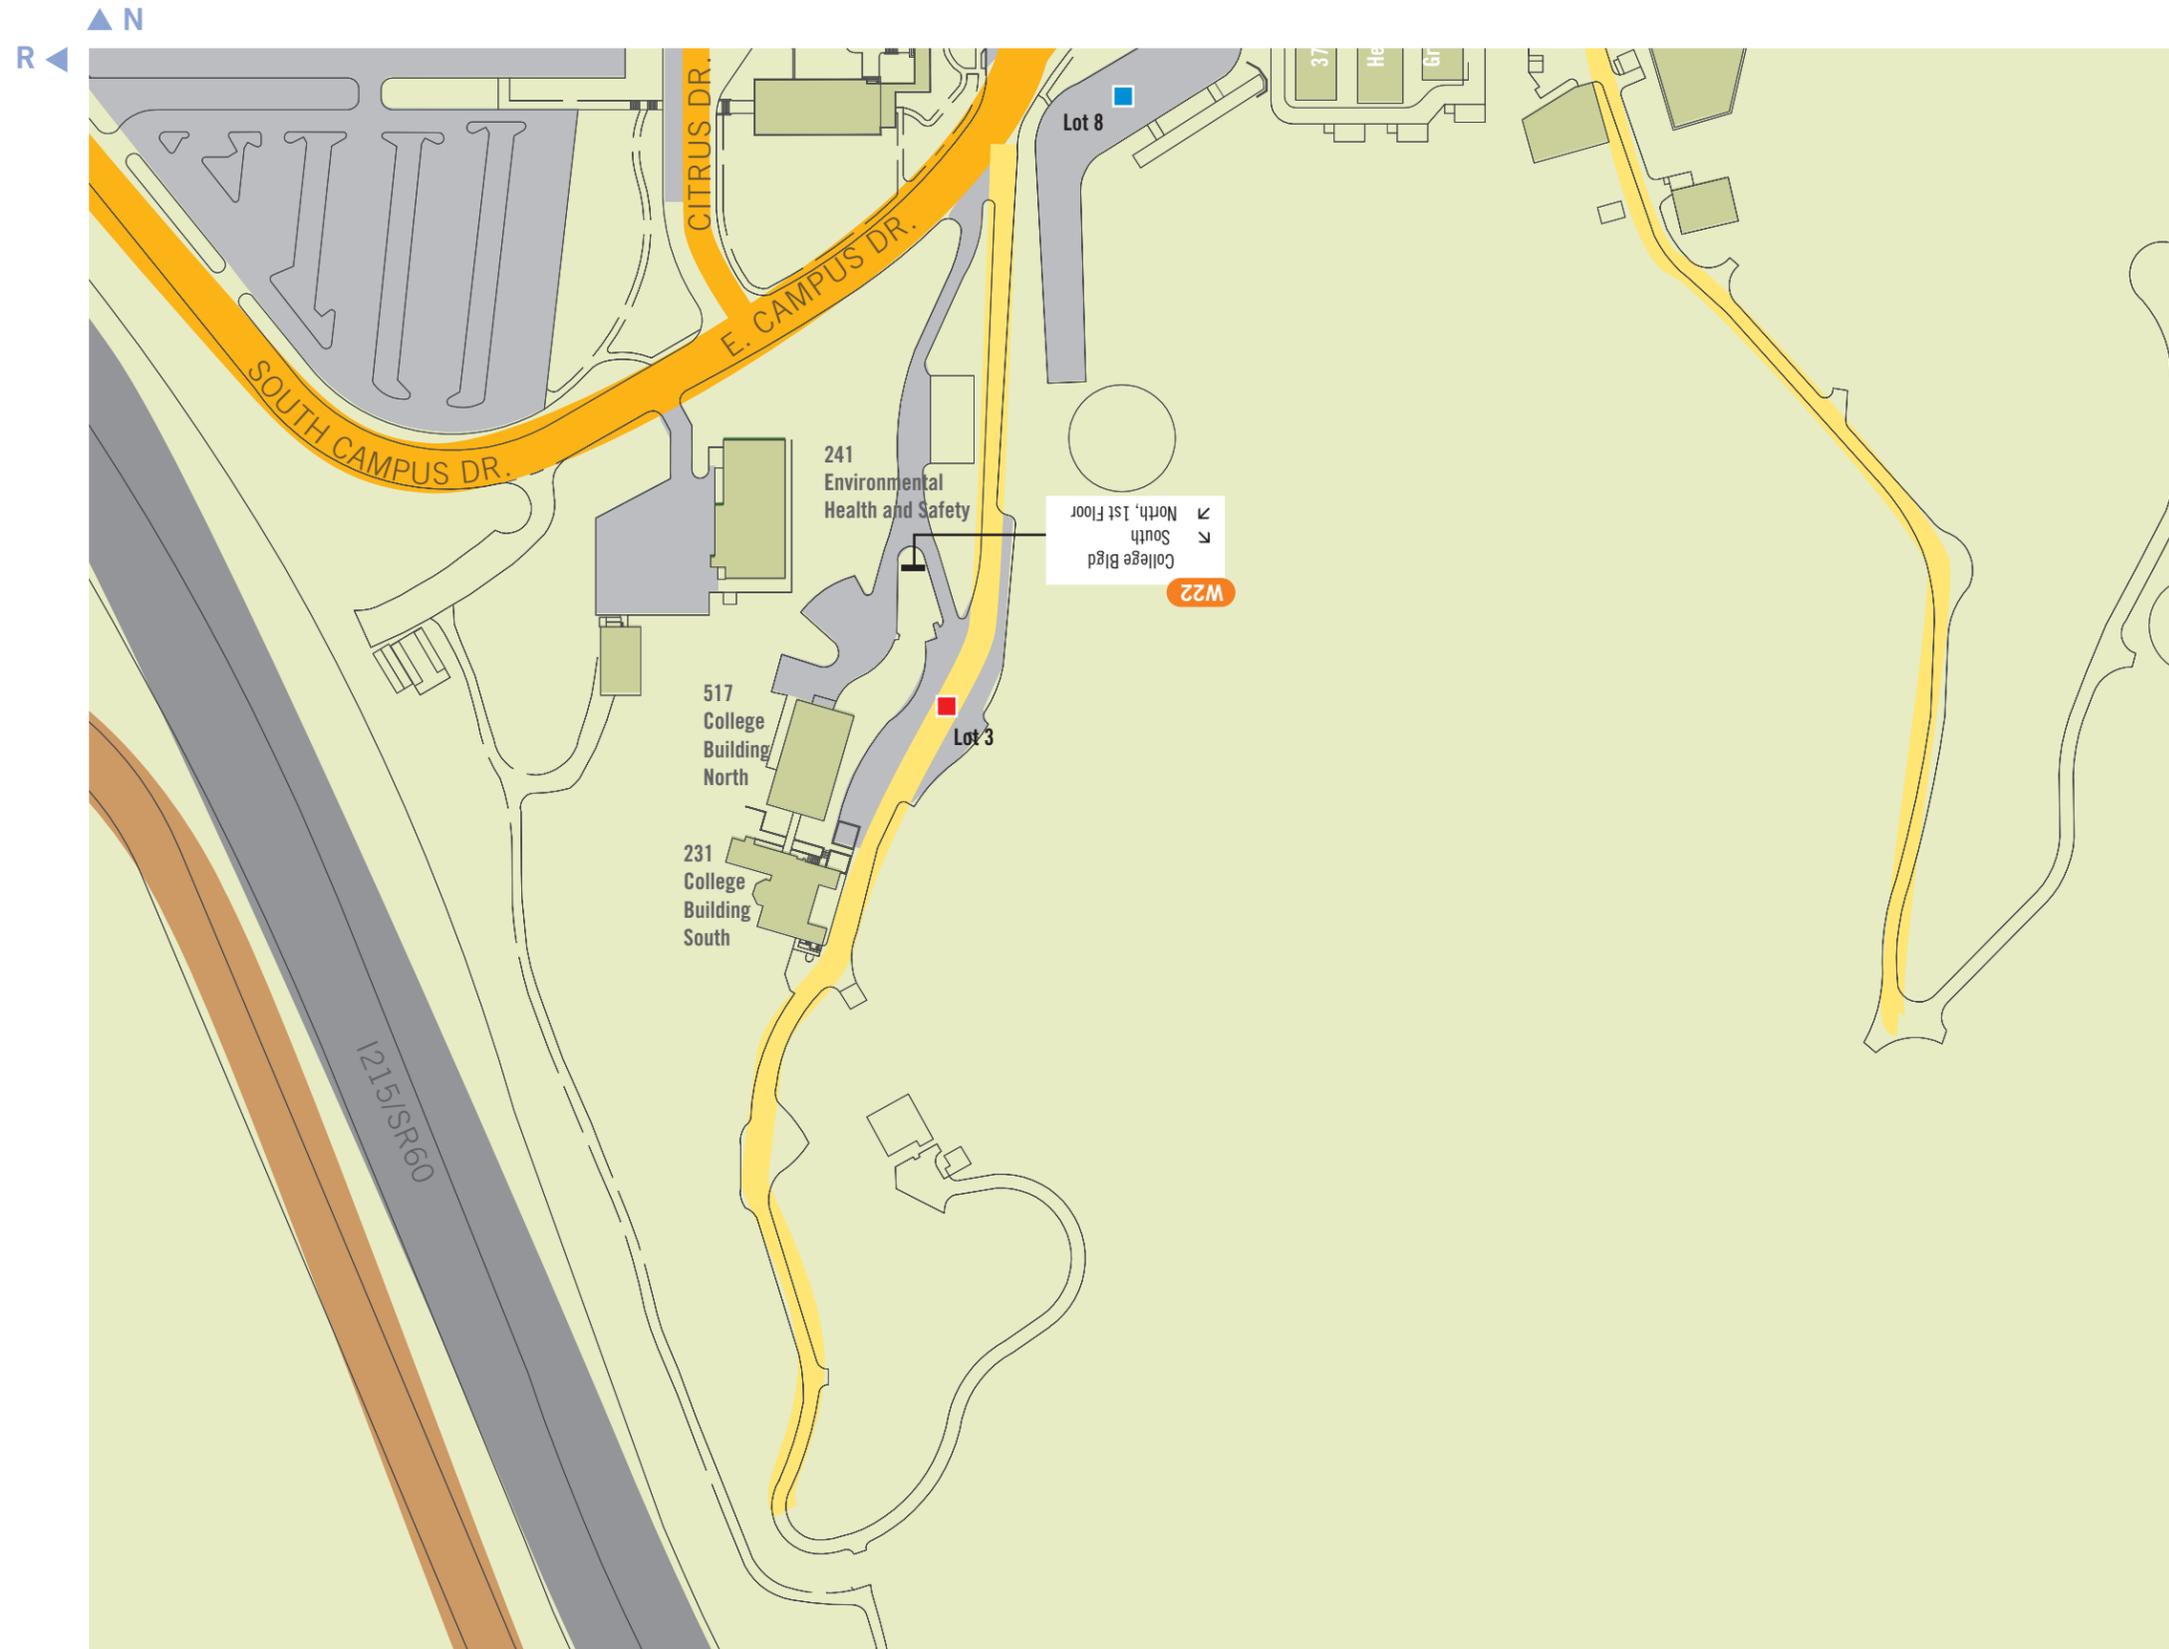

Vehicular Legend

- Off campus vehicular circulation
- On campus primary veh. circulation
- On campus secondary veh. circulation
- Parking Lot Permit Zones
- Information Kiosk

- Vehicular Directional**
- W20 Primary
- W21 Secondary
- W22 Pole Mounted

Note:
Lozenge orientation does not necessarily represent accurate sign placement.

Vehicular Destinations

Direct from Perimeter of Campus
Info Kiosk
Botanical Gardens
University Theater

Direct from 2-3 decision points away
Child Dev. Center
Corporation Yard
East Campus
Lothian Hall
Parking Lot 10
Parking Lot 13
Parking Lot 24
Parking Lot 30
Parking Services
Res. Halls
Sports Complex
Student Rec Center
Health Services
West Campus

Direct from 1 decision point away
Ag. Operations
Bannockburn
Biomedical Teaching Complex
Riviera Library Parking
USDA Lab

Location Plans and Messages

In order to provide clarity to the pedestrian sign type locations, the following plans only show Pedestrian Directional sign types.


Included are the following sign types:

W30

W35



▲ B
D ◀

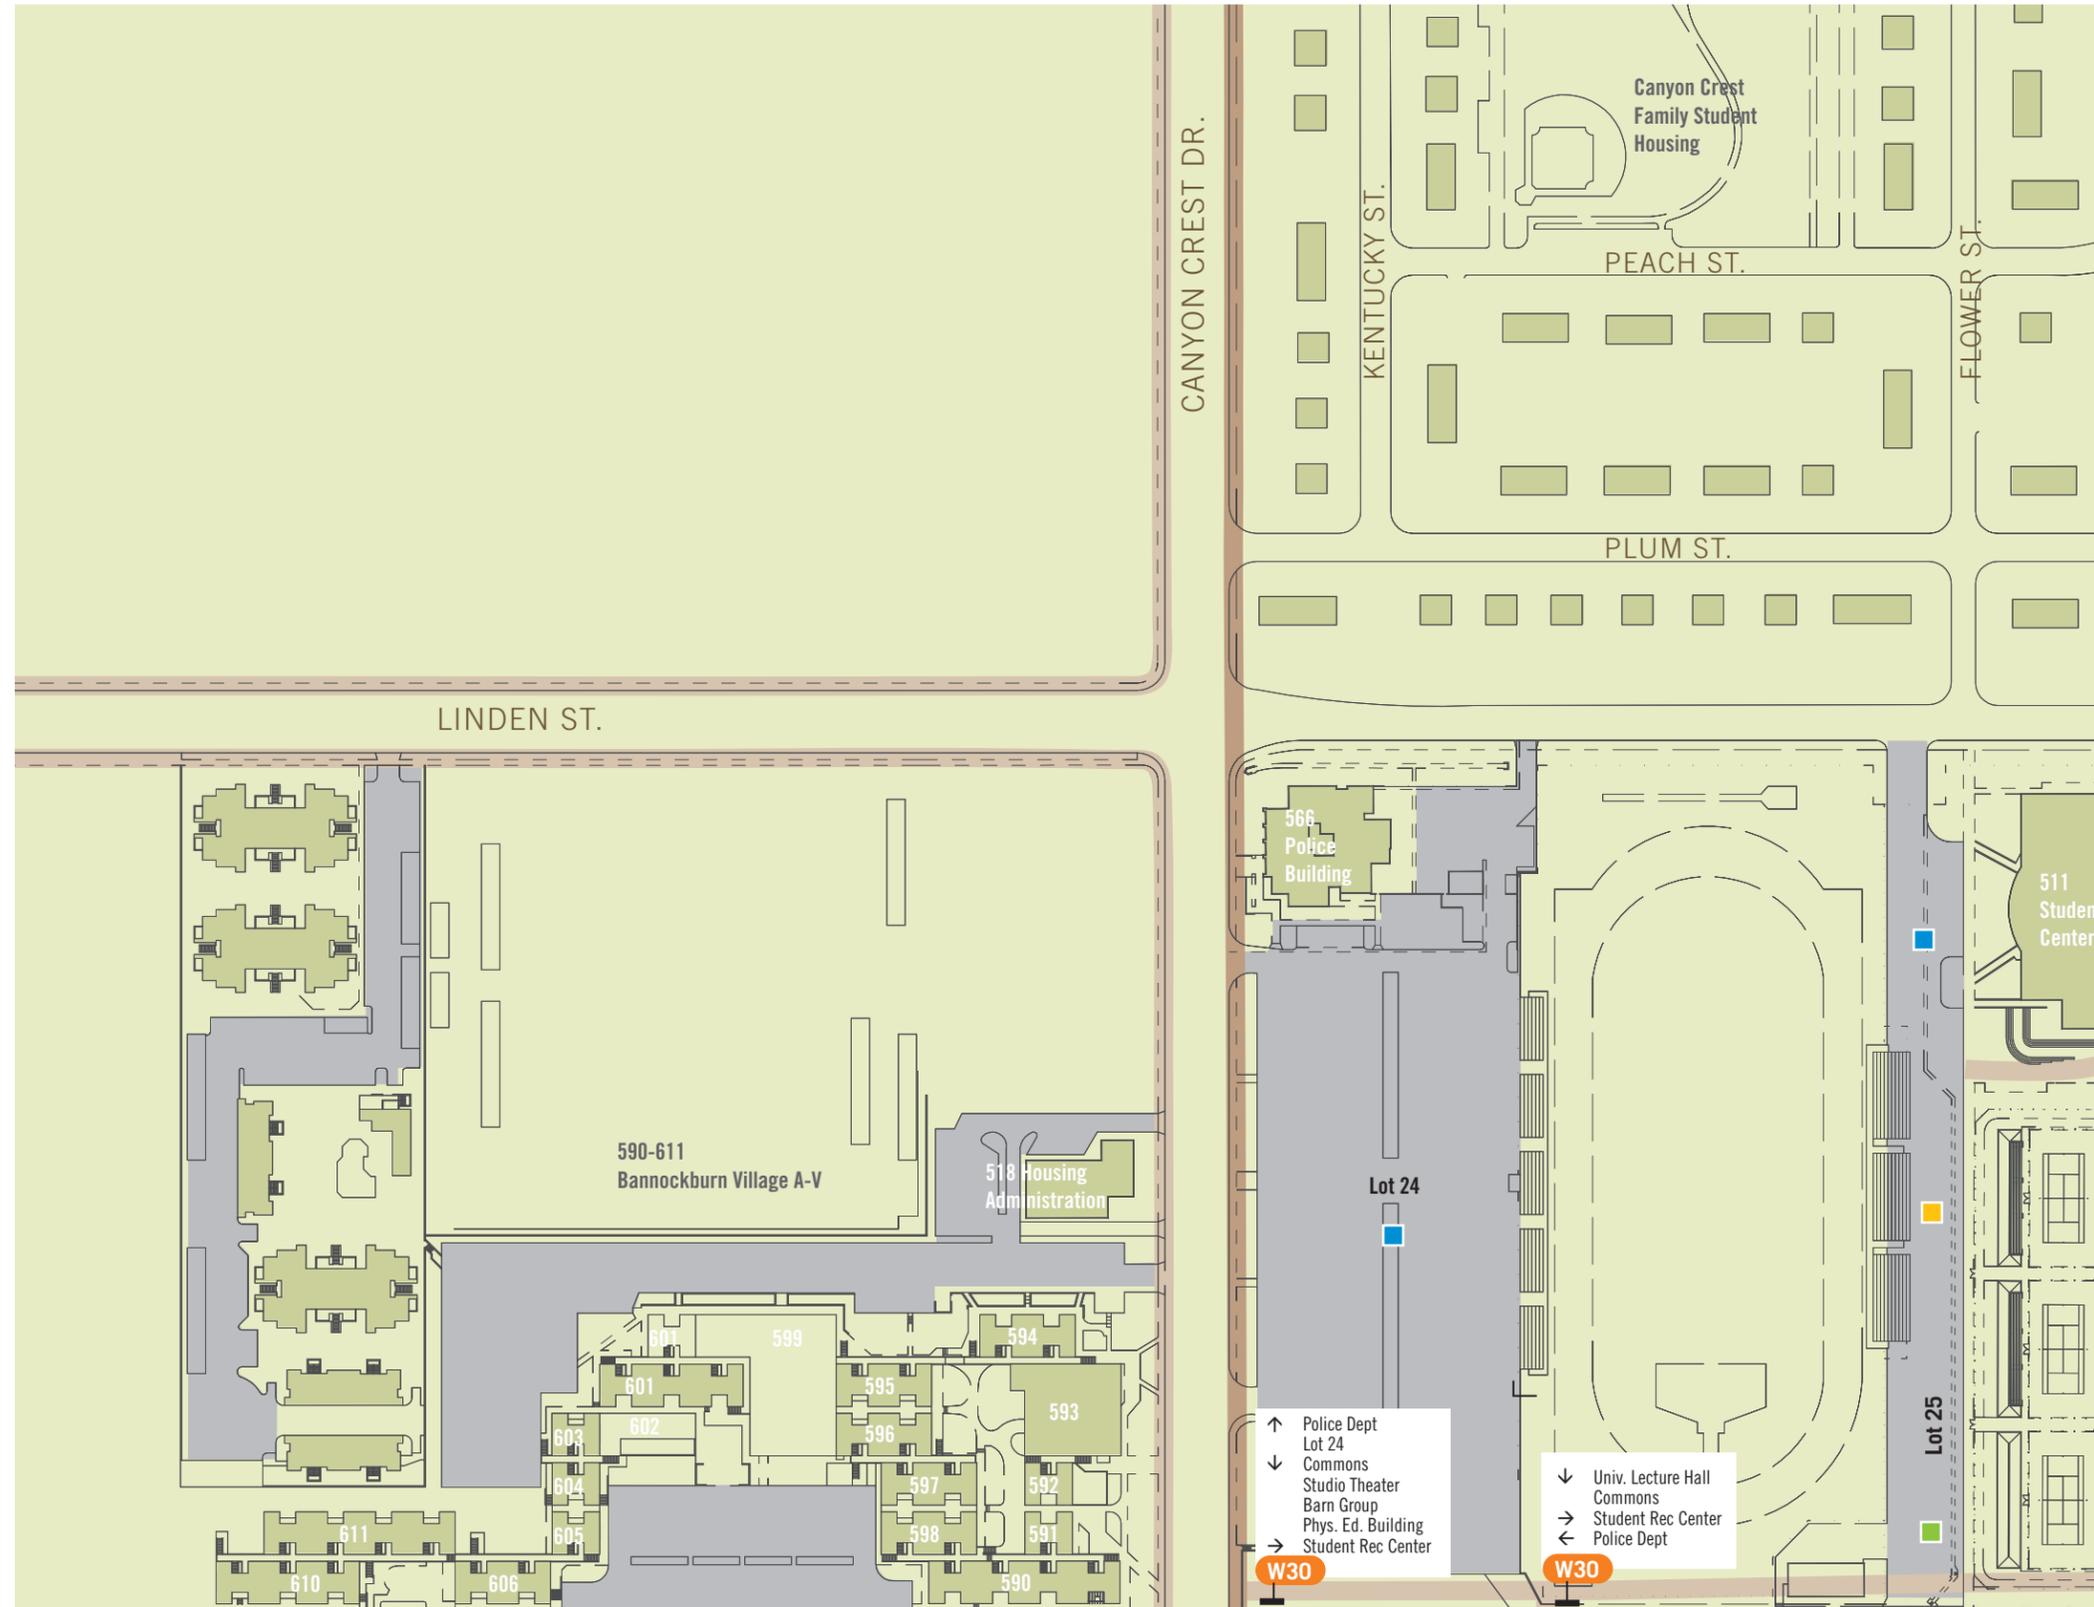

Pedestrian Legend

- Primary Pedestrian Circulation
- Secondary Pedestrian Circulation
- ★ Existing Directory (new directories to replace existing)
- ▲ Existing Postings
- ■ ■ ■ ■ Parking Lot Permit Zones

Pedestrian Directional

- W30 Blade Sign
- W35 Wall Mounted

Note:
Lozenge orientation does not necessarily represent accurate sign placement.

Pedestrian Destinations

Direct from Perimeter of Campus

- Commons
- Hinderacker Hall
- Humanities 1500
- Life Sciences 1500
- Physics 2000
- Univ. Lecture Hall
- Watkins 1000

Direct from Parking Lots

- Alumni Visitor Center
- Barn Group (Lots 1, 2, 24)
- P.E. Building (Lots 1, 24)
- Studio Theater (Lots 1, 2, 24)
- University Theater (Lot 30)

Direct from 2 - 3 decisions points away


- Bookstore
- College Bldg North and South
- Env. Health & Safety
- Extension/East Campus
- Lot 1, 2
- Lot 10, 13
- Lot 24
- Lot 30
- Police Dept.
- Student Recreation Center
- P.E. Building
- Health Services
- West Campus

- ↑ Police Dept
- ↓ Lot 24
- ↓ Commons
- ↓ Studio Theater
- ↓ Barn Group
- ↓ Phys. Ed. Building
- ↓ Student Rec Center
- ↓ Univ. Lecture Hall
- ↓ Commons
- Student Rec Center
- ← Police Dept

W30 W30

▶ F
I ▼

E C

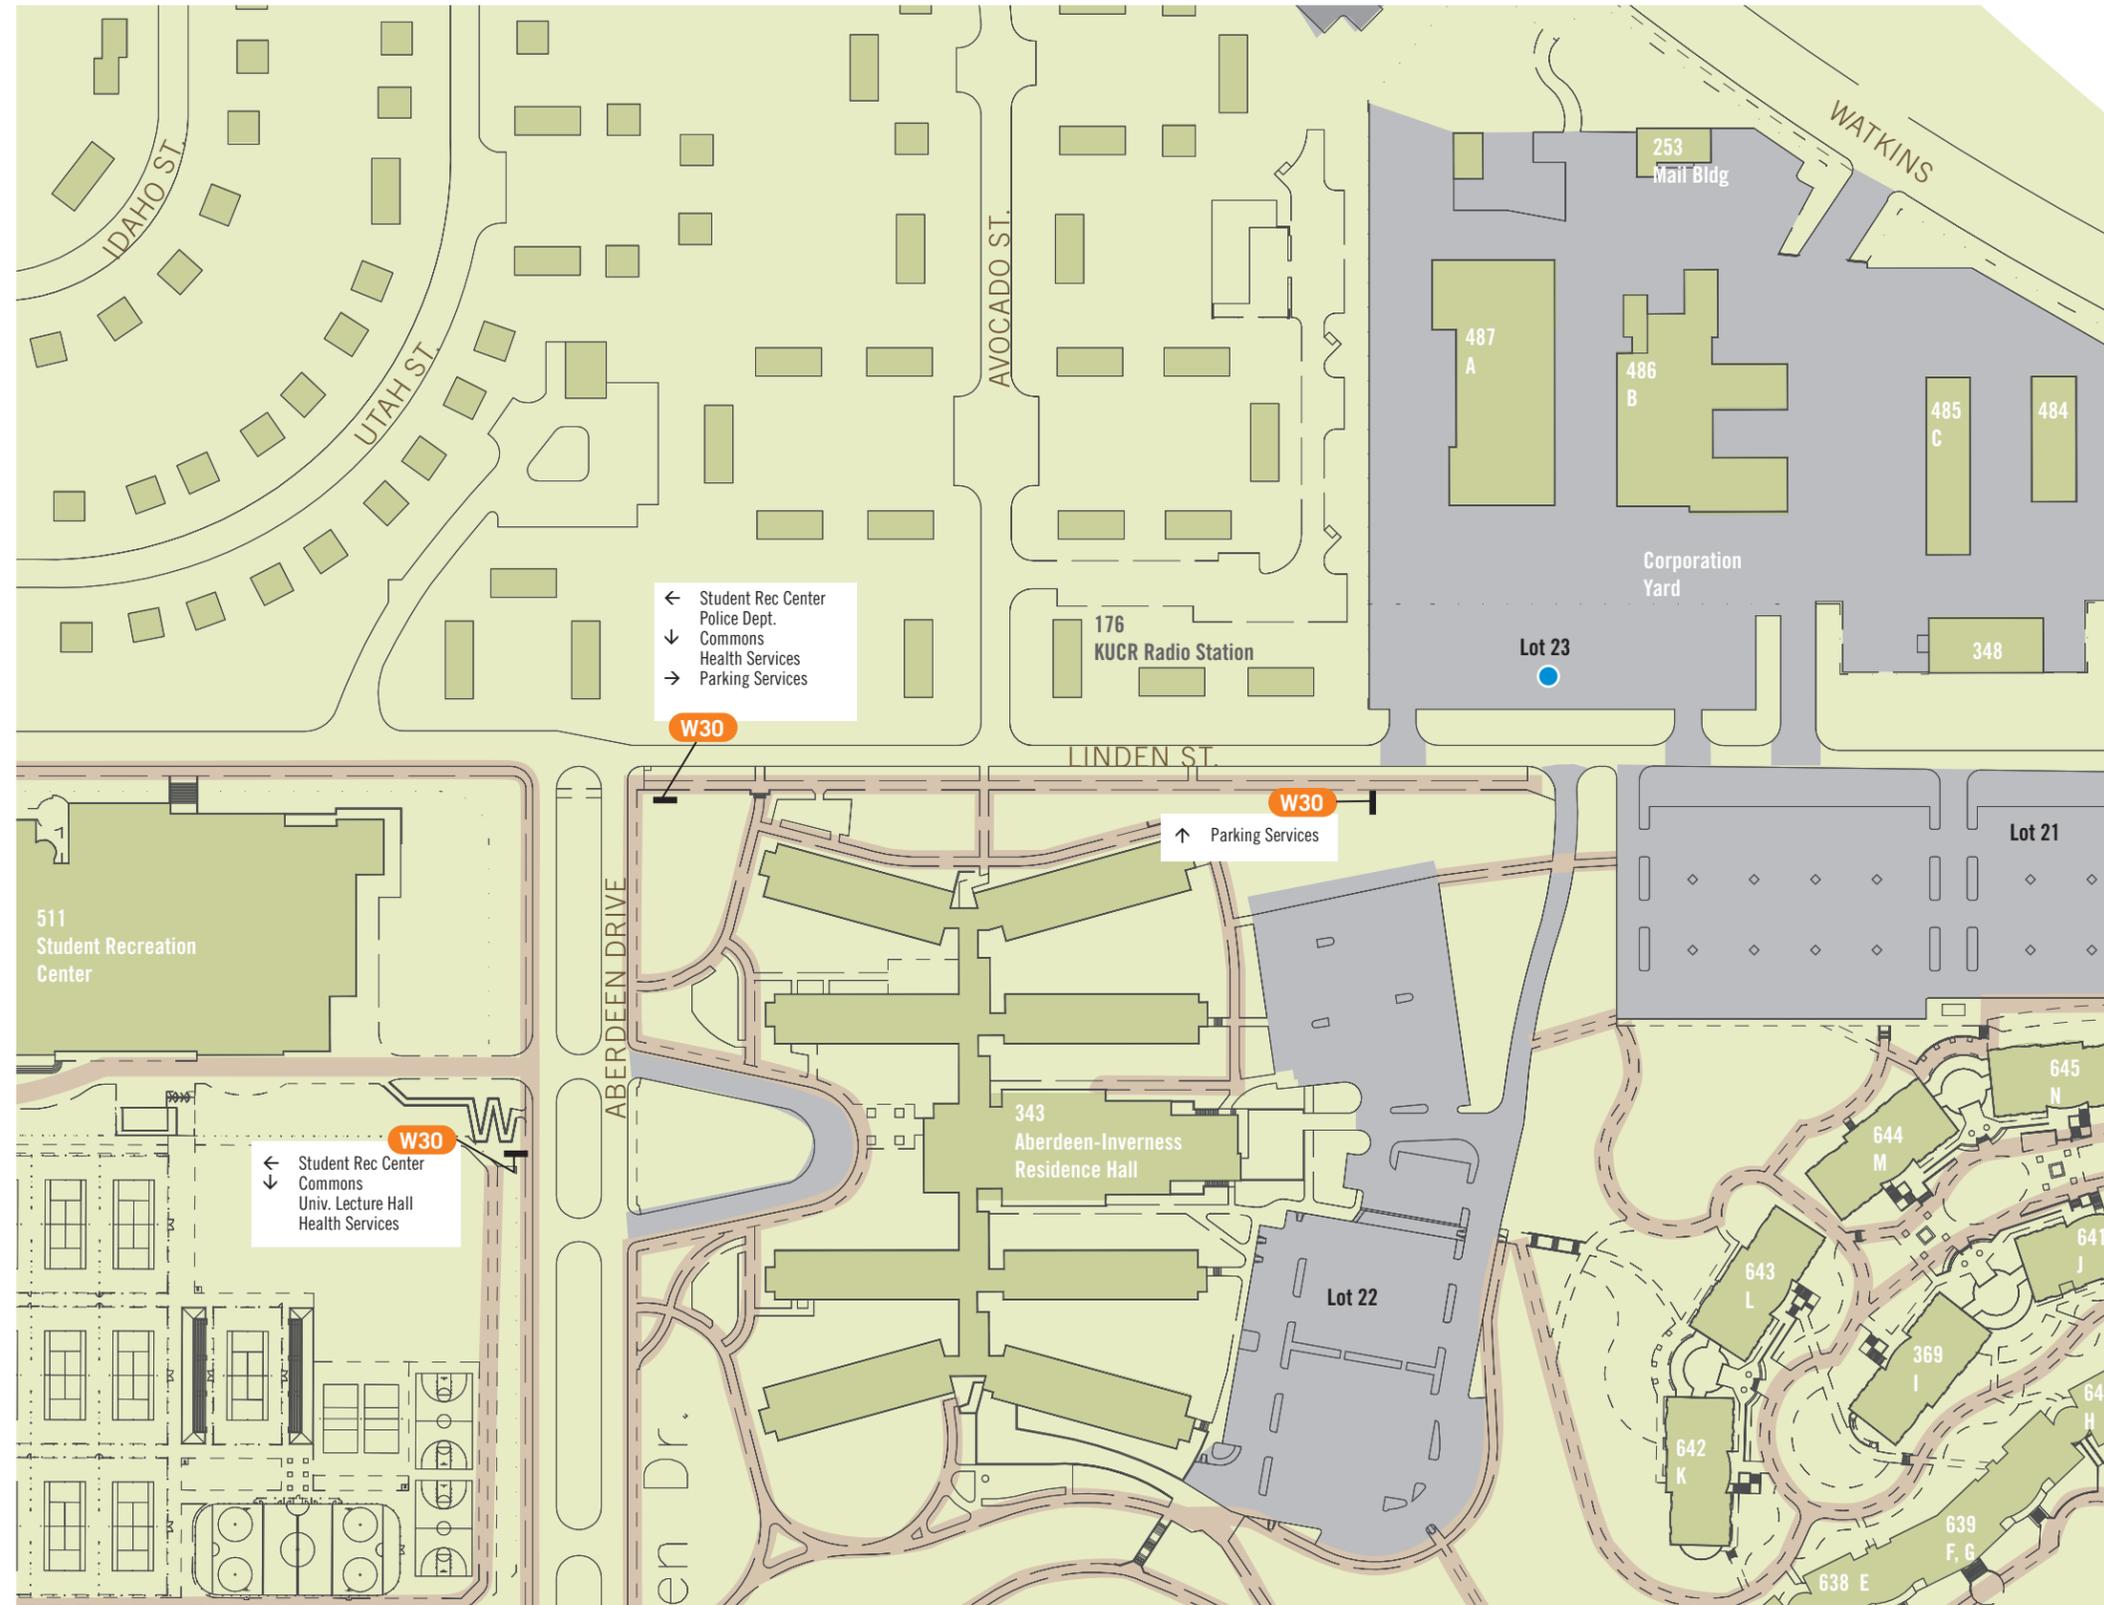

Pedestrian Legend

- Primary Pedestrian Circulation
- Secondary Pedestrian Circulation
- ★ Existing Directory (new directories to replace existing)
- ▲ Existing Postings
- ■ ■ ■ ■ Parking Lot Permit Zones

- Pedestrian Directional**
- W30 Blade Sign
- W35 Wall Mounted

Note:
Lozenge orientation does not necessarily represent accurate sign placement.

Pedestrian Destinations

Direct from Perimeter of Campus

- Commons
- Hinderacker Hall
- Humanities 1500
- Life Sciences 1500
- Physics 2000
- Univ. Lecture Hall
- Watkins 1000

Direct from Parking Lots


- Alumni Visitor Center
- Barn Group (Lots 1, 2, 24)
- P.E. Building (Lots 1, 24)
- Studio Theater (Lots 1, 2, 24)
- University Theater (Lot 30)

Direct from 2 - 3 decisions points away

- Bookstore
- College Bldg North and South
- Env. Health & Safety
- Extension/East Campus
- Lot 1, 2
- Lot 10, 13
- Lot 24
- Lot 30
- Police Dept.
- Student Recreation Center
- P.E. Building
- Health Services
- West Campus

J G

▲ D

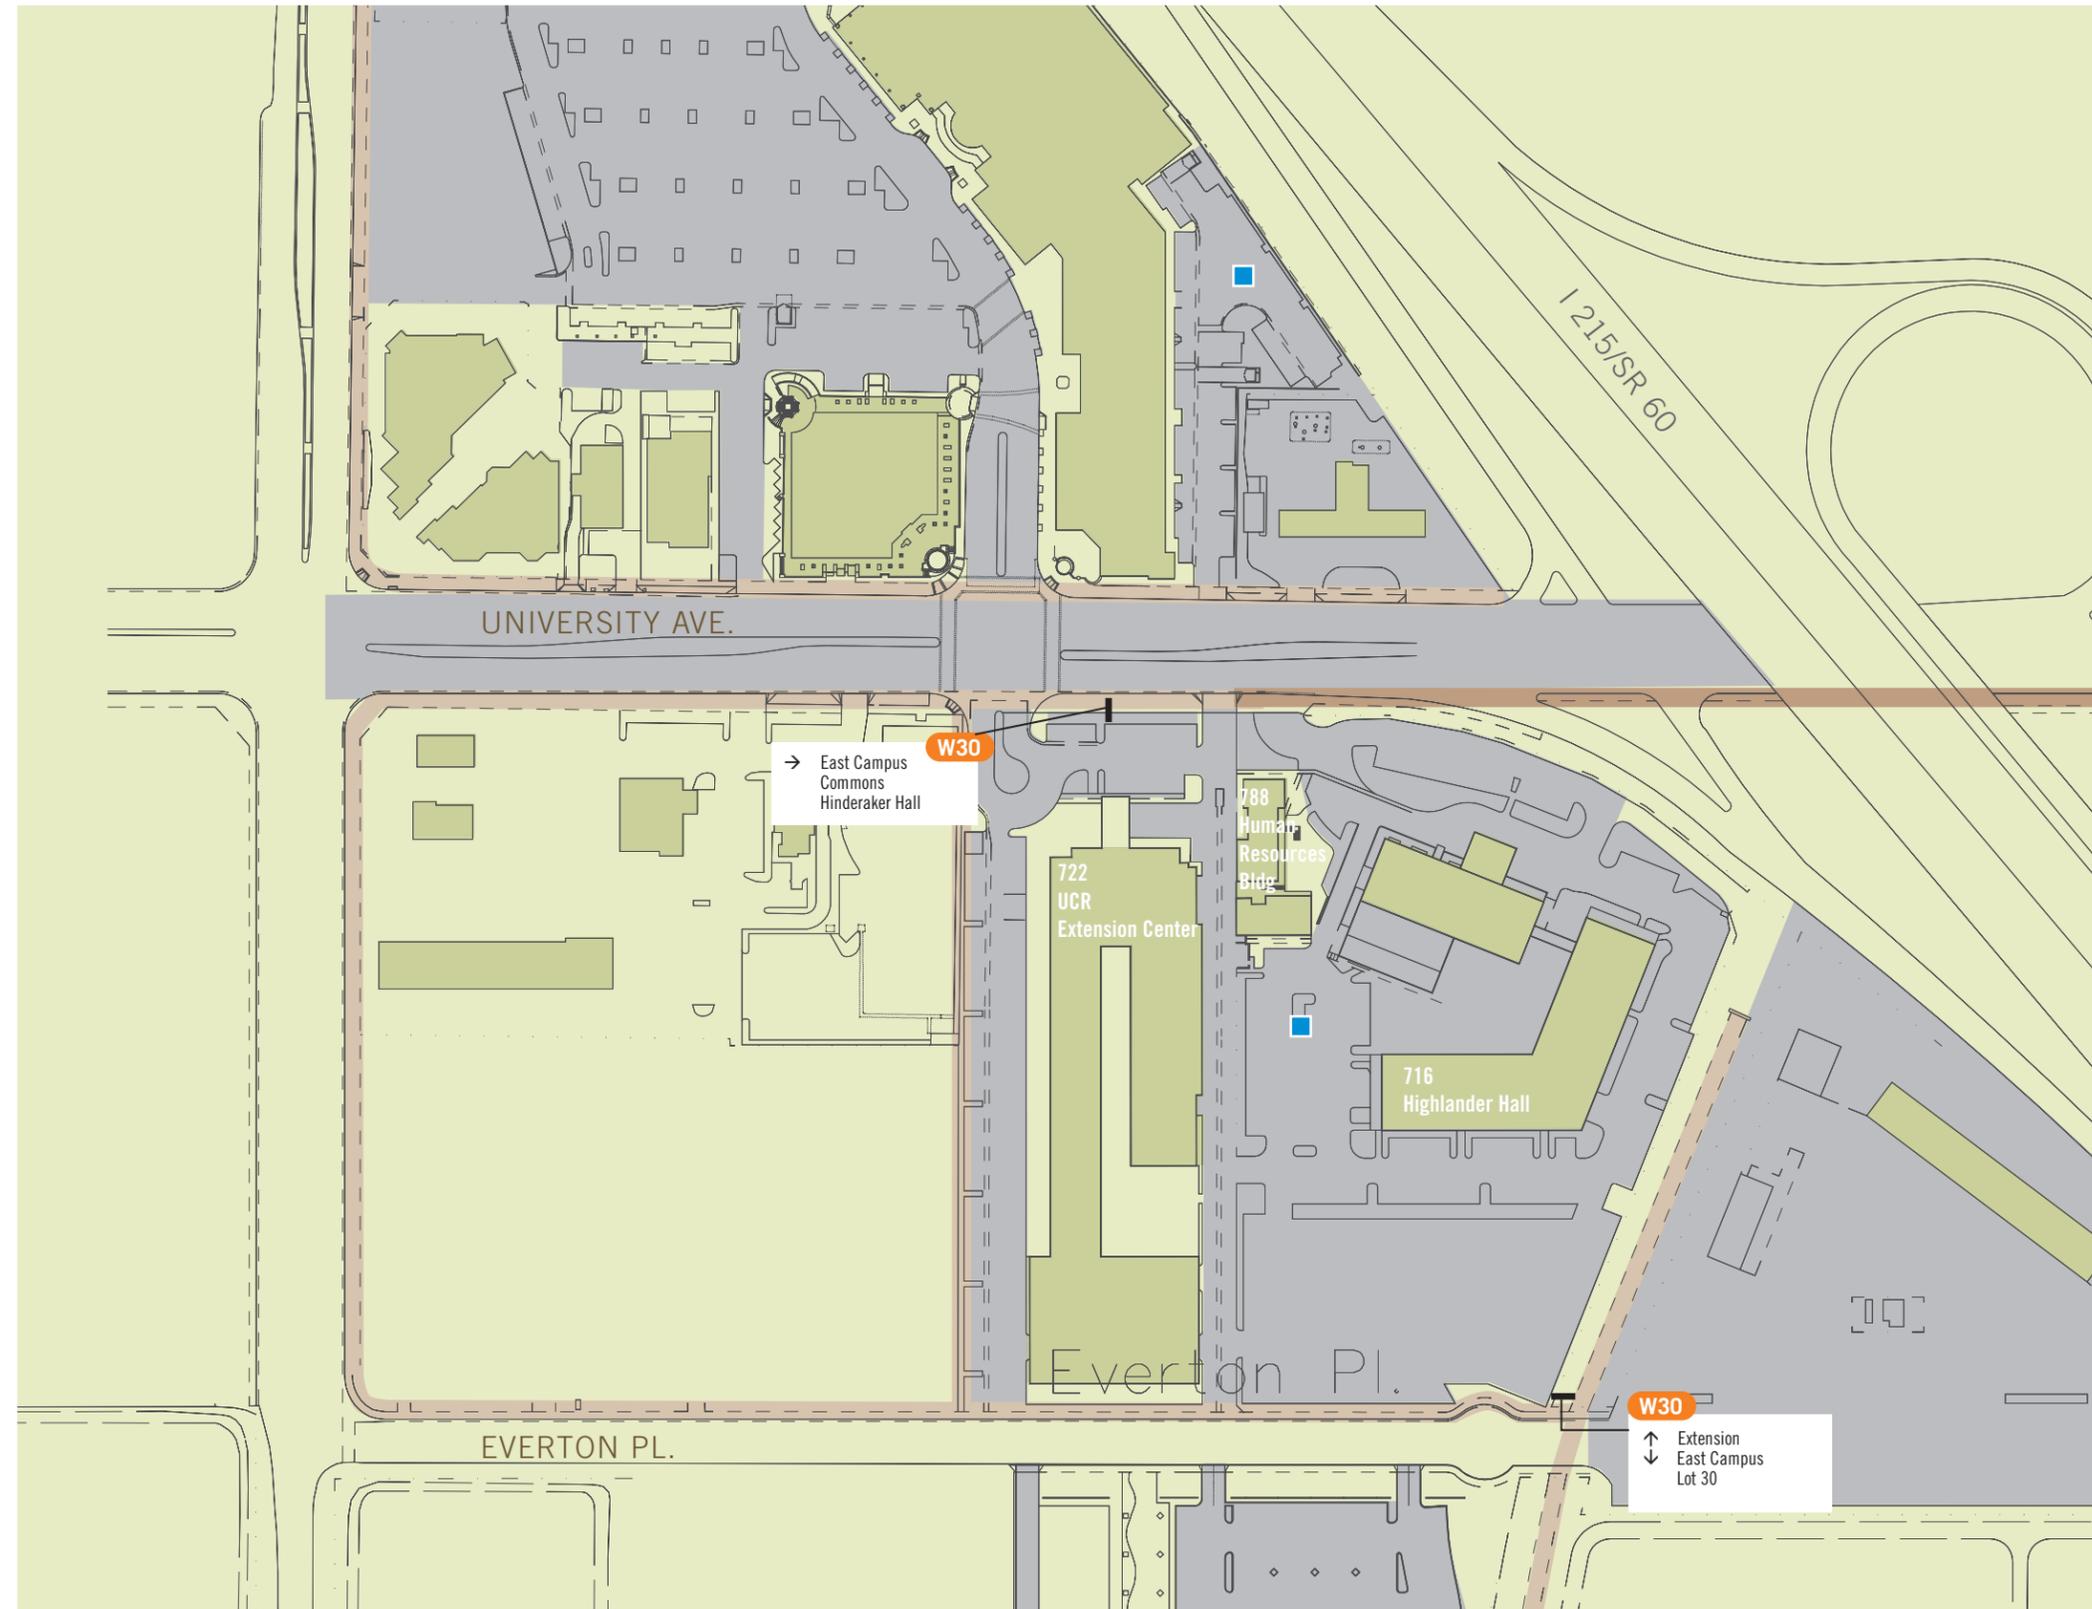

Pedestrian Legend

- Primary Pedestrian Circulation
- Secondary Pedestrian Circulation
- ★ Existing Directory (new directories to replace existing)
- ▲ Existing Postings
- ■ ■ ■ Parking Lot Permit Zones

Pedestrian Directional

- W30 Blade Sign
- W35 Wall Mounted

Note:
Lozenge orientation does not necessarily represent accurate sign placement.

Pedestrian Destinations

Direct from Perimeter of Campus

- Commons
- Hinderaker Hall
- Humanities 1500
- Life Sciences 1500
- Physics 2000
- Univ. Lecture Hall
- Watkins 1000

Direct from Parking Lots

- Alumni Visitor Center
- Barn Group (Lots 1, 2, 24)
- P.E. Building (Lots 1, 24)
- Studio Theater (Lots 1, 2, 24)
- University Theater (Lot 30)

Direct from 2 - 3 decisions points away

- Bookstore
- College Bldg North and South
- Env. Health & Safety
- Extension/East Campus
- Lot 1, 2
- Lot 10, 13
- Lot 24
- Lot 30
- Police Dept.
- Student Recreation Center
- P.E. Building
- Health Services
- West Campus

▶ I
L ▼

H ▲ E



Pedestrian Legend

- Primary Pedestrian Circulation
- Secondary Pedestrian Circulation
- Existing Directory (new directories to replace existing)
- Existing Postings
- Parking Lot Permit Zones
- Pedestrian Directional**
W30 Blade Sign
W35 Wall Mounted

Note:
Lozenge orientation does not necessarily represent accurate sign placement.

Pedestrian Destinations

Direct from Perimeter of Campus

- Commons
- Hinderaker Hall
- Humanities 1500
- Life Sciences 1500
- Physics 2000
- Univ. Lecture Hall
- Watkins 1000


Direct from Parking Lots

- Alumni Visitor Center
- Barn Group (Lots 1, 2, 24)
- P.E. Building (Lots 1, 24)
- Studio Theater (Lots 1, 2, 24)
- University Theater (Lot 30)

Direct from 2 - 3 decisions points away

- Bookstore
- College Bldg North and South
- Env. Health & Safety
- Extension/East Campus
- Lot 1, 2
- Lot 10, 13
- Lot 24
- Lot 30
- Police Dept.
- Student Recreation Center
- P.E. Building
- Health Services
- West Campus

▲ J
M ▼

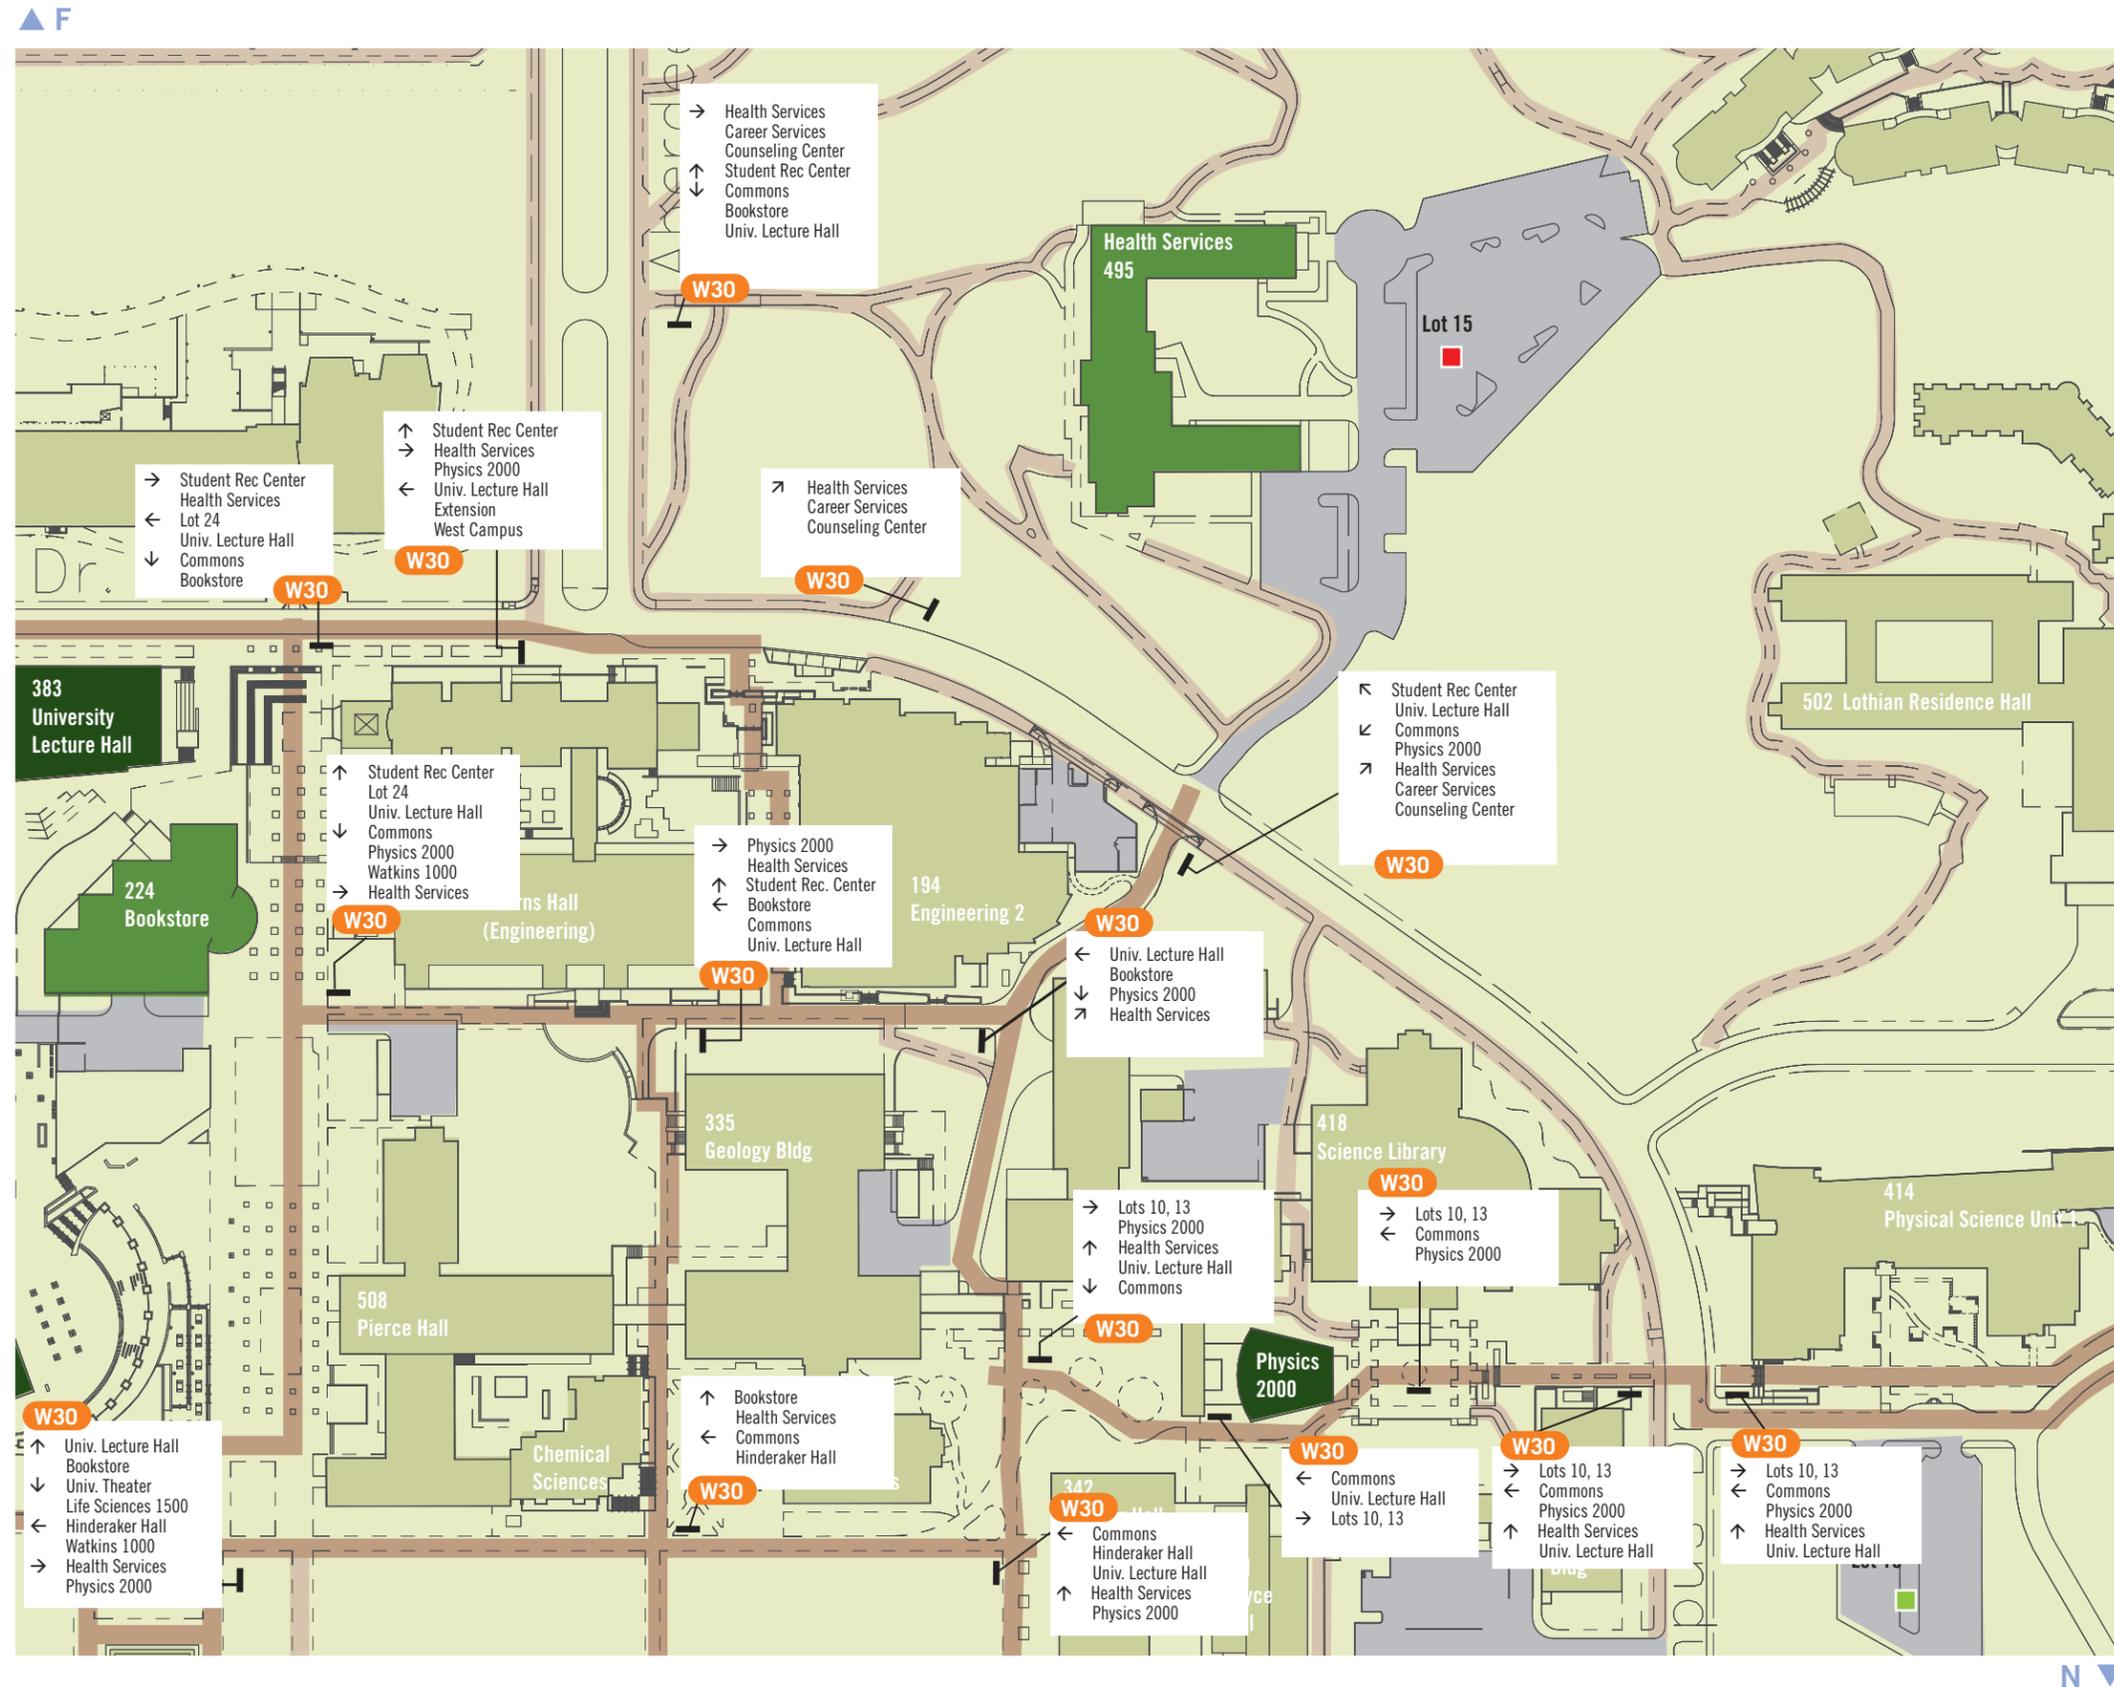

- Pedestrian Legend**
- Primary Pedestrian Circulation
 - Secondary Pedestrian Circulation
 - Existing Directory (new directories to replace existing)
 - Existing Postings
 - Parking Lot Permit Zones

- Pedestrian Directional**
- W30 Blade Sign
 - W35 Wall Mounted

Note:
Lozenge orientation does not necessarily represent accurate sign placement.

Pedestrian Destinations

Direct from Perimeter of Campus


- Commons
- Hinderaker Hall
- Humanities 1500
- Life Sciences 1500
- Physics 2000
- Univ. Lecture Hall
- Watkins 1000

Direct from Parking Lots

- Alumni Visitor Center
- Barn Group (Lots 1, 2, 24)
- P.E. Building (Lots 1, 24)
- Studio Theater (Lots 1, 2, 24)
- University Theater (Lot 30)

Direct from 2 - 3 decisions points away

- Bookstore
- College Bldg North and South
- Env. Health & Safety
- Extension/East Campus
- Lot 1, 2
- Lot 10, 13
- Lot 24
- Lot 30
- Police Dept.
- Student Recreation Center
- P.E. Building
- Health Services
- West Campus

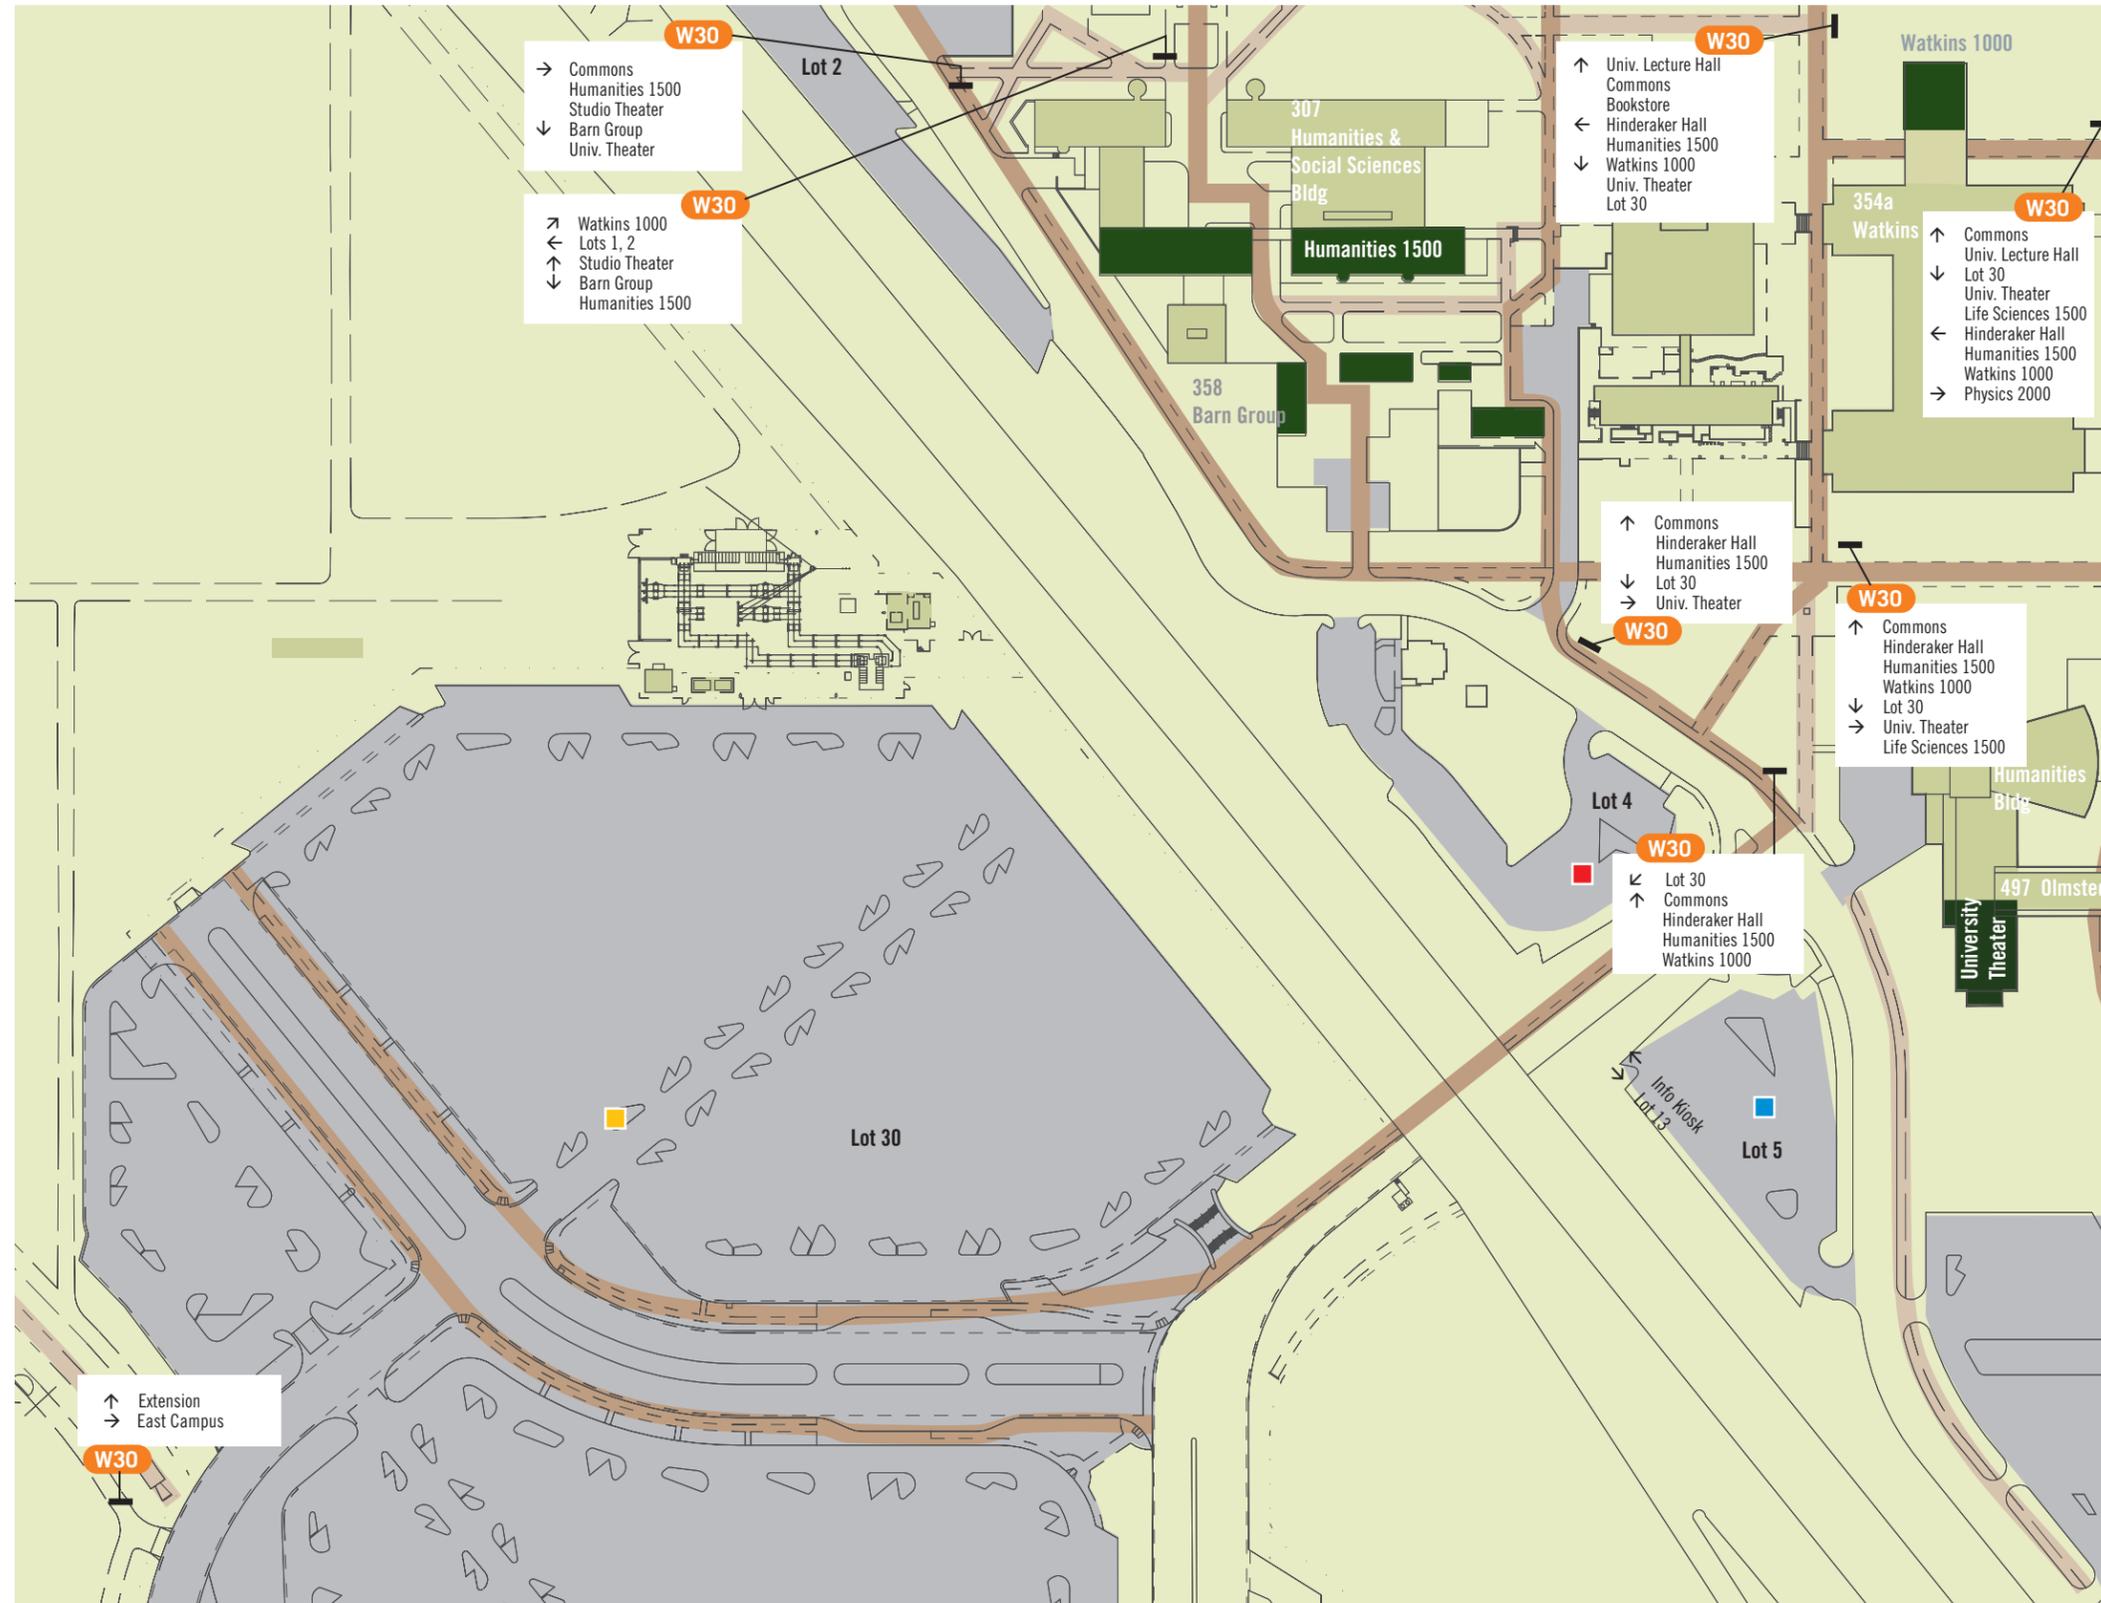

Pedestrian Legend

- Primary Pedestrian Circulation
- Secondary Pedestrian Circulation
- Existing Directory (new directories to replace existing)
- Existing Postings
- Parking Lot Permit Zones
- Pedestrian Directional**
 W30 Blade Sign
 W35 Wall Mounted

Note:
Lozenge orientation does not necessarily represent accurate sign placement.

Pedestrian Destinations

Direct from Perimeter of Campus

- Commons
- Hinderaker Hall
- Humanities 1500
- Life Sciences 1500
- Physics 2000
- Univ. Lecture Hall
- Watkins 1000

Direct from Parking Lots

- Alumni Visitor Center
- Barn Group (Lots 1, 2, 24)
- P.E. Building (Lots 1, 24)
- Studio Theater (Lots 1, 2, 24)
- University Theater (Lot 30)

Direct from 2 - 3 decisions points away

- Bookstore
- College Bldg North and South
- Env. Health & Safety
- Extension/East Campus
- Lot 1, 2
- Lot 10, 13
- Lot 24
- Lot 30
- Police Dept.
- Student Recreation Center
- P.E. Building
- Health Services
- West Campus



W30
 ↑ Commons
 ↑ Life Sciences 1500
 ↓ Env. Health & Safety
 → College Bldg
 North & South

Pedestrian Legend

- Primary Pedestrian Circulation
- Secondary Pedestrian Circulation
- ★ Existing Directory (new directories to replace existing)
- ▲ Existing Postings
- ■ ■ ■ Parking Lot Permit Zones

Pedestrian Directional

- W30 Blade Sign
- W35 Wall Mounted

Note:
 Lozenge orientation does not necessarily represent accurate sign placement.

Pedestrian Destinations

- Direct from Perimeter of Campus**
- Commons
 - Hinderacker Hall
 - Humanities 1500
 - Life Sciences 1500
 - Physics 2000
 - Univ. Lecture Hall
 - Watkins 1000

- Direct from Parking Lots**
- Alumni Visitor Center
 - Barn Group (Lots 1, 2, 24)
 - P.E. Building (Lots 1, 24)
 - Studio Theater (Lots 1, 2, 24)
 - University Theater (Lot 30)

- Direct from 2 - 3 decisions points away**
- Bookstore
 - College Bldg North and South
 - Env. Health & Safety
 - Extension/East Campus
 - Lot 1, 2
 - Lot 10, 13
 - Lot 24
 - Lot 30
 - Police Dept.
 - Student Recreation Center
 - P.E. Building
 - Health Services
 - West Campus


| Aberdeen Inverness (343) | | qty |
|--------------------------|-----------------------|-----|
| W50 | Vehicular Bldg ID | 1 |
| W51 | Freestanding, Ped | 0 |
| W52 | Wall Mounted | 0 |
| W53 | Vinyl Letters on Door | 0 |
| W54 | Parapet Letters | 0 |
| B95 | Loading Dock ID | 0 |




Keep existing sign



Replace with W50 Vehicular Bldg ID

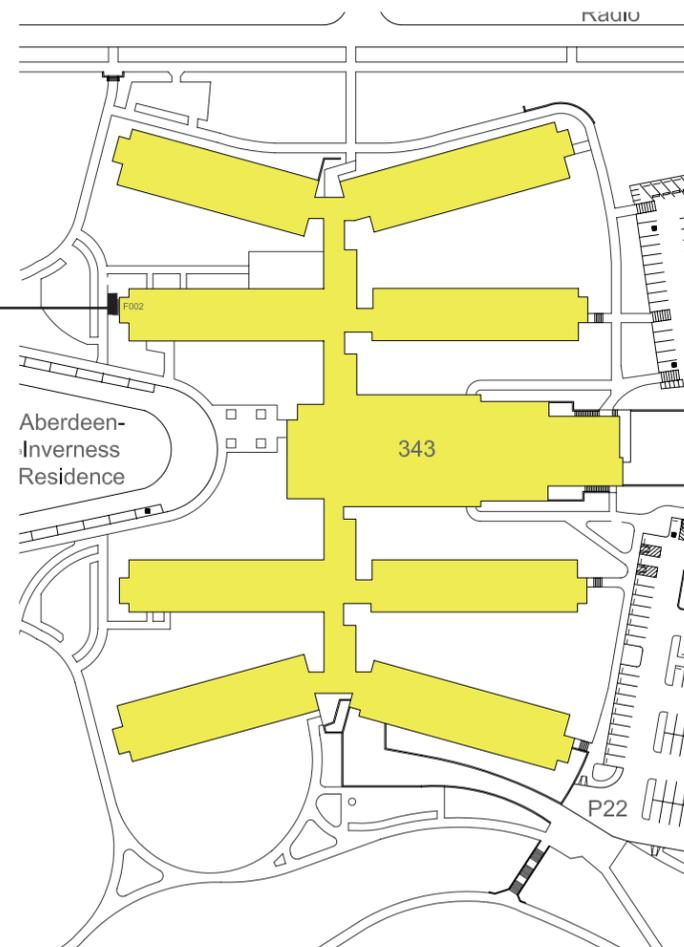

| Agricultural Operations | | qty |
|-------------------------|-----------------------|-----|
| W50 | Vehicular Bldg ID | 1 |
| W51 | Freestanding, Ped | 0 |
| W52 | Wall Mounted | 0 |
| W53 | Vinyl Letters on Door | 0 |
| W54 | Parapet Letters | 0 |
| B95 | Loading Dock ID | 0 |

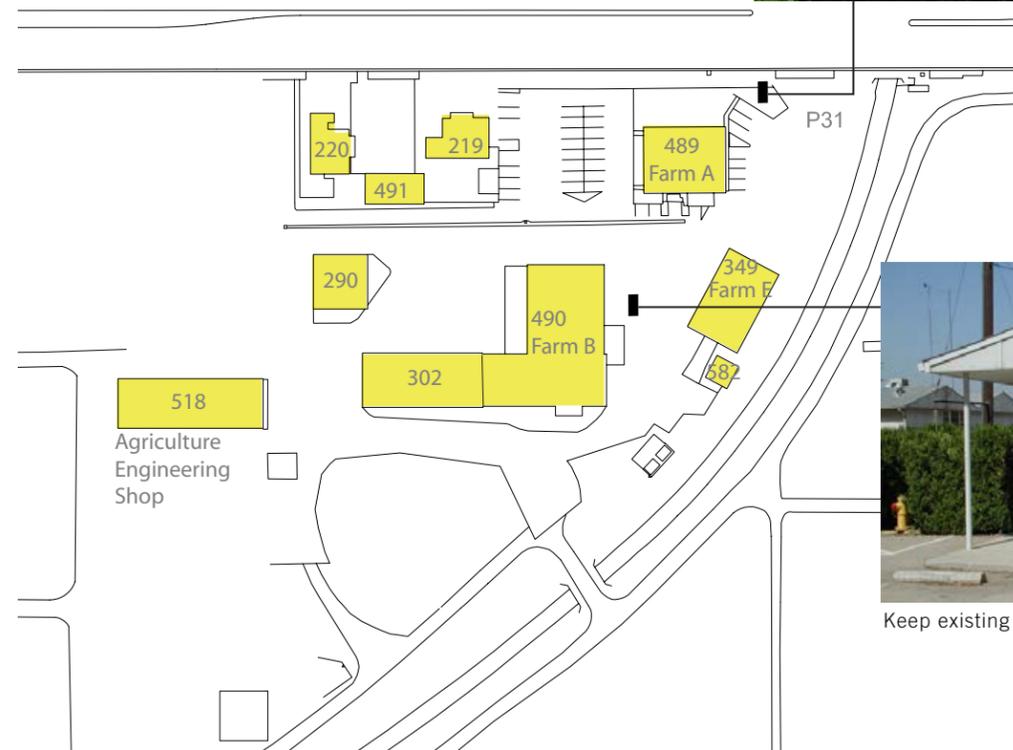


Replace with W50 Vehicular Bldg ID



Keep existing sign

| Anderson Hall I & II (325 & 357) | | qty |
|----------------------------------|-----------------------|-----|
| W50 | Vehicular Bldg ID | 0 |
| W51 | Freestanding, Ped | 1 |
| W52 | Wall Mounted | 0 |
| W53 | Vinyl Letters on Door | 4 |
| W54 | Parapet Letters | 0 |
| B95 | Loading Dock ID | 0 |

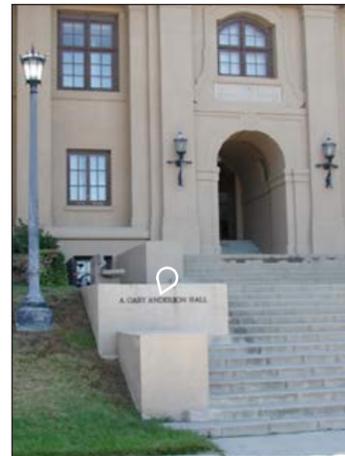

Keep existing sign




Add W51 Freestanding Bldg ID



Add W53 Vinyl Letters on Door



Keep existing sign

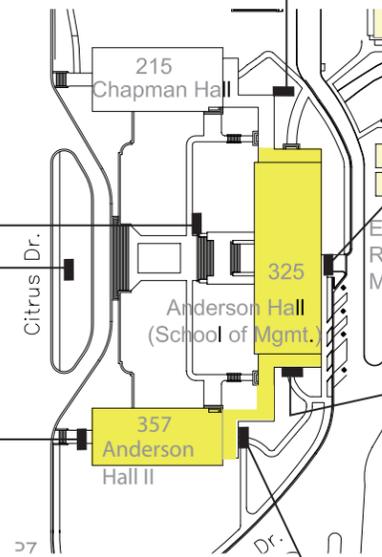

Add W53 Vinyl Letters on Door




Add W53 Vinyl Letters on Door



Add W53 Vinyl Letters on Door

| Arts (411) | | qty |
|------------|-----------------------|-----|
| W50 | Vehicular Bldg ID | 0 |
| W51 | Freestanding, Ped | 1 |
| W52 | Wall Mounted | 0 |
| W53 | Vinyl Letters on Door | 0 |
| W54 | Parapet Letters | 2 |
| B95 | Loading Dock ID | 1 |

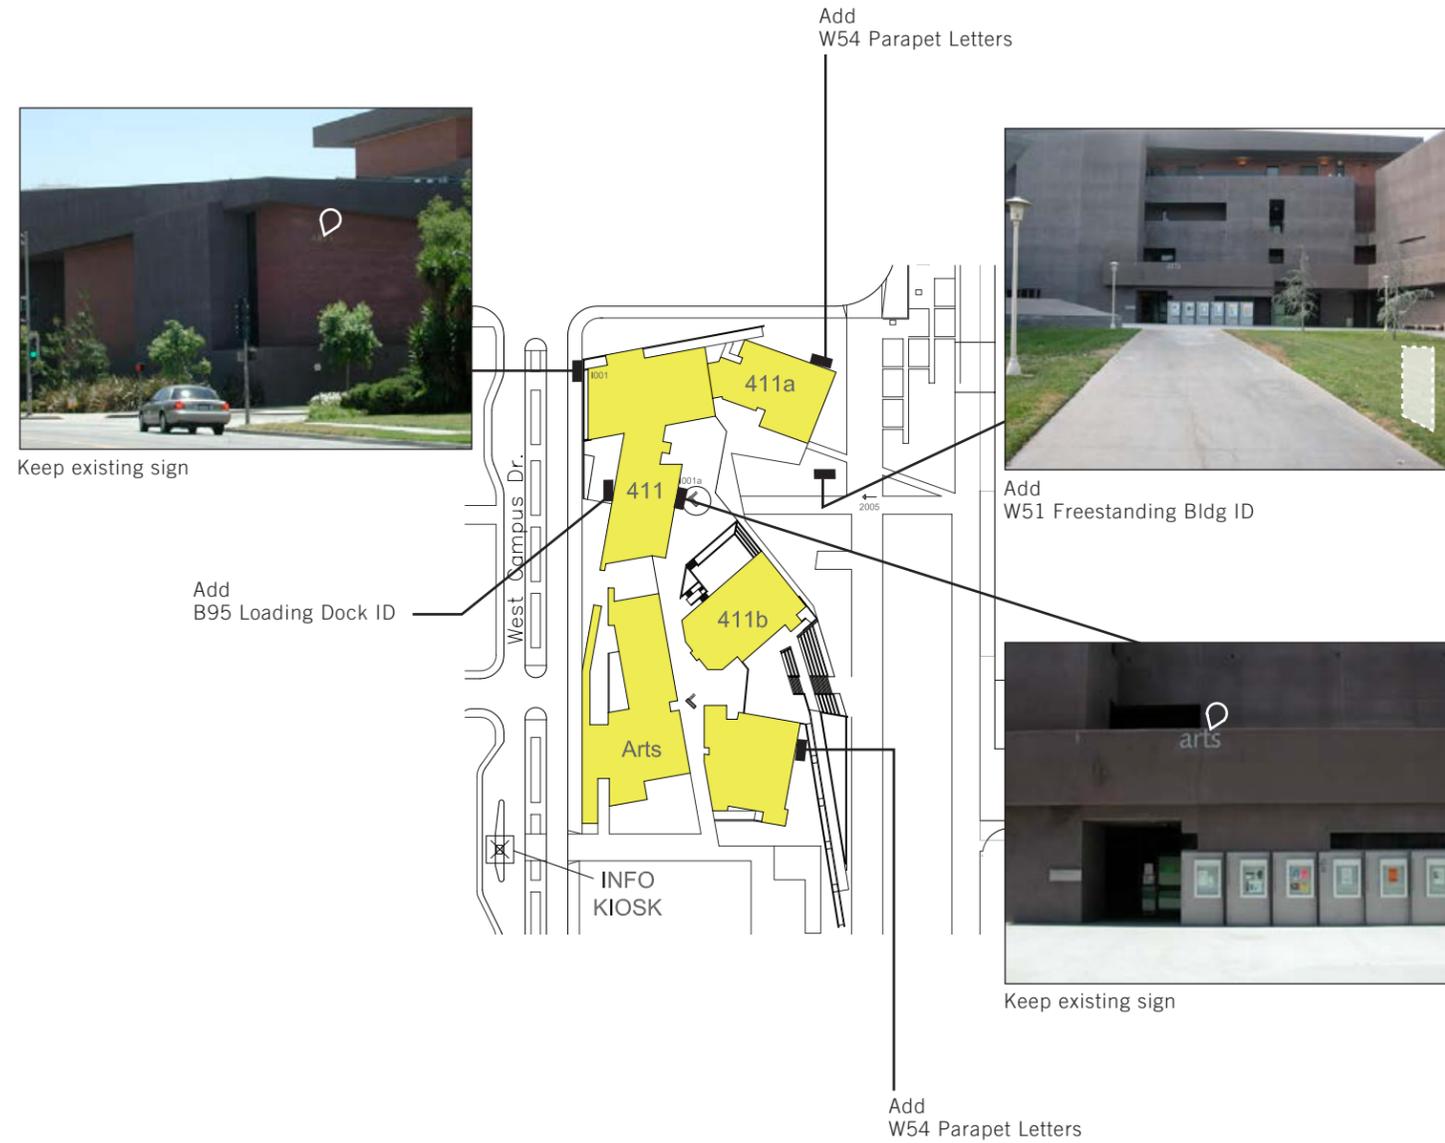

The Barn, Theater Workshop & Barn Stable (358, 251, & 271)

| | qty |
|---------------------------|-----|
| W50 Vehicular Bldg ID | 1 |
| W51 Freestanding, Ped | 1 |
| W52 Wall Mounted | 6 |
| W53 Vinyl Letters on Door | 0 |
| W54 Parapet Letters | 0 |
| B95 Loading Dock ID | 0 |



Add W52 Wall Mounted Bldg ID




Replace with W52 Wall Mounted Bldg ID



Add W51 Freestanding Bldg ID



Add W52 Wall Mounted Bldg ID

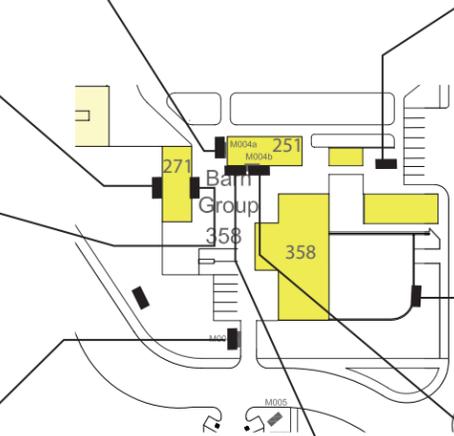

Add W52 Wall Mounted Bldg ID



Replace with W50 Vehicular Bldg ID



Add W52 Wall Mounted Bldg ID



Replace with W52 Wall Mounted Bldg ID

| Batchelor Hall (501) | | qty |
|----------------------|-----------------------|-----|
| W50 | Vehicular Bldg ID | 1 |
| W51 | Freestanding, Ped | 2 |
| W52 | Wall Mounted | 2 |
| W53 | Vinyl Letters on Door | 5 |
| W54 | Parapet Letters | 0 |
| B95 | Loading Dock ID | 1 |




Replace existing sign with W52 Wall Mounted
Add W53 Vinyl Letters on Door



Add W51 Freestanding Building ID

Add W53 Vinyl Letters on Door

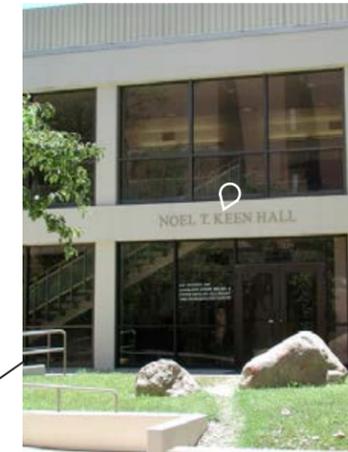


Keep existing sign
Add W53 Vinyl Letters on Door



Keep existing sign
Add B95 Loading Dock



Keep existing sign

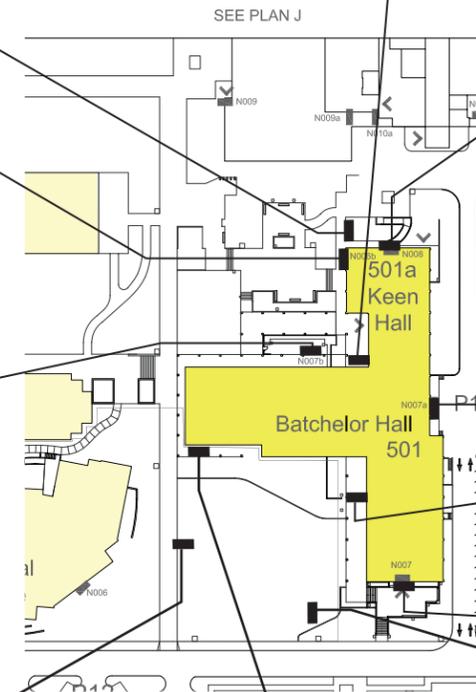

Add W53 Vinyl Letters on Door

Add W51 Freestanding Building ID



Add W52 Wall Mounted Bldg ID
W53 Vinyl Letters on Door



Add W50 Vehicular Building ID



Keep existing sign

| Biological Sciences (186) | | qty |
|---------------------------|-----------------------|-----|
| W50 | Vehicular Bldg ID | 0 |
| W51 | Freestanding, Ped | 1 |
| W52 | Wall Mounted | 1 |
| W53 | Vinyl Letters on Door | 3 |
| W54 | Parapet Letters | 0 |
| B95 | Loading Dock ID | 0 |



Add W53 Vinyl Letters on Door



Add W53 Vinyl Letters on Door




Add W52 Wall Mounted Building ID



Add W53 Vinyl Letters on Door



Keep existing sign

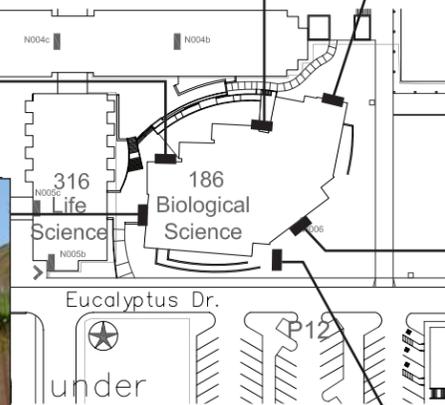

Keep existing sign

Add W50 Vehicular Bldg ID


| Biomed Teaching Center (385) | | qty |
|------------------------------|-----------------------|-----|
| W50 | Vehicular Bldg ID | 1 |
| W51 | Freestanding, Ped | 0 |
| W52 | Wall Mounted | 3 |
| W53 | Vinyl Letters on Door | 0 |
| W54 | Parapet Letters | 0 |
| W55 | Building ID, small | 1 |
| B95 | Loading Dock ID | 0 |



Replace with W52 Wall Mounted Bldg ID



Replace with W52 Wall Mounted Bldg ID

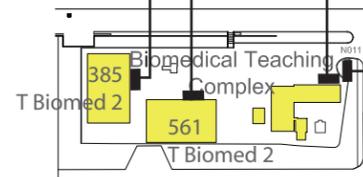

Add W55 Building ID, small



Add W52 Wall Mounted Bldg ID



Replace with W50 Vehicular Bldg ID

| Bookstore (224) | | qty |
|-----------------|-----------------------|-----|
| W50 | Vehicular Bldg ID | 0 |
| W51 | Freestanding, Ped | 0 |
| W52 | Wall Mounted | 2 |
| W53 | Vinyl Letters on Door | 1 |
| W54 | Parapet Letters | 2 |
| B95 | Loading Dock ID | 1 |




Keep Existing Sign

Add
W54 Parapet Letters



Add
W54 Parapet Letters

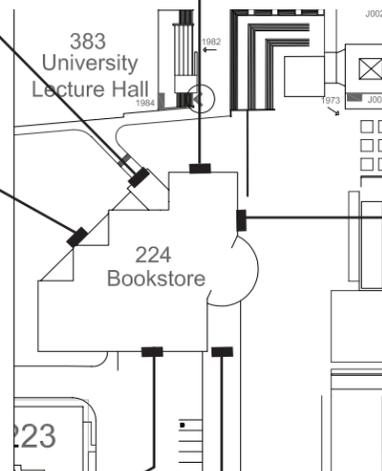

Add
W52 Wall Mounted Bldg ID



Add
W53 Vinyl Letters on Doors




Add
B95 Loading Dock ID



Add
W52 Wall Mtd Bldg ID

| Botanical Gardens (254) | | qty |
|--------------------------------------|-----------------------|-----|
| W50 | Vehicular Bldg ID | 0 |
| W51 | Freestanding, Ped | 0 |
| W52 | Wall Mounted | 0 |
| W53 | Vinyl Letters on Door | 0 |
| W54 | Parapet Letters | 0 |
| B95 | Loading Dock ID | 0 |
| *Entry Sign—exception to Master Plan | | 1 |

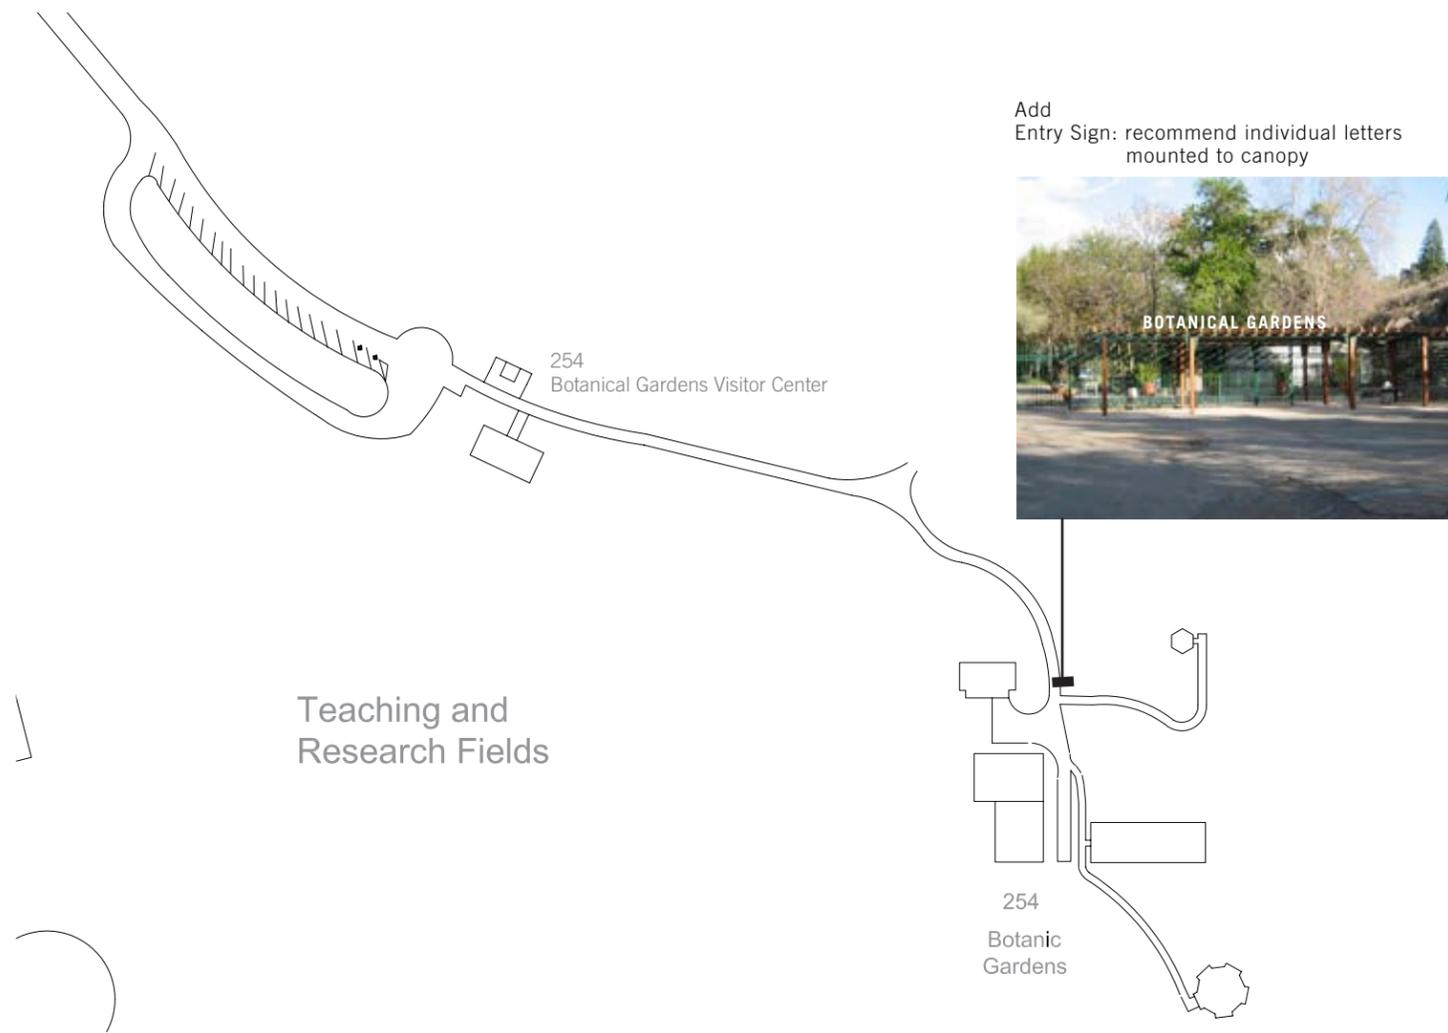

| Bourns Hall (261) | | qty |
|-------------------|-----------------------|-----|
| W50 | Vehicular Bldg ID | 1 |
| W51 | Freestanding, Ped | 1 |
| W52 | Wall Mounted | 5 |
| W53 | Vinyl Letters on Door | 4 |
| W54 | Parapet Letters | 0 |
| B95 | Loading Dock ID | 0 |



Keep existing sign



Keep existing sign



Keep existing sign



Add W52 Wall Mounted Bldg ID



Keep existing sign
Add W53 Vinyl Letters on Door



Add W52 Wall Mounted Bldg ID



Add W52 Wall Mounted Bldg ID



Add W53 Vinyl Letters on Door



Add W52 Wall Mounted Bldg ID



Add W51 Freestanding, Ped Bldg ID



Add W53 Vinyl Letters on Door



Add W52 Wall Mounted Bldg ID



Keep existing sign



Add W53 Vinyl Letters on Door

| Boyce Hall (341) | | qty |
|------------------|-----------------------|-----|
| W50 | Vehicular Bldg ID | 0 |
| W51 | Freestanding, Ped | 1 |
| W52 | Wall Mounted | 4 |
| W53 | Vinyl Letters on Door | 4 |
| W54 | Parapet Letters | 0 |
| B95 | Loading Dock ID | 1 |



Keep existing sign



Replace with W53 Vinyl Letters on Door



Add W52 Wall Mounted Bldg ID

Replace with W53 Vinyl Letters on Door


Add W51 Ped. Bldg ID



Replace with W53 Vinyl Letters on Door



Add W52 Wall Mounted Bldg ID

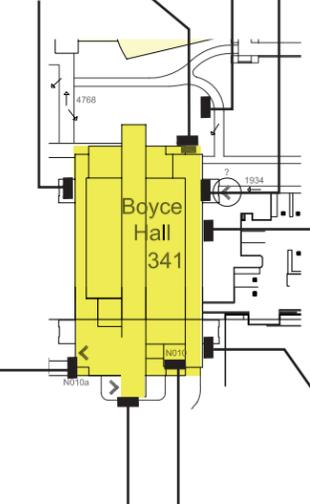

Replace with B95 Loading Dock ID



Add W52 Wall Mounted Bldg ID



Keep existing sign



Add W52 Wall Mounted Bldg ID




Replace with W53 Vinyl Letters on Door


| Boyden Laboratory (482) | | qty |
|-------------------------|-----------------------|-----|
| W50 | Vehicular Bldg ID | 0 |
| W51 | Freestanding, Ped | 1 |
| W52 | Wall Mounted | 2 |
| W53 | Vinyl Letters on Door | 0 |
| W54 | Parapet Letters | 0 |
| B95 | Loading Dock ID | 0 |



Remove existing sign

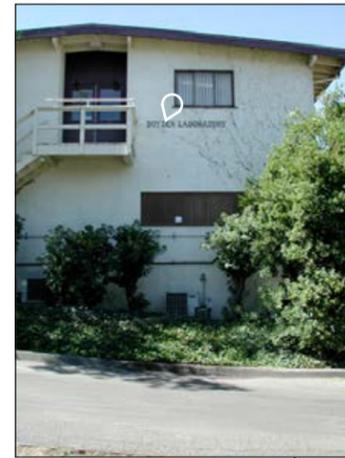


Keep existing sign

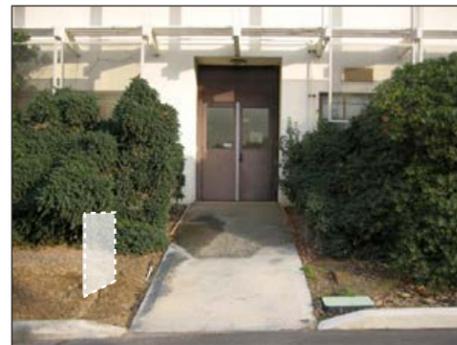


Add
W51 Freestanding Bldg ID




Add
W52 Wall Mounted Bldg ID

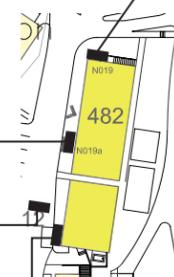

| California Museum of Photography (720) | | qty |
|--|-----------------------|-----|
| W50 | Vehicle Bldg ID | 0 |
| W51 | Freestanding, Ped | 0 |
| W52 | Wall Mounted | 0 |
| W53 | Vinyl Letters on Door | 0 |
| W54 | Parapet Letters | 0 |

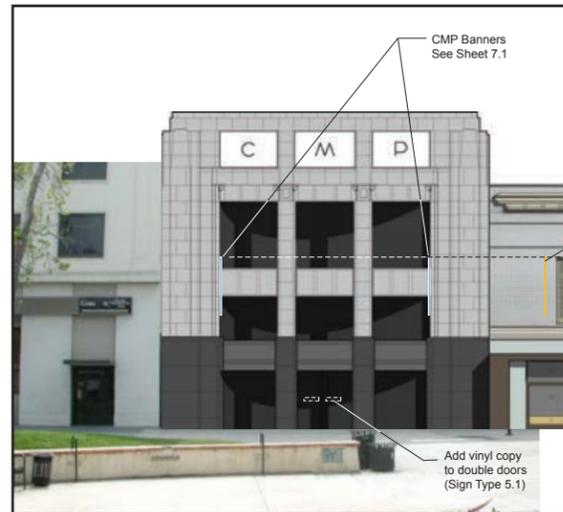

Keep existing Vinyl Letters on Door and Banners

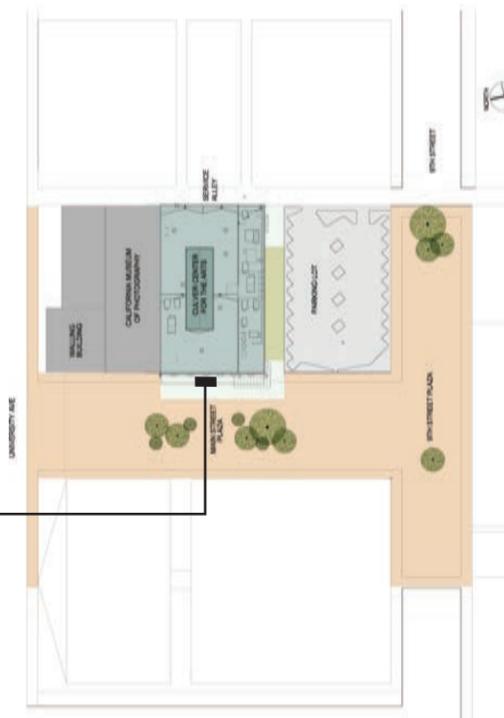

| Canyon Crest Family Student Housing (000-183) | | qty |
|---|-----------------------|-----|
| W50 | Vehicular Bldg ID | 4 |
| W51 | Freestanding, Ped | 0 |
| W52 | Wall Mounted | 0 |
| W53 | Vinyl Letters on Door | 0 |
| W54 | Parapet Letters | 0 |
| B95 | Loading Dock ID | 0 |



Replace with W50 Vehicular Building ID



Add W50 Vehicular Building ID



Replace with W50 Vehicular Building ID

| Central Utility Plant (295) | | qty |
|-----------------------------|-----------------------|-----|
| W50 | Vehicular Bldg ID | 2 |
| W51 | Freestanding, Ped | 0 |
| W52 | Wall Mounted | 2 |
| W53 | Vinyl Letters on Door | 0 |
| W54 | Parapet Letters | 1 |
| B95 | Loading Dock ID | 0 |



Replace with W52 WallMounted Bldg ID




Replace with W50 Vehicular Bldg ID



Replace with W52 WallMounted Bldg ID



Replace with W54 Parapet Letters

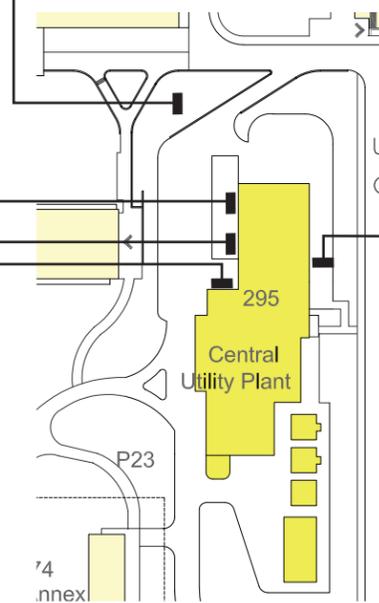


Add W50 Vehicular Bldg ID

| Chapman Hall (215) | | qty |
|--------------------|-----------------------|-----|
| W50 | Vehicular Bldg ID | 0 |
| W51 | Freestanding, Ped | 2 |
| W52 | Wall Mounted | 0 |
| W53 | Vinyl Letters on Door | 2 |
| W54 | Parapet Letters | 0 |
| B95 | Loading Dock ID | 0 |


Replace with W53 Vinyl Letters on Door



Add
W51 Freestanding, Ped

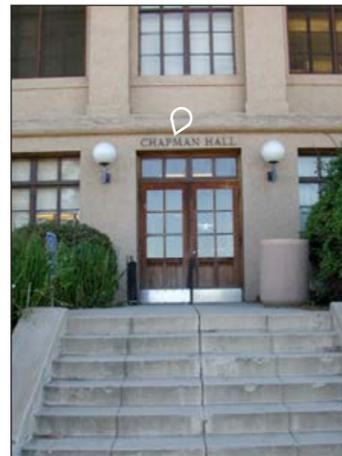

Add
W53 Vinyl Letters on Door

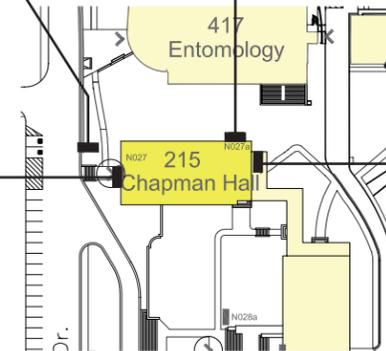


Add
W51 Freestanding Bldg ID

| Chemical Sciences (414) | | qty |
|-------------------------|-----------------------|-----|
| W50 | Vehicular Bldg ID | 1 |
| W51 | Freestanding, Ped | 0 |
| W52 | Wall Mounted | 0 |
| W53 | Vinyl Letters on Door | 5 |
| W54 | Parapet Letters | 0 |
| B95 | Loading Dock ID | 1 |



Replace with
W53 Vinyl Letters on Door

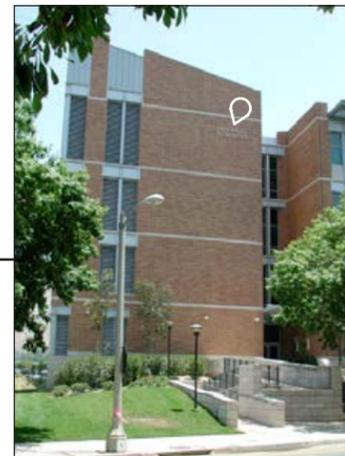

Keep existing sign





Keep existing sign
Add
B95 Loading Dock Sign



Add
W53 Vinyl Letters on Door



Add
W50 Vehicular Bldg ID

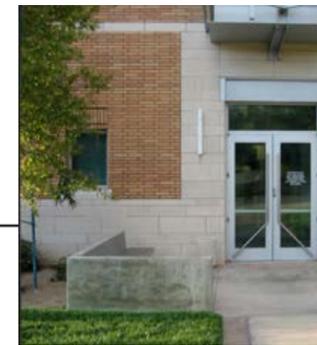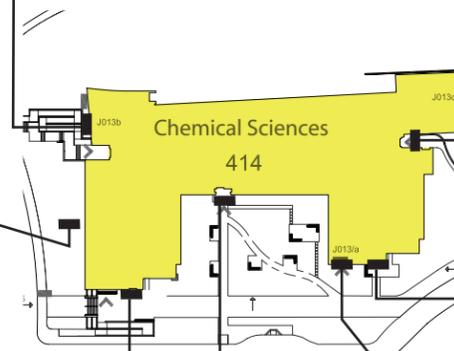

Add
W53 Vinyl Letters on Door



Replace with
W53 Vinyl Letters on Door




Add
W53 Vinyl Letters on Door



Keep existing sign


| Child Dev Center (396) | | qty |
|------------------------|-----------------------|-----|
| W50 | Vehicular Bldg ID | 1 |
| W51 | Freestanding, Ped | 0 |
| W52 | Wall Mounted | 0 |
| W53 | Vinyl Letters on Door | 0 |
| W54 | Parapet Letters | 0 |
| B95 | Loading Dock ID | 0 |

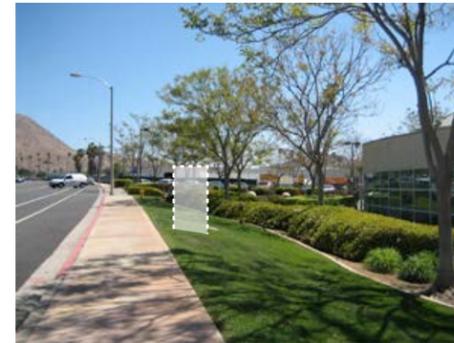

Add
W50 Vehicular Bldg ID



Remove existing sign

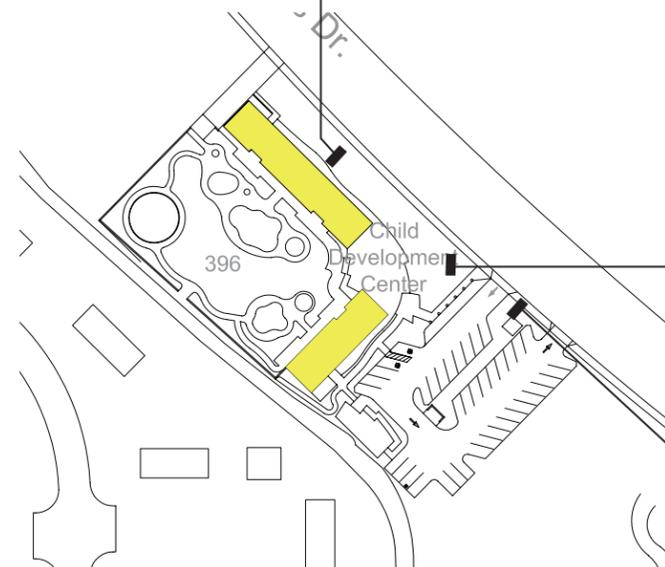

Note:
A Parking Sign (W71) with the bldg name
has been included in the sign location plan

| | College Bldg North (231) | College Bldg South (517) | qty |
|-----|--------------------------|--------------------------|-----|
| W50 | Vehicular Bldg ID | | 1 |
| W51 | Freestanding, Ped | | 1 |
| W52 | Wall Mounted Bldg ID | | 3 |
| W53 | Vinyl Letters on Door | | 2 |
| W54 | Parapet Letters | | 2 |
| B95 | Loading Dock ID | | 0 |



Add
W53 Vinyl Letters on Door




Add
W53 Vinyl Letters on Door



Replace with W52 Wall Mounted Bldg ID



Replace with W52 Wall Mounted Bldg ID

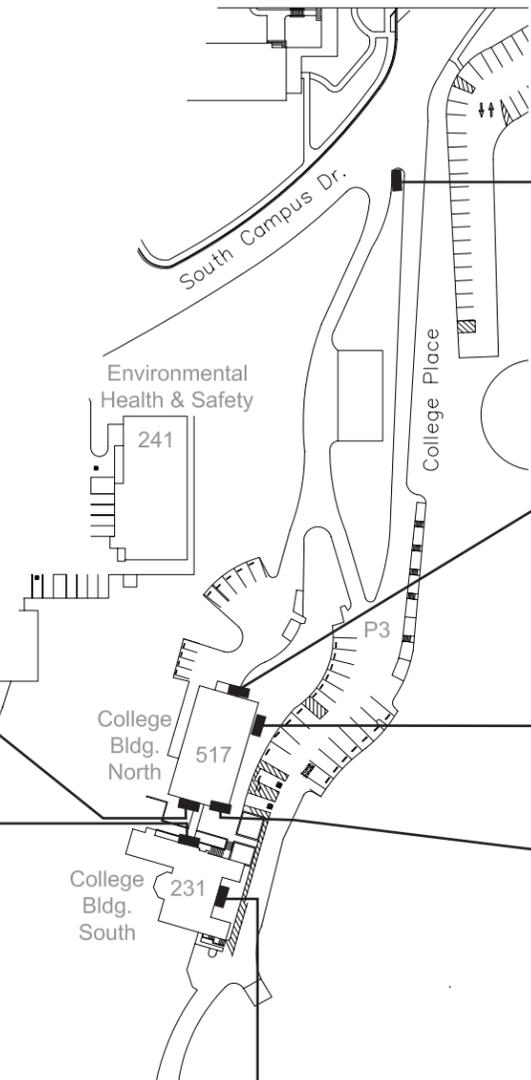

Replace with
W50 Vehicular Building ID



Add
W54 Parapet Letters



Add
W54 Parapet Letters



Add
W52 Wall Mounted Bldg ID




Keep existing sign

| Computing/Comm. (381) | | qty |
|-----------------------|-----------------------|-----|
| W50 | Vehicular Bldg ID | 1 |
| W51 | Freestanding, Ped | 0 |
| W52 | Wall Mounted | 0 |
| W53 | Vinyl Letters on Door | 1 |
| W54 | Parapet Letters | 0 |
| B95 | Loading Dock ID | 0 |



Keep existing sign
Add
W50 Vehicular Bldg ID

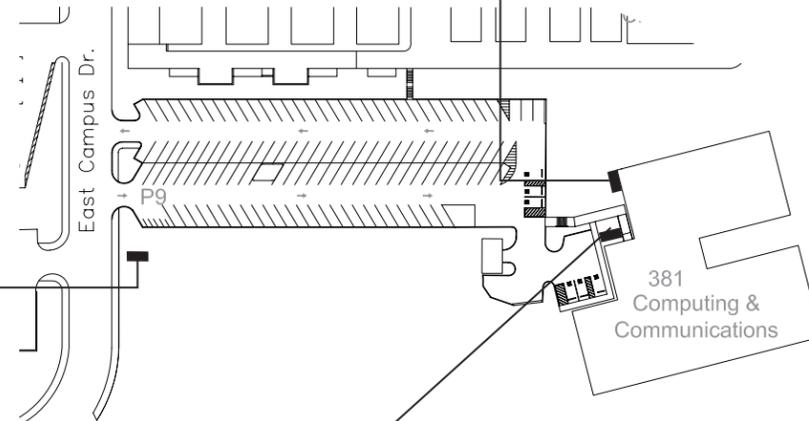

Note:
A Parking Sign (W71)
with the building name
has been included in the sign
location plan



Add
W53 Vinyl Letters on Door

| Corporation Yard A-C (485-487) | | qty |
|--------------------------------|-----------------------|-----|
| W50 | Vehicular Bldg ID | 2 |
| W51 | Freestanding, Ped | 0 |
| W52 | Wall Mounted | 0 |
| W53 | Vinyl Letters on Door | 0 |
| W54 | Parapet Letters | 0 |
| B95 | Loading Dock ID | 0 |



Note:
A Parking Sign (W71) with the building name has been included on the sign location plan.




Add W50 Vehicular Bldg ID

| Costo Hall (311) | | qty |
|------------------|-----------------------|-----|
| W50 | Vehicular Bldg ID | 0 |
| W51 | Freestanding, Ped | 1 |
| W52 | Wall Mounted | 0 |
| W53 | Vinyl Letters on Door | 0 |
| W54 | Parapet Letters | 0 |
| B95 | Loading Dock ID | 0 |


Note:
 Building should be surveyed again
 once the Commons Expansion
 is 100% complete.



Keep existing sign

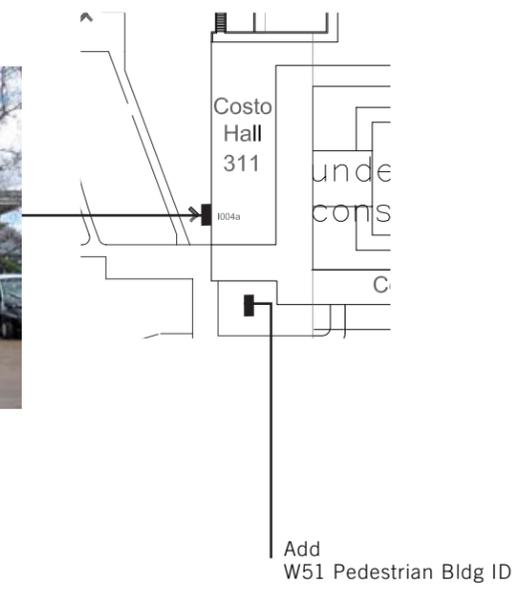


| University Cottage (118) | | qty |
|--------------------------|-----------------------|-----|
| W50 | Vehicular Bldg ID | 1 |
| W51 | Freestanding, Ped | 0 |
| W52 | Wall Mounted | 0 |
| W53 | Vinyl Letters on Door | 0 |
| W54 | Parapet Letters | 0 |
| B95 | Loading Dock ID | 0 |

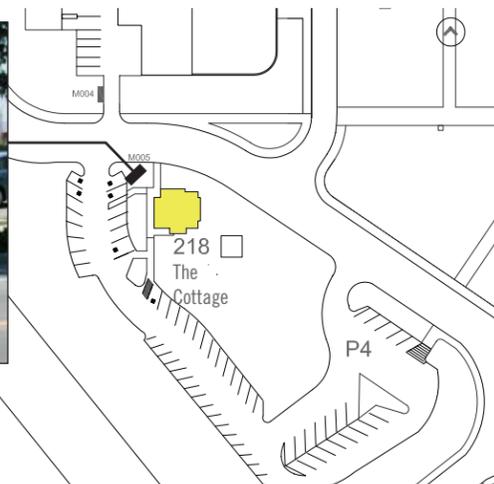


Replace with
W50 Vehicular Bldg ID


| Culver Center of the Arts (757) | | qty |
|---------------------------------|-----------------------|-----|
| W50 | Vehicular Bldg ID | 0 |
| W51 | Freestanding, Ped | 0 |
| W52 | Wall Mounted | 0 |
| W53 | Vinyl Letters on Door | 0 |
| W54 | Parapet Letters | 0 |

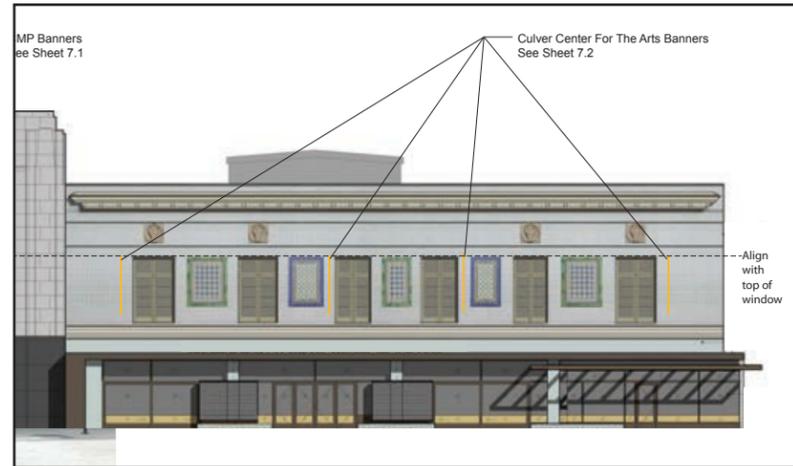

See UC Riverside ArtsBlock Signage Package for Building Identification recommendations.

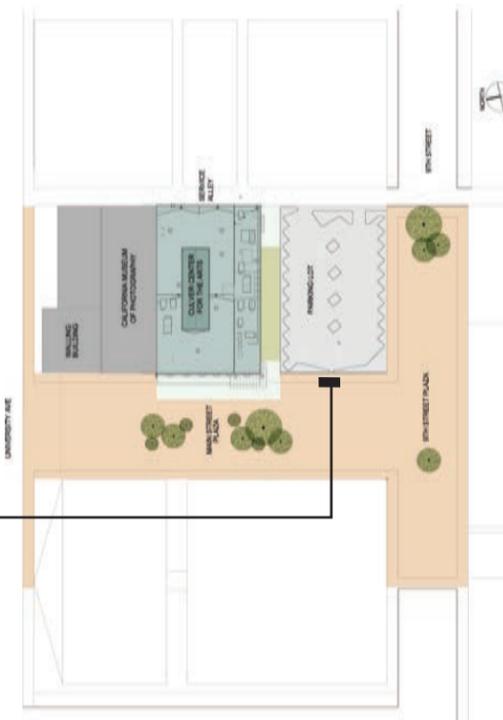

| Custodial & Grounds (507) | | qty |
|---------------------------|-----------------------|-----|
| W50 | Vehicular Bldg ID | 1 |
| W51 | Freestanding, Ped | 0 |
| W52 | Wall Mounted | 0 |
| W53 | Vinyl Letters on Door | 0 |
| W54 | Parapet Letters | 0 |
| B95 | Loading Dock ID | 0 |

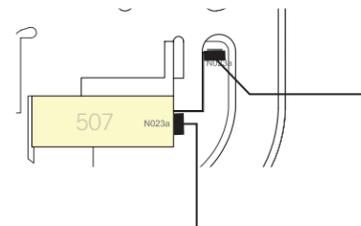

Replace with W50 Vehicular Bldg ID



Keep existing sign

| Engineering Building Unit 2 (194) | | |
|-----------------------------------|-------------------------|-----|
| | | qty |
| W50 | Freestanding, Vehicular | 1 |
| W51 | Freestanding, Ped | 0 |
| W52 | Wall Mounted | 6 |
| W53 | Vinyl Letters on Door | 5 |
| W54 | Parapet Letters | 0 |
| B95 | Loading Dock ID | 1 |



Add
W52 Wall Mounted Building ID
W53 Vinyl Letters on Door




Add
W52 Wall Mounted Building ID




Keep existing sign
Add W53 Vinyl Letters on Door



Add
W52 Wall Mounted Building ID

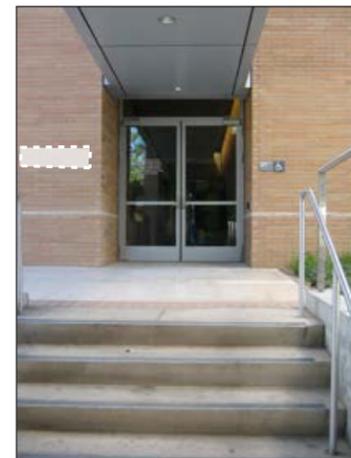

Add
W52 Wall Mounted Building ID
W53 Vinyl letters on door

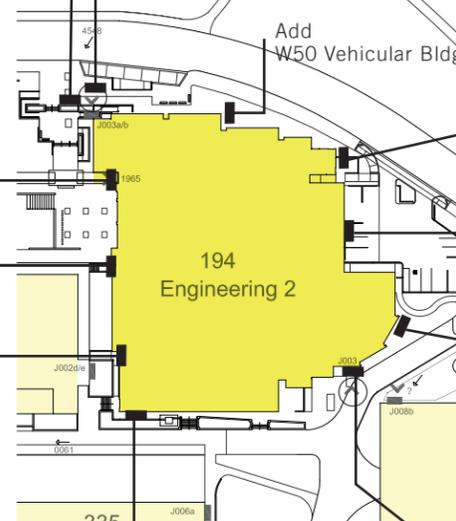


Add
W50 Vehicular Bldg ID



Add
B95 Loading Dock ID



Add
W52 Wall Mounted Building ID

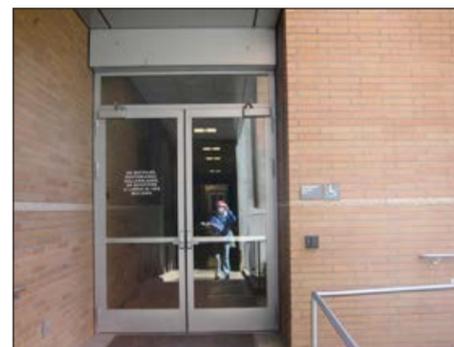

Add
W53 Vinyl letters on door



Add
W52 Wall Mounted Building ID



Keep existing sign
Add
W53 Vinyl letters on door

| Entomology (417) | | qty |
|------------------|-----------------------|-----|
| W50 | Vehicular Bldg ID | 1 |
| W51 | Freestanding, Ped | 0 |
| W52 | Wall Mounted | 3 |
| W53 | Vinyl Letters on Door | 3 |
| W54 | Parapet Letters | 0 |
| B95 | Loading Dock ID | 1 |




Add
W52 Wall Mounted Bldg ID




Add
B95 Loading Dock ID



Keep existing sign

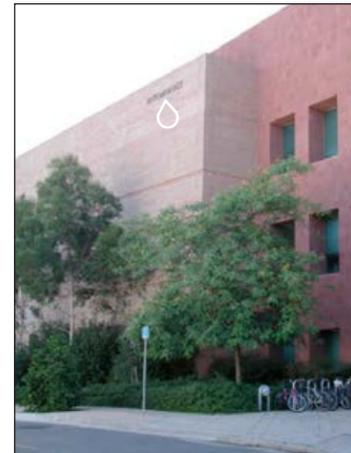

Keep existing sign

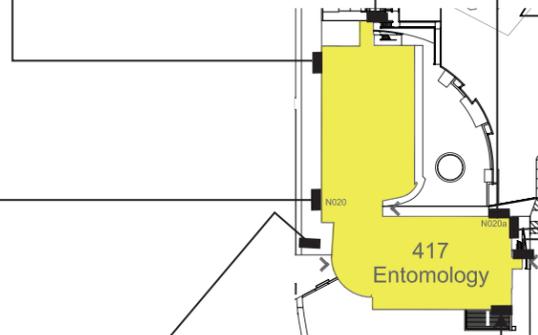

Add
W52 Wall Mounted Bldg ID
W53 Vinyl Letters on Door



Add
W50 Vehicular Bldg ID
W53 Vinyl Letters on Door



Add
W52 Wall Mounted Bldg ID



Add
W53 Vinyl Letters on Door

| Entomology Museum (256) | | qty |
|-------------------------|-----------------------|-----|
| W50 | Vehicular Bldg ID | 0 |
| W51 | Freestanding, Ped | 1 |
| W52 | Wall Mounted Bldg ID | 1 |
| W53 | Vinyl Letters on Door | 2 |
| W54 | Parapet Letters | 0 |
| B95 | Loading Dock ID | 0 |


Keep existing sign



Add W53 Vinyl Letters on Door



Add W51 Freestanding Bldg ID

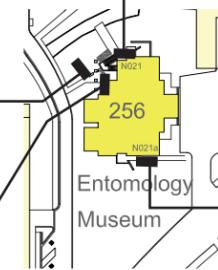

Replace with W52 Wall Mounted Bldg ID




Add W53 Vinyl Letters on Door

| Env. Health & Safety (241) | | qty |
|----------------------------|-----------------------|-----|
| W50 | Vehicular Bldg ID | 0 |
| W51 | Freestanding, Ped | 0 |
| W52 | Wall Mounted | 0 |
| W53 | Vinyl Letters on Door | 1 |
| W54 | Parapet Letters | 1 |
| B95 | Loading Dock ID | 0 |

Keep existing sign



Add W54 Parapet Letters

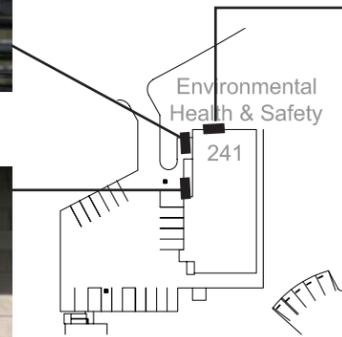

Replace with W53 Vinyl Letters on Door


| | qty |
|---------------------------|-----|
| Fawcett Laboratory (503) | |
| W50 Vehicular Bldg ID | 2 |
| W51 Freestanding, Ped | 1 |
| W52 Wall Mounted | 1 |
| W53 Vinyl Letters on Door | 2 |
| W54 Parapet Letters | 0 |
| B95 Loading Dock ID | 1 |



Replace with W50 Vehicular Bldg ID




Replace with W52 Wall Mounted Bldg ID
Add W53 Vinyl Letters on Door

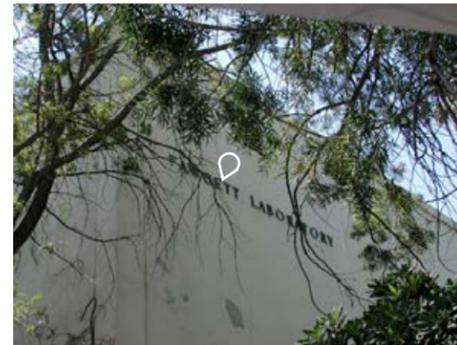

Keep existing sign

Add B95 Loading Dock ID

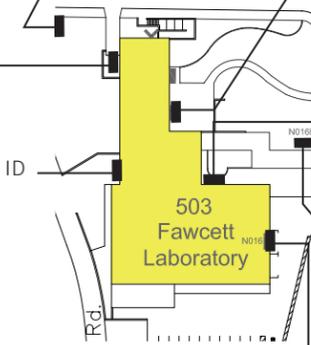

Add W53 Vinyl Letters on Door



Keep existing sign



Replace with W50 Vehicular Bldg ID

Geology (335)

| | qty |
|---------------------------|-----|
| W50 Vehicular Bldg ID | 0 |
| W51 Freestanding, Ped | 4 |
| W52 Wall Mounted | 3 |
| W53 Vinyl Letters on Door | 4 |
| W54 Parapet Letters | 0 |
| B95 Loading Dock ID | 1 |




Keep existing sign
Add W53 Vinyl Letters on Door




Add
W51 Freestanding Bldg ID



Add
W51 Freestanding Bldg ID

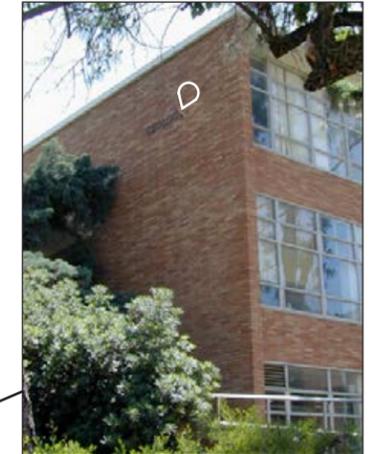


Keep existing sign

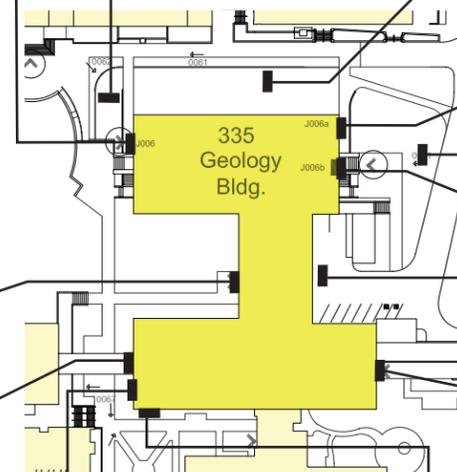


Add
Loading Dock Info



Replace
W53 Vinyl Letters on Door

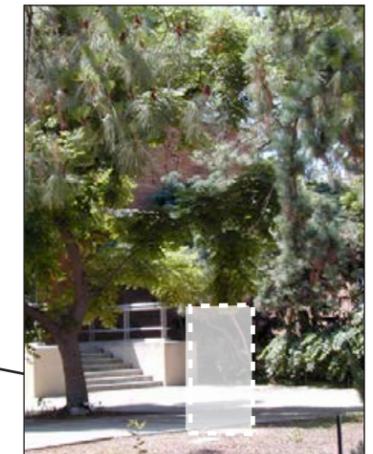

Add
W51 Freestanding Bldg ID

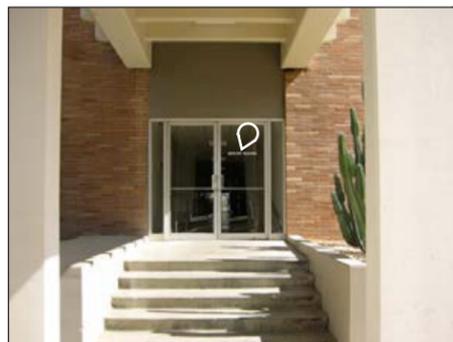

Replace
W53 Vinyl Letters on Door




Add
W52 Wall Mounted Bldg ID



Add
W52 Wall Mounted Bldg ID
W51 Freestanding Bldg ID



Add
W52 Wall Mounted Bldg ID

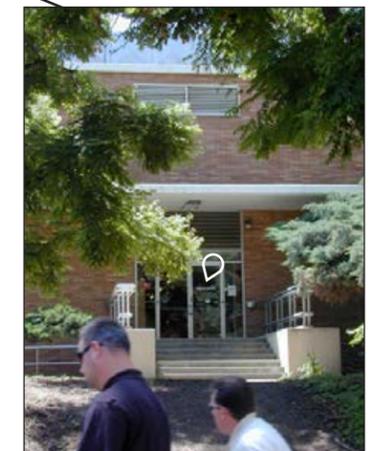

Replace
W53 Vinyl Letters on Door

| Greenhouses 6-10 (200, & 275-278) | | qty |
|--------------------------------------|-----------------------|-----|
| W50 | Vehicular Bldg ID | 0 |
| W51 | Freestanding, Ped | 0 |
| W52 | Wall Mounted | 1 |
| W53 | Vinyl Letters on Door | 0 |
| W54 | Parapet Letters | 0 |
| W55 | Building ID, small | 10 |
| B95 | Loading Dock ID | 0 |



Add W55 Building ID, small



Add W55 Building ID, small



Add W55 Building ID, small




Add W55 Building ID, small



Add W55 Building ID, small



Add W55 Building ID, small

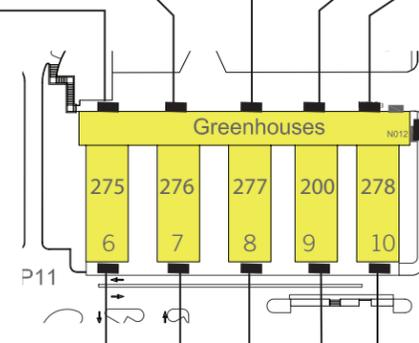

Replace with W52 Wall Mounted Bldg ID



Add W55 Building ID, small



Add W55 Building ID, small



Add W55 Building ID, small



Add W55 Building ID, small

| Greenhouses 11-14 (279-281, 481) | | qty |
|-------------------------------------|-----------------------|-----|
| W50 | Vehicular Bldg ID | 0 |
| W51 | Freestanding, Ped | 0 |
| W52 | Wall Mounted | 0 |
| W53 | Vinyl Letters on Door | 0 |
| W54 | Parapet Letters | 0 |
| W55 | Building ID, small | 11 |
| B95 | Loading Dock ID | 0 |



Replace with
W55 Building ID, small



Replace with
W55 Building ID, small



Replace with
W55 Building ID, small



Replace with
W55 Building ID, small




Replace with
W55 Building ID, small



Replace with
W55 Building ID, small



Replace with
W55 Building ID, small

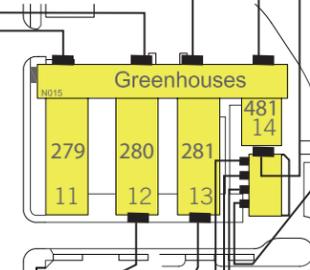


Replace with
W55 Building ID, small



Replace with
W55 Building ID, small



Replace with
W55 Building ID, small

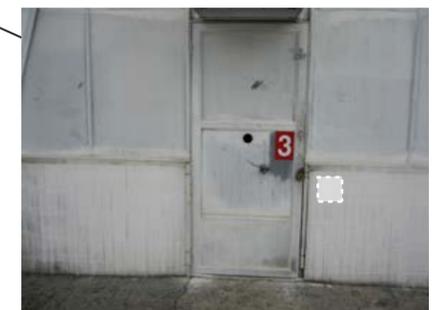

Replace with
W55 Building ID, small

| Greenhouses 15 - 21 (210, 284, 483, 513-515, & 202) | | |
|---|-----------------------|-----|
| | | qty |
| W50 | Vehicular Bldg ID | 0 |
| W51 | Freestanding, Ped | 0 |
| W52 | Wall Mounted | 4 |
| W53 | Vinyl Letters on Door | 0 |
| W54 | Parapet Letters | 0 |
| W55 | Building ID, small | 8 |
| B95 | Loading Dock ID | 0 |



Replace with
W52 Wall Mounted Bldg ID



Replace with
W55 Building ID, small



Replace with
W52 Wall Mounted Bldg ID



Replace with
W52 Wall Mounted Bldg ID



Replace with
W55 Building ID, small



Replace with
W55 Building ID, small



Replace with
W55 Building ID, small



Replace with
W55 Building ID, small



Replace with
W55 Building ID, small




Replace with
W55 Building ID, small



Replace with
W55 Building ID, small



Replace with
W52 Wall Mounted Bldg ID

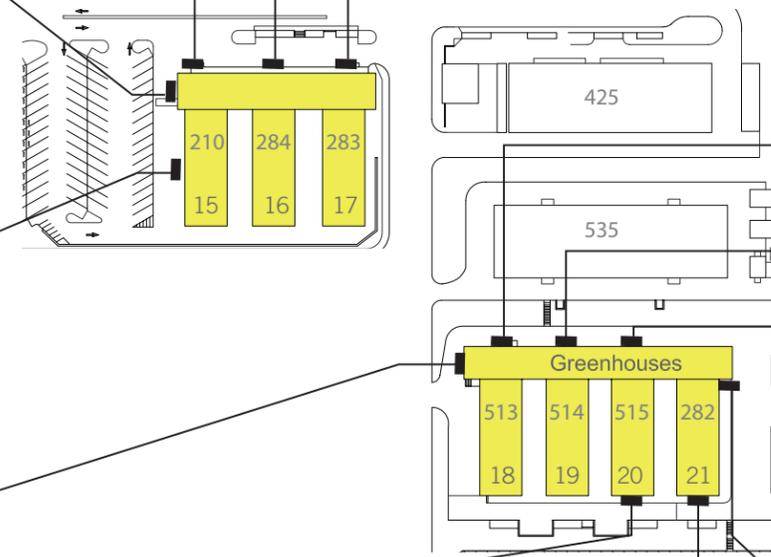


Headhouse greenhouses 1-3
(378, 259, 374)

| | qty |
|---------------------------|-----|
| W50 Vehicular Bldg ID | 0 |
| W51 Freestanding, Ped | 0 |
| W52 Wall Mounted | 6 |
| W53 Vinyl Letters on Door | 1 |
| W54 Parapet Letters | 0 |
| W55 Building ID, small | 4 |
| B95 Loading Dock ID | 0 |



Replace with W52 Wall Mounted Bldg ID

Note: A Parking Sign (W71) with the building name is included in the sign location plan

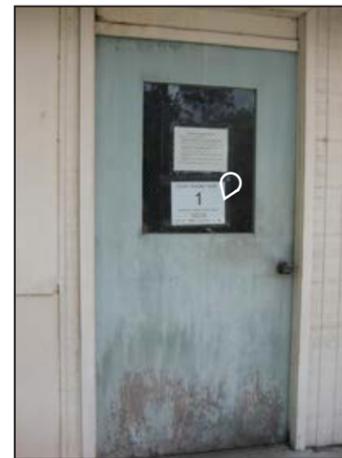

Replace with W55 Building ID, small



Replace with W55 Building ID, small




Replace with W55 Building ID, small

Replace with W52 Wall Mounted Bldg ID



Replace with W52 Wall Mounted Bldg ID

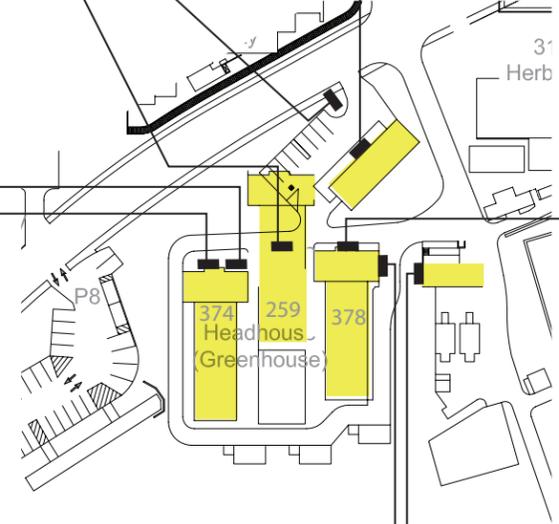

Replace with W52 Building ID, wall mounted



Replace with W52 Building ID, wall mounted



Replace with W53 Vinyl Letters on Door



Replace with W52 Building ID, wall mounted



Add W55 Building ID, small


| Health Services Building (495) | | qty |
|--------------------------------|-----------------------|-----|
| W50 | Vehicular Bldg ID | 2 |
| W51 | Freestanding, Ped | 0 |
| W52 | Wall Mounted | 1 |
| W53 | Vinyl Letters on Door | 1 |
| W54 | Parapet Letters | 0 |
| B95 | Loading Dock ID | 0 |



Keep existing sign



Replace with W53 Vinyl Letters on Door

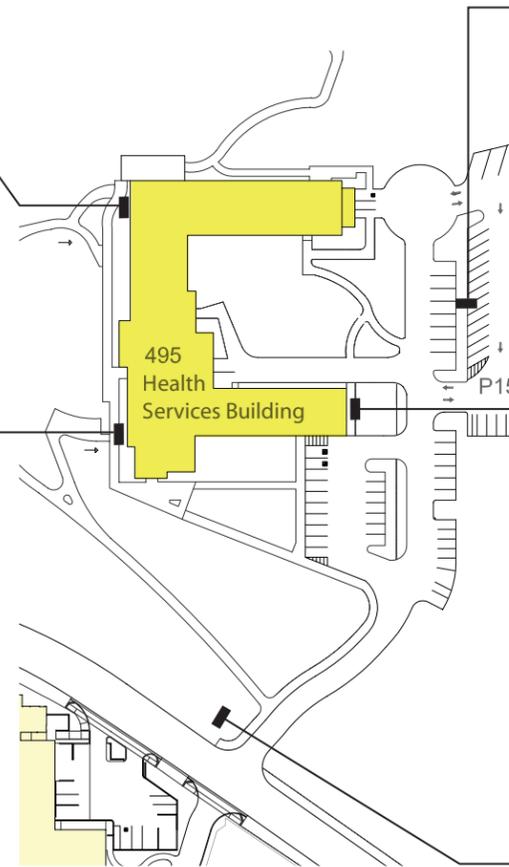

Add W50 Vehicular Bldg ID



Add W52 Wall Mounted Bldg ID

Add W50 Vehicular Building ID

| Herbarium (319) | | qty |
|-----------------|-----------------------|-----|
| W50 | Vehicular Bldg ID | 0 |
| W51 | Freestanding, Ped | 1 |
| W52 | Wall Mounted | 0 |
| W53 | Vinyl Letters on Door | 0 |
| W54 | Parapet Letters | 0 |
| B95 | Loading Dock ID | 0 |



Replace with
W51 Freestanding Bldg ID



Keep existing sign

| Highlander Hall (716) | | qty |
|-----------------------|-----------------------|-----|
| W50 | Vehicular Bldg ID | 0 |
| W51 | Freestanding, Ped | 0 |
| W52 | Wall Mounted | 3 |
| W53 | Vinyl Letters on Door | 1 |
| W54 | Parapet Letters | 0 |
| B95 | Loading Dock ID | 0 |





Replace with W52 Wall Mounted Bldg ID



Replace with W53 Vinyl Letters on Door



Replace with W52 Wall Mounted Bldg ID

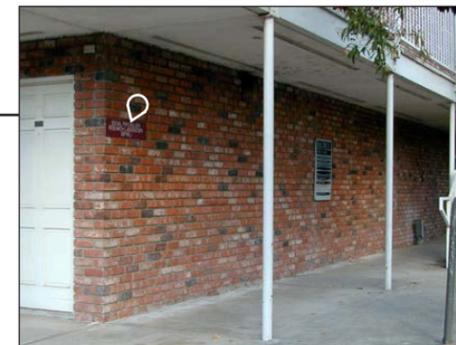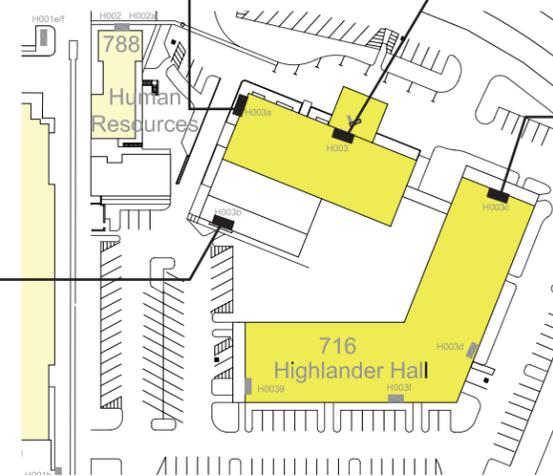

Replace with W52 Wall Mounted Bldg ID

| Hinderaker Hall (480) | | qty |
|---|-----------------------|-----|
| W50 | Vehicular Bldg ID | 0 |
| W51 | Freestanding, Ped | 1 |
| W52 | Wall Mounted | 0 |
| W53 | Vinyl Letters on Door | 2 |
| W54 | Parapet Letters | 0 |
| B95 | Loading Dock ID | 1 |
| * (2) sets of letters to match existing | | |



Add
W53 Vinyl Letters on Door




Keep existing sign



Keep existing sign



Keep existing sign

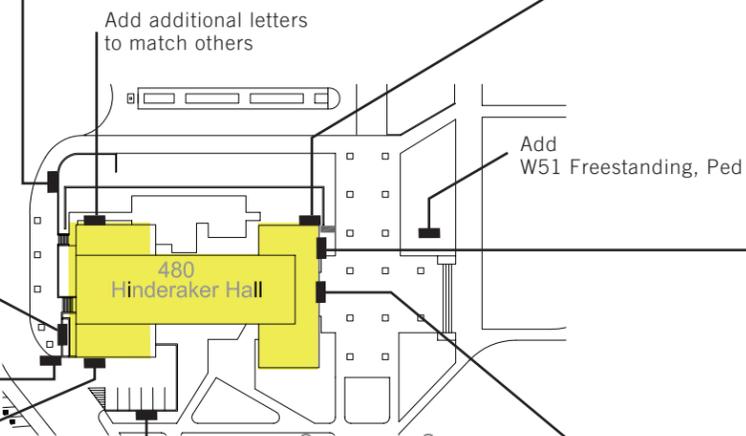

Note:
A Parking sign (W72) with
the building name is included
in the sign location plan.



Keep existing sign
Add
B95 Loading Dock ID




Add additional letters
to match other existing sign



Add
W53 Vinyl Letters on Door

| Housing Admin (581) | | qty |
|---------------------|-----------------------|-----|
| W50 | Vehicular Bldg ID | 1 |
| W51 | Freestanding, Ped | 0 |
| W52 | Wall Mounted | 0 |
| W53 | Vinyl Letters on Door | 1 |
| W54 | Parapet Letters | 0 |
| B95 | Loading Dock ID | 0 |

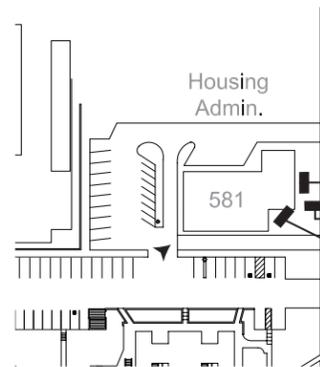

Keep existing sign
Add
W50 Vehicular Bldg ID



Add
W53 Vinyl Letters on Door


| Human Resources (788) | | qty |
|-----------------------|-----------------------|-----|
| W50 | Vehicular Bldg ID | 1 |
| W51 | Freestanding, Ped | 0 |
| W52 | Wall Mounted | 0 |
| W53 | Vinyl Letters on Door | 0 |
| W54 | Parapet Letters | 0 |
| B95 | Loading Dock ID | 0 |



Keep existing sign



Replace with W50 Vehicular Bldg ID

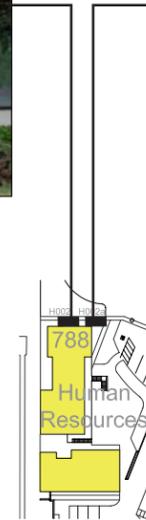

| Humanities (498) | | |
|------------------|-----------------------|-----|
| | | qty |
| W50 | Vehicular Bldg ID | 0 |
| W51 | Freestanding, Ped | 1 |
| W52 | Wall Mounted | 1 |
| W53 | Vinyl Letters on Door | 0 |
| W54 | Parapet Letters | 2 |
| B95 | Loading Dock ID | 1 |



Replace with
W54 Parapet Letters
(University Theater)



Add
B51 Freestanding Bldg ID




Add
W54 Parapet Letters
Keep existing sign



Add
B95 Loading Dock ID

B95
Add loading dock info

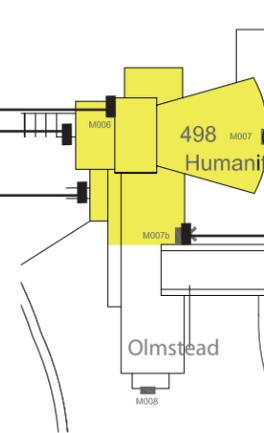


Add
W52 Wall Mounted Bldg ID

| Humanities & Social Sciences (307) | | qty |
|------------------------------------|-----------------------|-----|
| W50 | Vehicular Bldg ID | 1 |
| W51 | Freestanding, Ped | 1 |
| W52 | Wall Mounted | 10 |
| W53 | Vinyl Letters on Door | 0 |
| W54 | Parapet Letters | 0 |
| B95 | Loading Dock ID | 0 |



Add B52 Wall Mounted Bldg ID

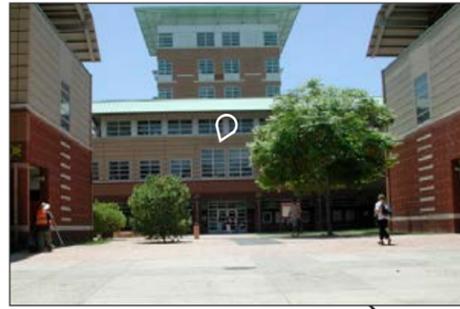

Keep existing sign



Add B52 Wall Mounted Bldg ID




Add B51 Freestanding Bldg ID



Add B52 Wall Mounted Bldg ID



Add B52 Wall Mounted Bldg ID

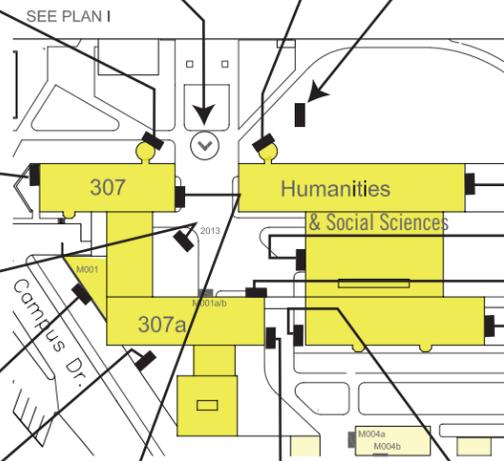

Add B52 Wall Mounted Bldg ID



Keep existing sign

Add B50 Vehicular Bldg ID



Add B52 Wall Mounted Bldg ID



Keep existing sign




Add B52 Wall Mounted Bldg ID



Add B52 Wall Mounted Bldg ID



Add B52 Wall Mounted Bldg ID

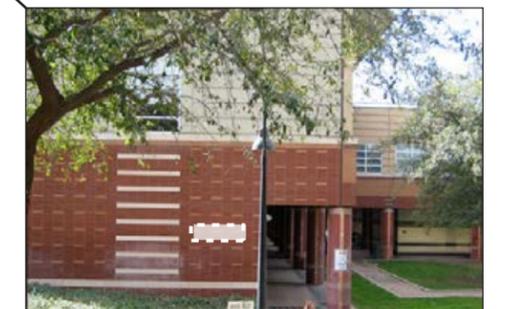


Add B52 Wall Mounted Bldg ID

| East Campus Insectary & Quarantine (289) | | qty |
|--|-----------------------|-----|
| W50 | Vehicular Bldg ID | 0 |
| W51 | Freestanding, Ped | 0 |
| W52 | Wall Mounted | 0 |
| W53 | Vinyl Letters on Door | 1 |
| W54 | Parapet Letters | 0 |
| B95 | Loading Dock ID | 1 |



Add W53 Vinyl Letters on Door

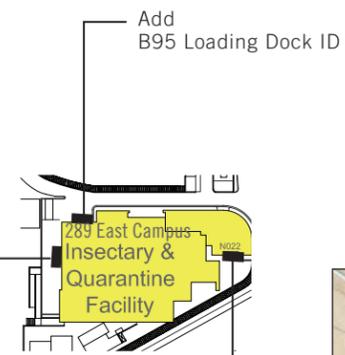

Keep existing sign

| International Village (998) | | qty |
|-----------------------------|-----------------------|-----|
| W50 | Vehicular Bldg ID | 1 |
| W51 | Freestanding, Ped | 0 |
| W52 | Wall Mounted | 0 |
| W53 | Vinyl Letters on Door | 1 |
| W54 | Parapet Letters | 0 |
| B95 | Loading Dock ID | 0 |


* Replace wall monument sign with new sign with current brand



Replace with
New sign to match current brand



Add
W50 Vehicular Bldg ID

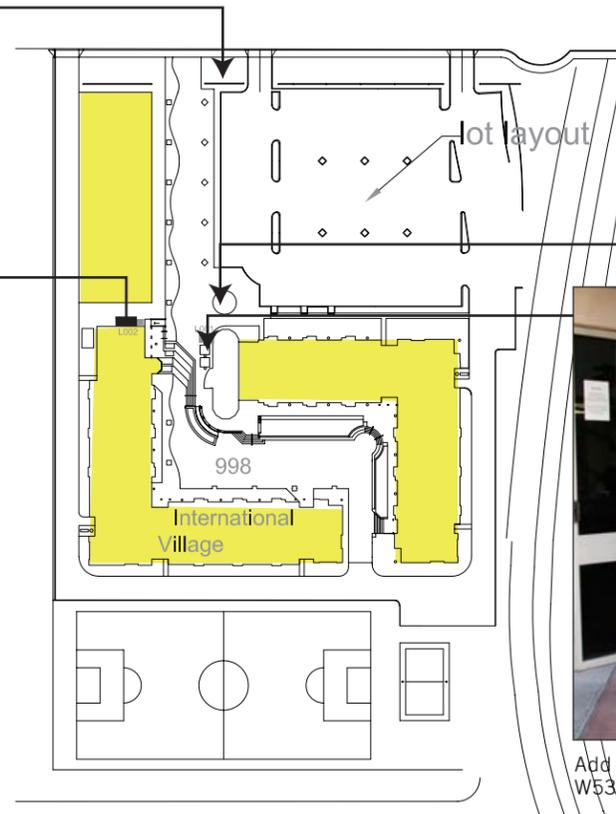


Keep existing sign




Add
W53 Vinyl Letters on Door

| KUCR Radio Station (176) | | qty |
|--------------------------|-----------------------|-----|
| W50 | Vehicular Bldg ID | 1 |
| W51 | Freestanding, Ped | 0 |
| W52 | Wall Mounted | 0 |
| W53 | Vinyl Letters on Door | 0 |
| W54 | Parapet Letters | 1 |
| B95 | Loading Dock ID | 0 |

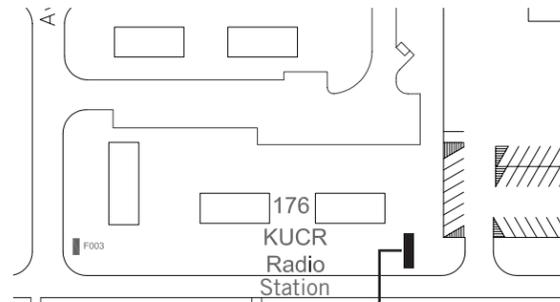

Replace existing sign with
W50 Vehicular Building ID
W54 Parapet Letters

| Life Sciences (316) | | qty |
|---------------------|-----------------------|-----|
| W50 | Vehicular Bldg ID | 0 |
| W51 | Freestanding, Ped | 0 |
| W52 | Wall Mounted | 3 |
| W53 | Vinyl Letters on Door | 6 |
| W54 | Parapet Letters | 2 |
| B95 | Loading Dock ID | 1 |

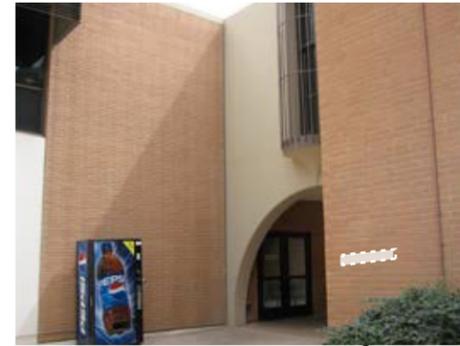

Add
W52 Wall Mounted Bldg ID
W53 Vinyl Letters on Door



Replace with
W53 Vinyl Letters on Door



Replace with
W53 Vinyl Letters on Door




Add
W53 Vinyl Letters on Sidelight

Add
B95 Loading Dock ID



Add
W54 Parapet Letters

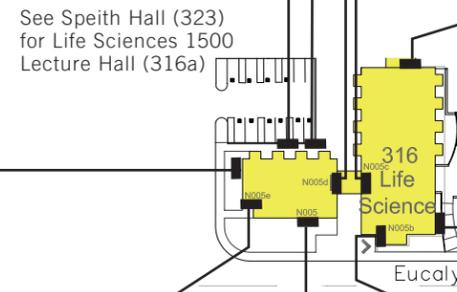


Add
W54 Parapet Letters



Add
W53 Vinyl Letters on Door



Add
W52 Wall Mounted Bldg ID

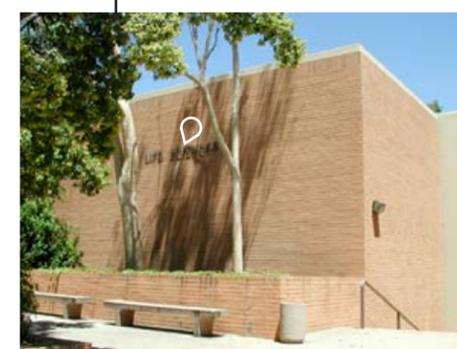

Keep existing sign



Add
W52 Wall Mounted Bldg ID




Replace with
W53 Vinyl Letters on Door

| Lothian Res. Hall (502) | | qty |
|-------------------------|-----------------------|-----|
| W50 | Vehicular Bldg ID | 0 |
| W51 | Freestanding, Ped | 0 |
| W52 | Wall Mounted | 1 |
| W53 | Vinyl Letters on Door | 0 |
| W54 | Parapet Letters | 0 |
| B95 | Loading Dock ID | 0 |



Add
W52 Wall Mounted Bldg ID

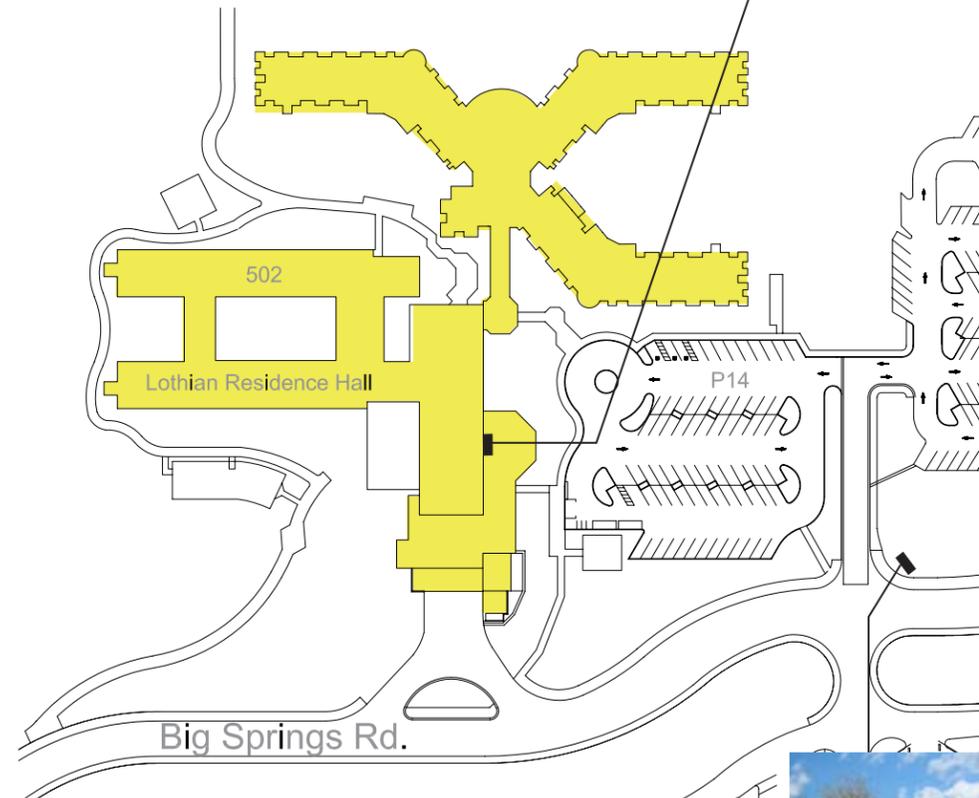

Remove Existing sign
Note: A Parking Sign (W70) with the bldg name is included in the sign location plan

| Olmsted Hall (497) | | |
|--------------------|-----------------------|-----|
| | | qty |
| W50 | Vehicular Bldg ID | 0 |
| W51 | Freestanding, Ped | 1 |
| W52 | Wall Mounted | 3 |
| W53 | Vinyl Letters on Door | 5 |
| W54 | Parapet Letters | 0 |
| B95 | Loading Dock ID | 0 |



Add W53 Vinyl Letters on Door



Keep existing sign



Add W51 Freestanding Bldg ID




Add W52 Wall Mounted Bldg ID



Replace with W53 Vinyl Letters on Door



Add W52 Wall Mounted Bldg ID

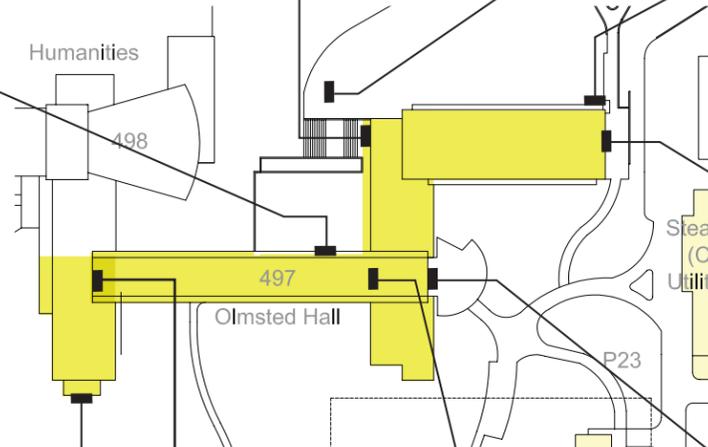

Add W53 Vinyl Letters on Door



Keep existing sign



Add W53 Vinyl Letters on Door



Replace with W53 Vinyl Letters on Door



Add W52 Wall Mounted Bldg ID

| Parking Services Building (272) | | qty |
|---------------------------------|-----------------------|-----|
| W50 | Vehicular Bldg ID | 1 |
| W51 | Freestanding, Ped | 0 |
| W52 | Wall Mounted | 0 |
| W53 | Vinyl Letters on Door | 1 |
| W54 | Parapet Letters | 0 |
| B95 | Loading Dock ID | 0 |




Replace with W50 Vehicular Bldg ID

**Pentland Hills Residence Hall A-Q
(365, 369, 636-648)(365) qty**

| | | |
|-----|-----------------------|---|
| W50 | Vehicular Bldg ID | 2 |
| W51 | Freestanding, Ped | 0 |
| W52 | Wall Mounted | 0 |
| W53 | Vinyl Letters on Door | 0 |
| W54 | Parapet Letters | 0 |
| B95 | Loading Dock ID | 0 |

No additional signs

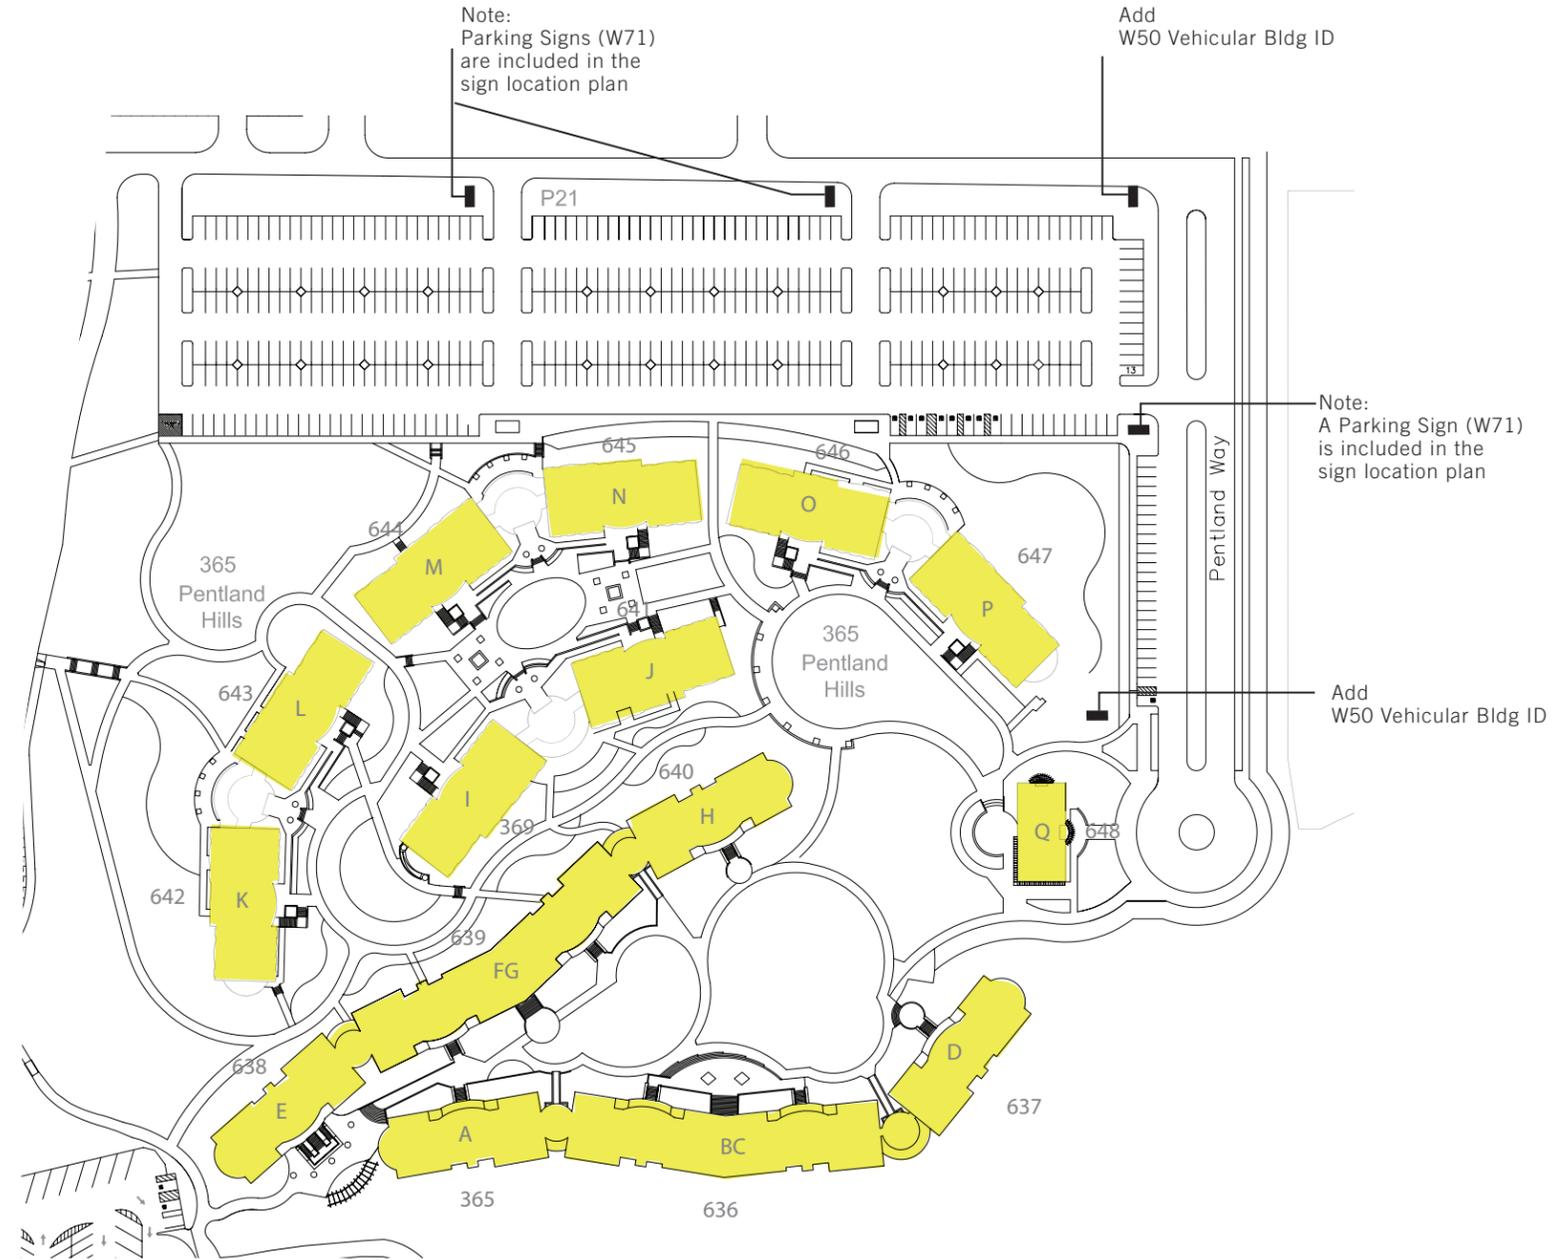

Physics (504)

| | qty |
|---------------------------|-----|
| W50 Vehicular Bldg ID | 1 |
| W51 Freestanding, Ped | 0 |
| W52 Wall Mounted | 7 |
| W53 Vinyl Letters on Door | 3 |
| W54 Parapet Letters | 0 |
| B95 Loading Dock ID | 1 |



Add W52 Wall Mounted Bldg ID



Add W52 Wall Mounted Bldg ID



Add W52 Wall Mounted Bldg ID
Add W50 Vehicular Bldg ID




Add W53 Vinyl Letters on Door



Add B95 Loading Dock Id



Add W52 Wall Mounted Bldg ID

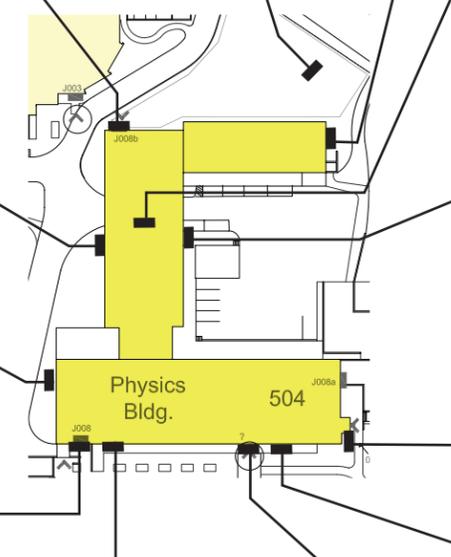

See Physics 2000 (504A) for Lecture Hall Signs



Keep existing sign
Add W52 Wall Mounted Bldg ID



Add W52 Wall Mounted Bldg ID



Keep existing sign



Add W53 Vinyl Letters on Door



Add W53 Vinyl Letters on Door



Add W52 Wall Mounted Bldg ID


| Physics 2000 Lecture Hall(504a) | | qty |
|---------------------------------|-----------------------|-----|
| W50 | Vehicular Bldg ID | 0 |
| W51 | Freestanding, Ped | 1 |
| W52 | Wall Mounted | 4 |
| W53 | Vinyl Letters on Door | 0 |
| W54 | Parapet Letters | 1 |
| B95 | Loading Dock ID | 0 |




Add
W52 Wall Mounted Bldg ID



Add
W52 Wall Mounted Bldg ID

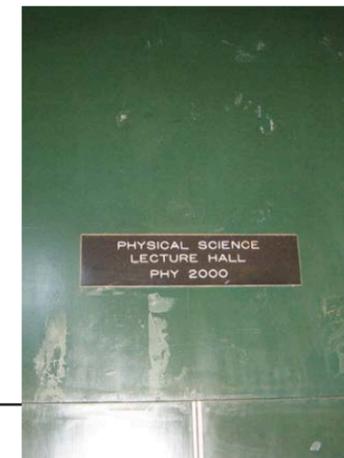

Add
W51 Freestanding Bldg ID

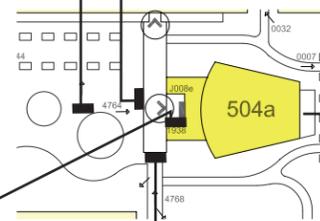

Add
W52 Wall Mounted Bldg ID



Add
W54 Parapet Letters




Add
W52 Wall Mounted Bldg ID



| Phys Ed Bldg (334) | | qty |
|--------------------|-----------------------|-----|
| W50 | Vehicular Bldg ID | 0 |
| W51 | Freestanding, Ped | 1 |
| W52 | Wall Mounted | 0 |
| W53 | Vinyl Letters on Door | 1 |
| W54 | Parapet Letters | 0 |
| B95 | Loading Dock ID | 0 |

Building Signage should be reviewed once construction is completed in this area.

Keep existing sign

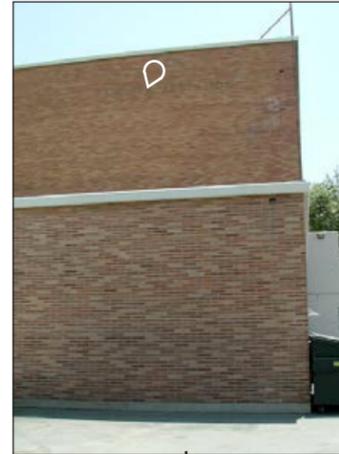

Keep existing sign

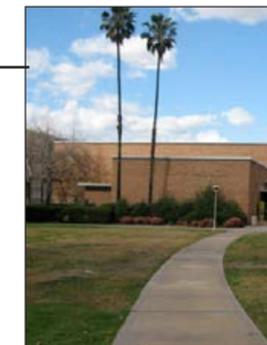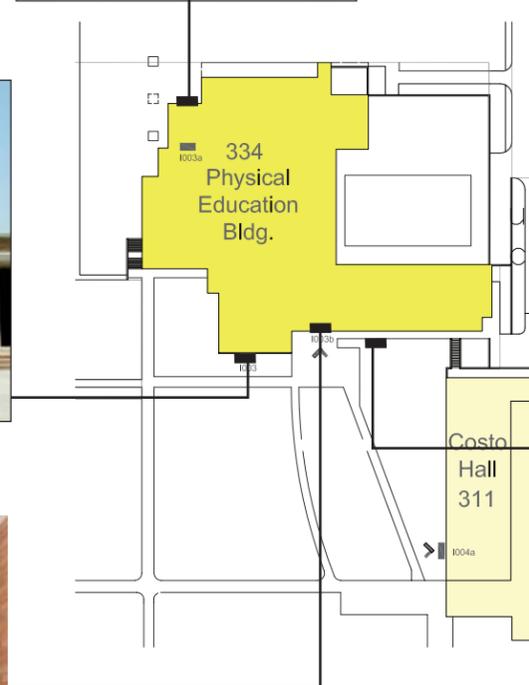

Add B51 Freestanding Bldg ID



Replace

| Pierce Hall (508) | | |
|-------------------|-----------------------|-----|
| | | qty |
| W50 | Vehicular Bldg ID | 0 |
| W51 | Freestanding, Ped | 1 |
| W52 | Wall Mounted | 3 |
| W53 | Vinyl Letters on Door | 3 |
| W54 | Parapet Letters | 0 |
| B95 | Loading Dock ID | 1 |



Add
W51 Freestanding Bldg ID



Add
B95 Loading Dock ID




Add
W52 Wall Mounted Bldg ID



Add
W52 Wall Mounted Bldg ID



Keep existing sign
Add
W53 Vinyl Letters on Door

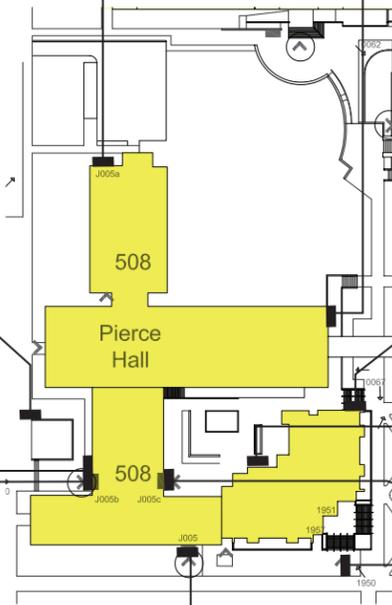

Add
W53 Vinyl Letters on Door



Add
W52 Wall Mounted Bldg ID



Keep existing sign



Add
W51 Freestanding Bldg ID




Keep existing sign "Pierce Hall"
Remove "Chemistry"
Add W53 Vinyl Letters on Door

| Police Building (566) | | qty |
|-----------------------|-----------------------|-----|
| W50 | Vehicular Bldg ID | 1 |
| W51 | Freestanding, Ped | 0 |
| W52 | Wall Mounted | 0 |
| W53 | Vinyl Letters on Door | 0 |
| W54 | Parapet Letters | 0 |
| B95 | Loading Dock ID | 0 |



Keep existing sign

Note:
A Monument Sign for the Campus is included on the sign location plan

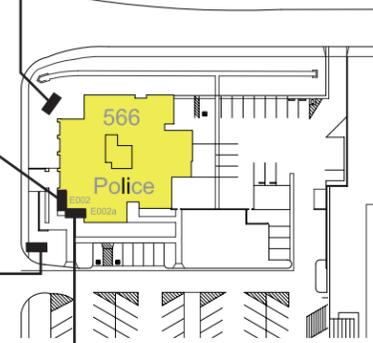

Add
W50 Vehicular Bldg ID



Keep existing sign

| Riviera Library (322) | | |
|-----------------------|-----------------------|-----|
| | | qty |
| W50 | Vehicular Bldg ID | 0 |
| W51 | Freestanding, Ped | 2 |
| W52 | Wall Mounted | 2 |
| W53 | Vinyl Letters on Door | 2 |
| W54 | Parapet Letters | 0 |
| B95 | Loading Dock ID | 1 |




Keep existing sign



Add W51 Freestanding Bldg ID



Add W52 Wall Mounted Bldg ID (ceiling hung)

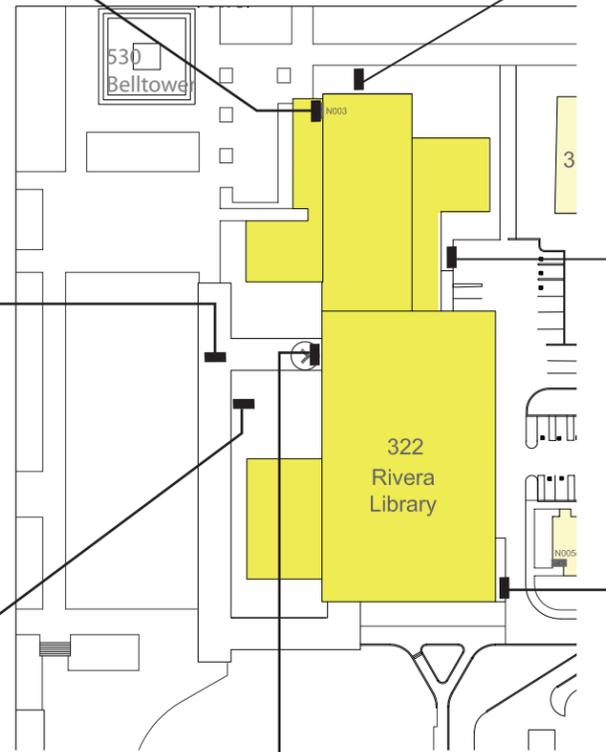

Replace with B95 Loading Dock ID


Add W51 Freestanding Bldg ID



Add W53 Vinyl Letters on Door




Add W53 Vinyl Letters on Door

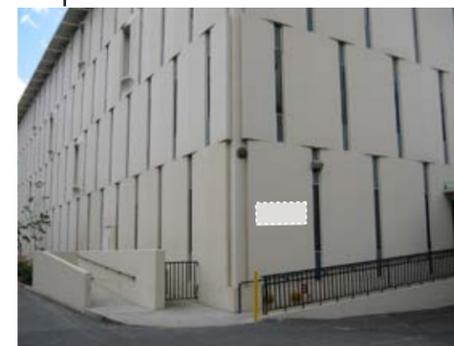


Add W52 Wall Mounted Bldg ID

| Satellite Chiller Plant (367) | | qty |
|-------------------------------|-----------------------|-----|
| W50 | Vehicular Bldg ID | 0 |
| W51 | Freestanding, Ped | 0 |
| W52 | Wall Mounted | 0 |
| W53 | Vinyl Letters on Door | 0 |
| W54 | Parapet Letters | 0 |
| B95 | Loading Dock ID | 0 |

No signs proposed

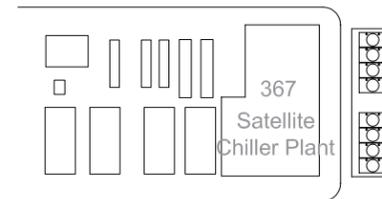

| Science Laboratories 1 (416) | | qty |
|------------------------------|-----------------------|-----|
| W50 | Vehicular Bldg ID | 0 |
| W51 | Freestanding, Ped | 1 |
| W52 | Wall Mounted | 2 |
| W53 | Vinyl Letters on Door | 5 |
| W54 | Parapet Letters | 0 |
| B95 | Loading Dock ID | 0 |

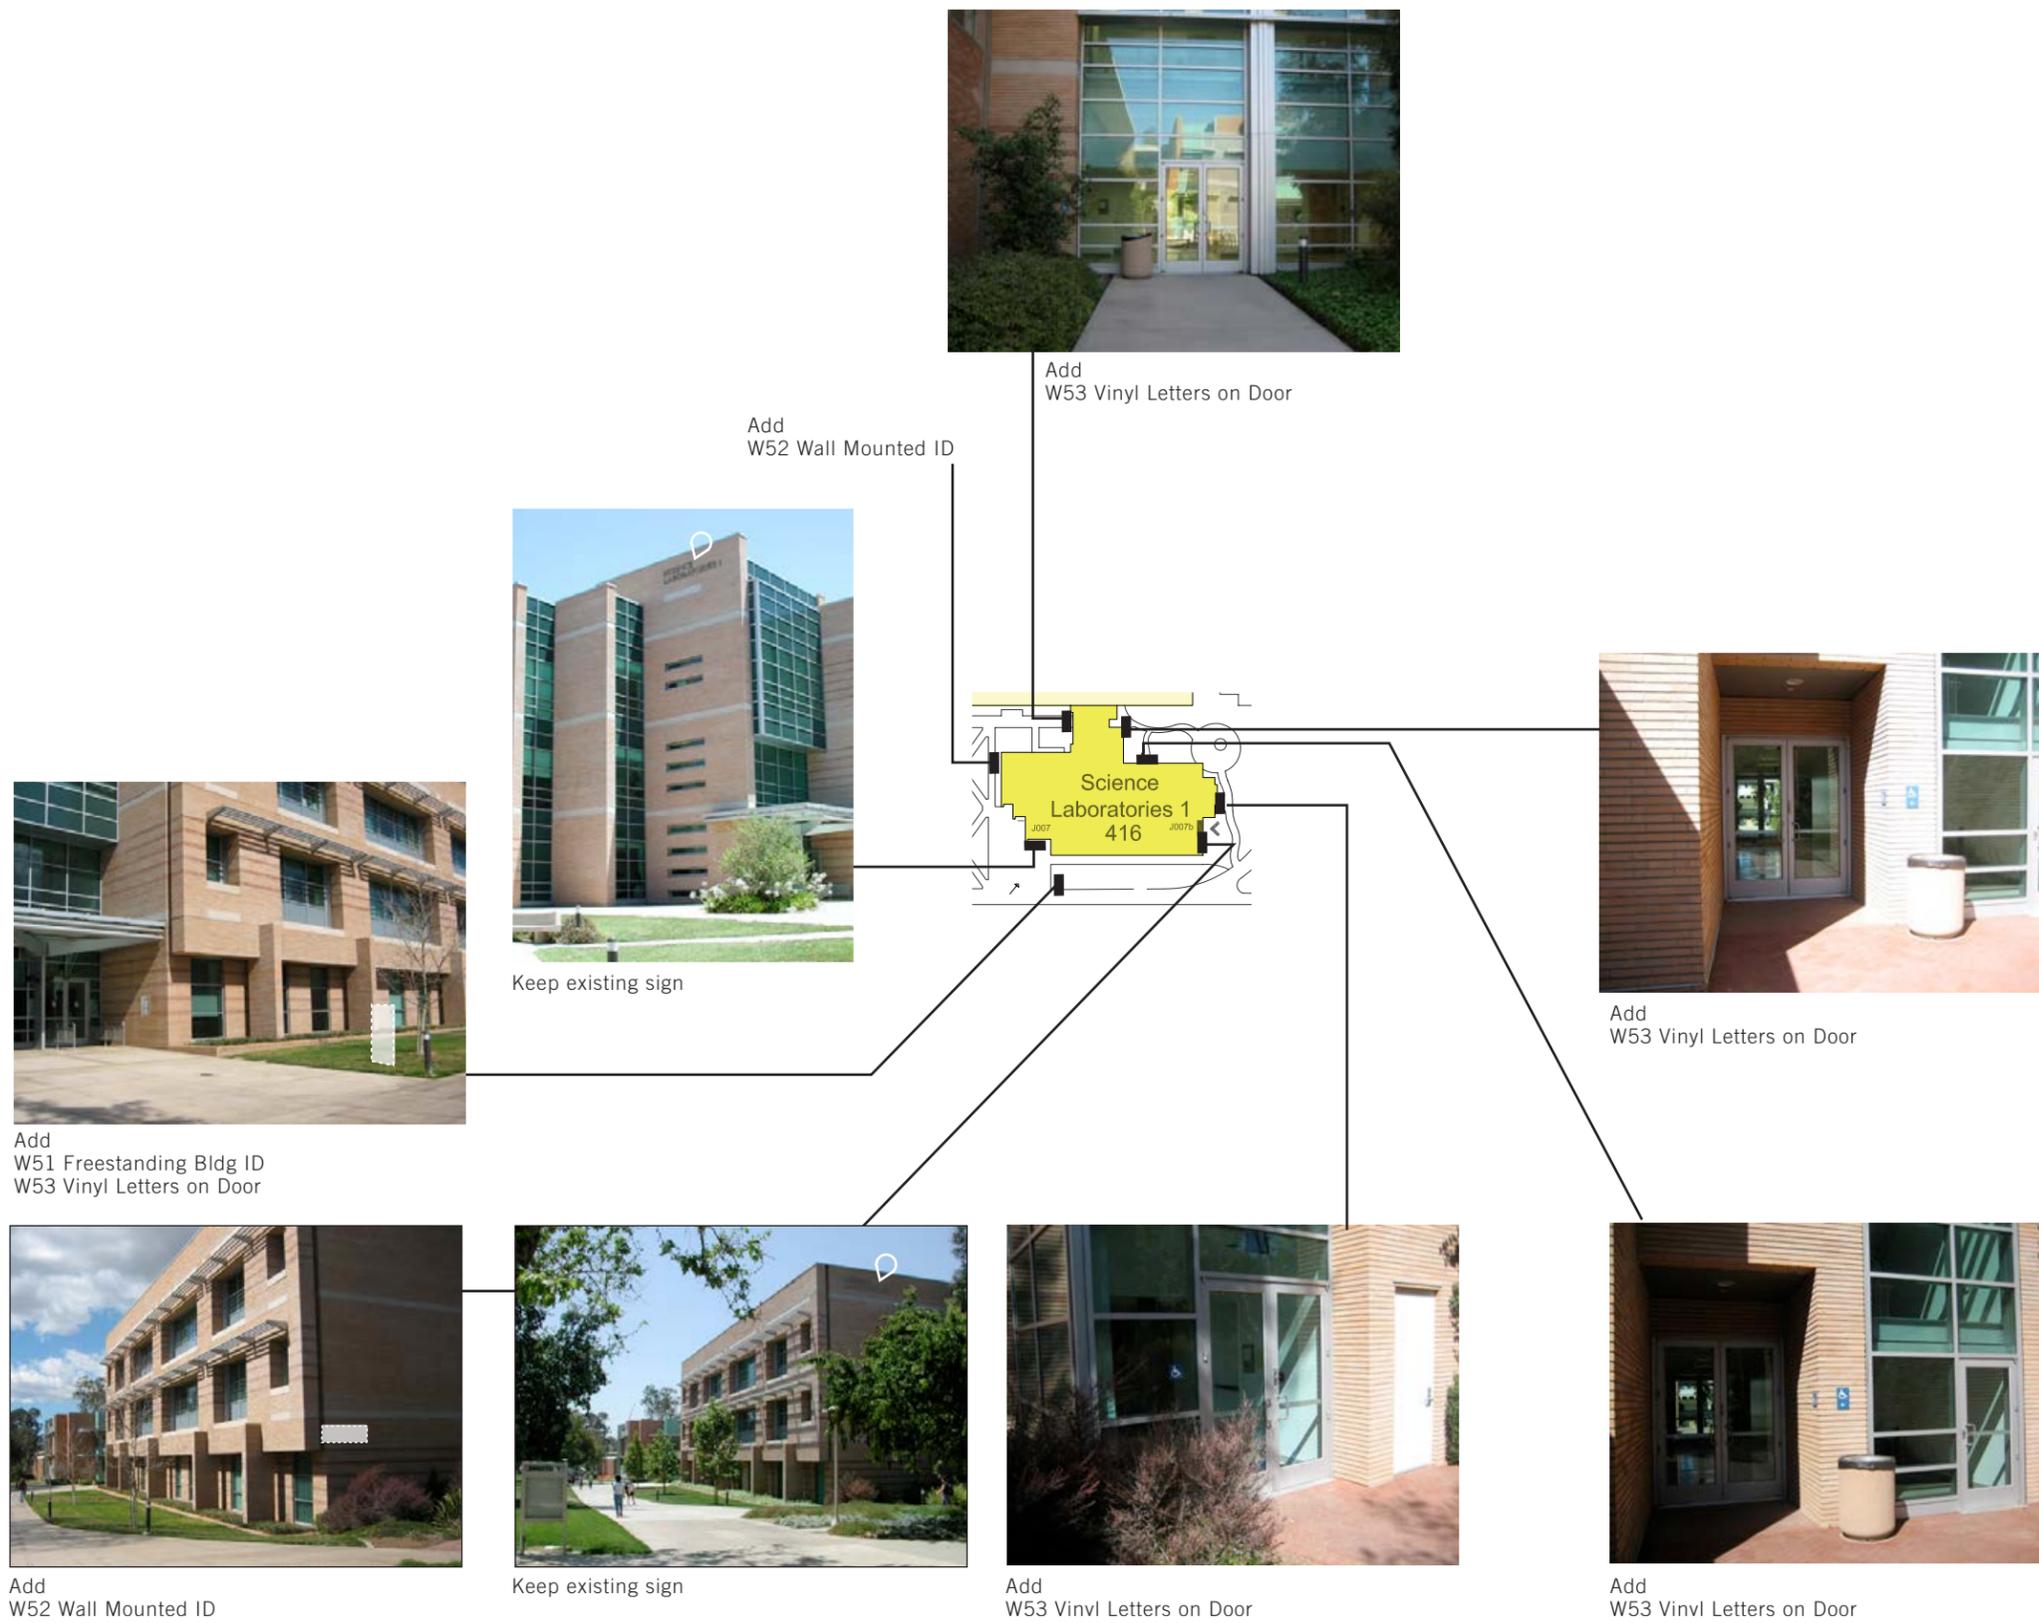

| Science Library (418) | | qty |
|-----------------------|-----------------------|-----|
| W50 | Vehicular Bldg ID | 1 |
| W51 | Freestanding, Ped | 1 |
| W52 | Wall Mounted | 4 |
| W53 | Vinyl Letters on Door | 1 |
| W54 | Parapet Letters | 0 |
| B95 | Loading Dock ID | 1 |




Add
W52 Wall Mounted Bldg ID



Add
B95 Loading Dock Info



Add
W52 Wall Mounted Bldg ID

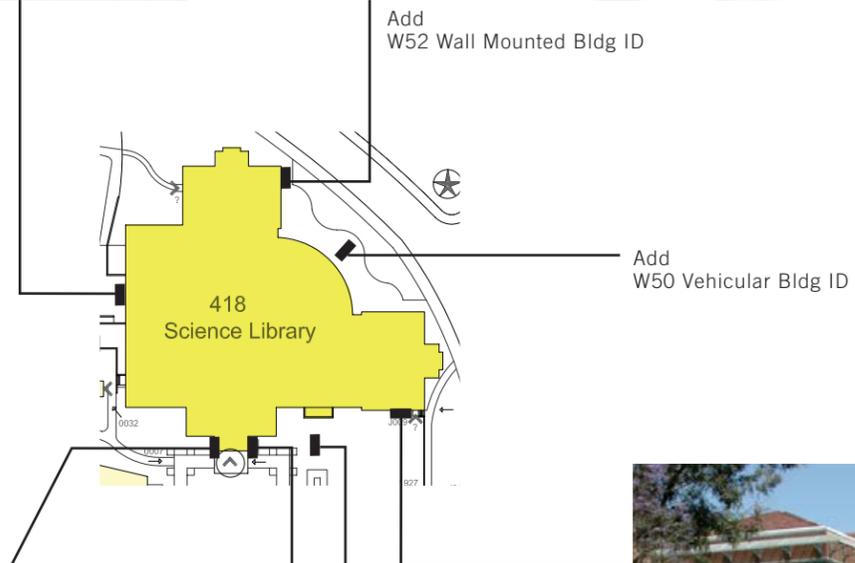

Add
W52 Wall Mounted Bldg ID
W53 Vinyl Letters on Door



Keep existing sign

| Speith Hall (323) | | qty |
|-------------------|-----------------------|-----|
| W50 | Vehicular Bldg ID | 0 |
| W51 | Freestanding, Ped | 1 |
| W52 | Wall Mounted | 5 |
| W53 | Vinyl Letters on Door | 3 |
| W54 | Parapet Letters | 0 |
| B95 | Loading Dock ID | 0 |



Replace with W53 Vinyl Letters on Door




Keep existing sign



Add W51 Freestanding Bldg ID




Add W52 WallMounted Bldg ID

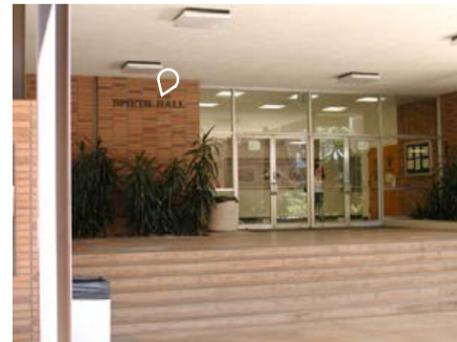


Keep existing sign



Add W52 WallMounted Bldg ID

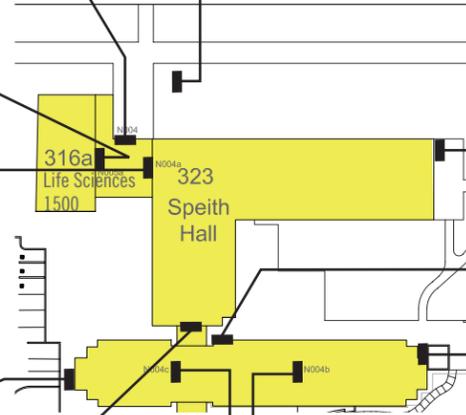

Add W52 WallMounted Bldg ID

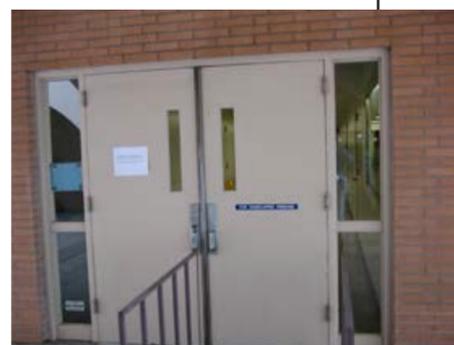

Replace with W52 WallMounted Bldg ID



Replace with W53 Vinyl Letters on Door




Replace with W53 Vinyl Letters on Door



Add W52 WallMounted Bldg ID

Sproul Hall (523)

| | | qty |
|-----|-----------------------|-----|
| W50 | Vehicular Bldg ID | 0 |
| W51 | Freestanding, Ped | 1 |
| W52 | Wall Mounted | 3 |
| W53 | Vinyl Letters on Door | 4 |
| W54 | Parapet Letters | 0 |
| B95 | Loading Dock ID | 1 |

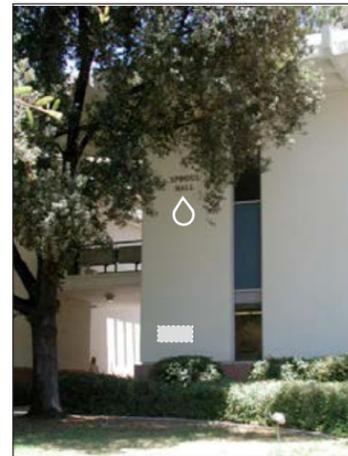

Keep existing sign
Add
W52 Wall Mounted Bldg ID




Keep existing sign




Replace with
W53 Vinyl Letters on Door



Add
B95 Loading Dock ID

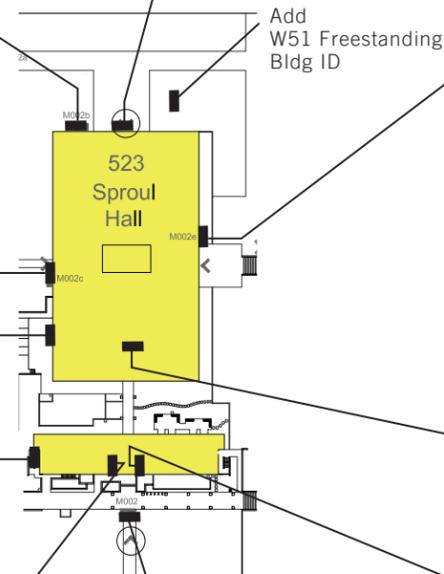

Add
W51 Freestanding
Bldg ID

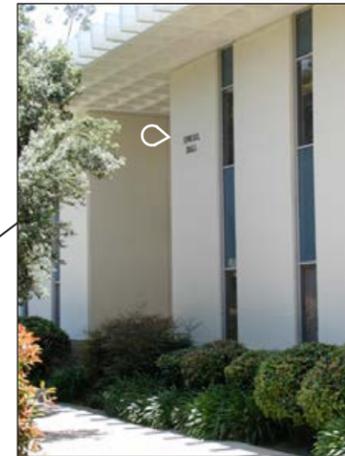

Keep existing sign
Add
W52 Wall Mounted Bldg ID



Add
W52 Wall Mounted Bldg ID



Add
W53 Vinyl Letters on Door



Add
W53 Vinyl Letters on Door



Keep existing sign



Add
W53 Vinyl Letters on Door

| Statistic Computer Building (588) | | qty |
|-----------------------------------|-----------------------|-----|
| W50 | Vehicular Bldg ID | 1 |
| W51 | Freestanding, Ped | 1 |
| W52 | Wall Mounted | 3 |
| W53 | Vinyl Letters on Door | 3 |
| W54 | Parapet Letters | 0 |
| B95 | Loading Dock ID | 0 |



Keep existing sign



Add W52 Wall Mounted Bldg ID



Replace with W53 Vinyl Letters on Door



Add W52 Wall Mounted Bldg ID

Add W51 Freestanding Bldg ID

Add W50 Vehicular Bldg ID



Add W53 Vinyl Letters on Door




Add W52 Wall Mounted Bldg ID
W53 Vinyl Letters on Door


Add B95 Loading Dock ID



Keep existing sign

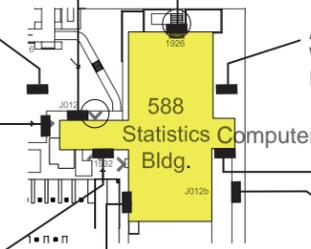

| Stonehaven Apts. (991) | | qty |
|------------------------|-----------------------|-----|
| W50 | Vehicular Bldg ID | 2 |
| W51 | Freestanding, Ped | 0 |
| W52 | Wall Mounted | 0 |
| W53 | Vinyl Letters on Door | 0 |
| W54 | Parapet Letters | 0 |
| B95 | Loading Dock ID | 0 |

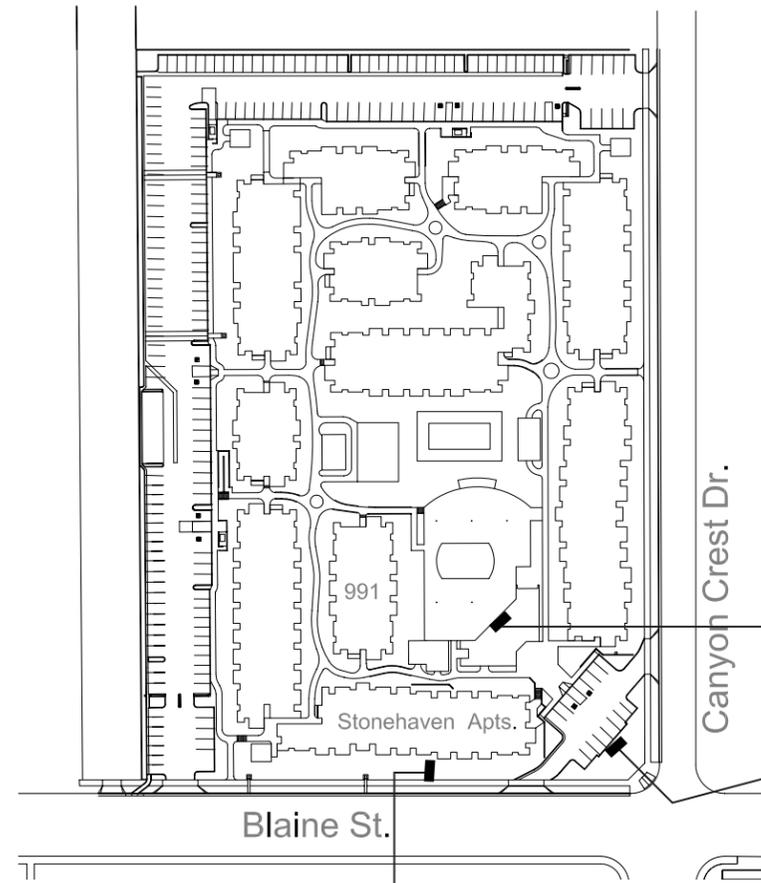


Keep existing sign



Replace with W50 Vehicular Bldg ID

Add W50 Vehicular Bldg Sign


| Student Rec Center (511) | | qty |
|--------------------------|-----------------------|-----|
| W50 | Vehicle Bldg ID | 0 |
| W51 | Freestanding, Ped | 0 |
| W52 | Wall Mounted | 0 |
| W53 | Vinyl Letters on Door | 0 |
| W54 | Parapet Letters | 0 |
| B95 | Loading Dock ID | 0 |

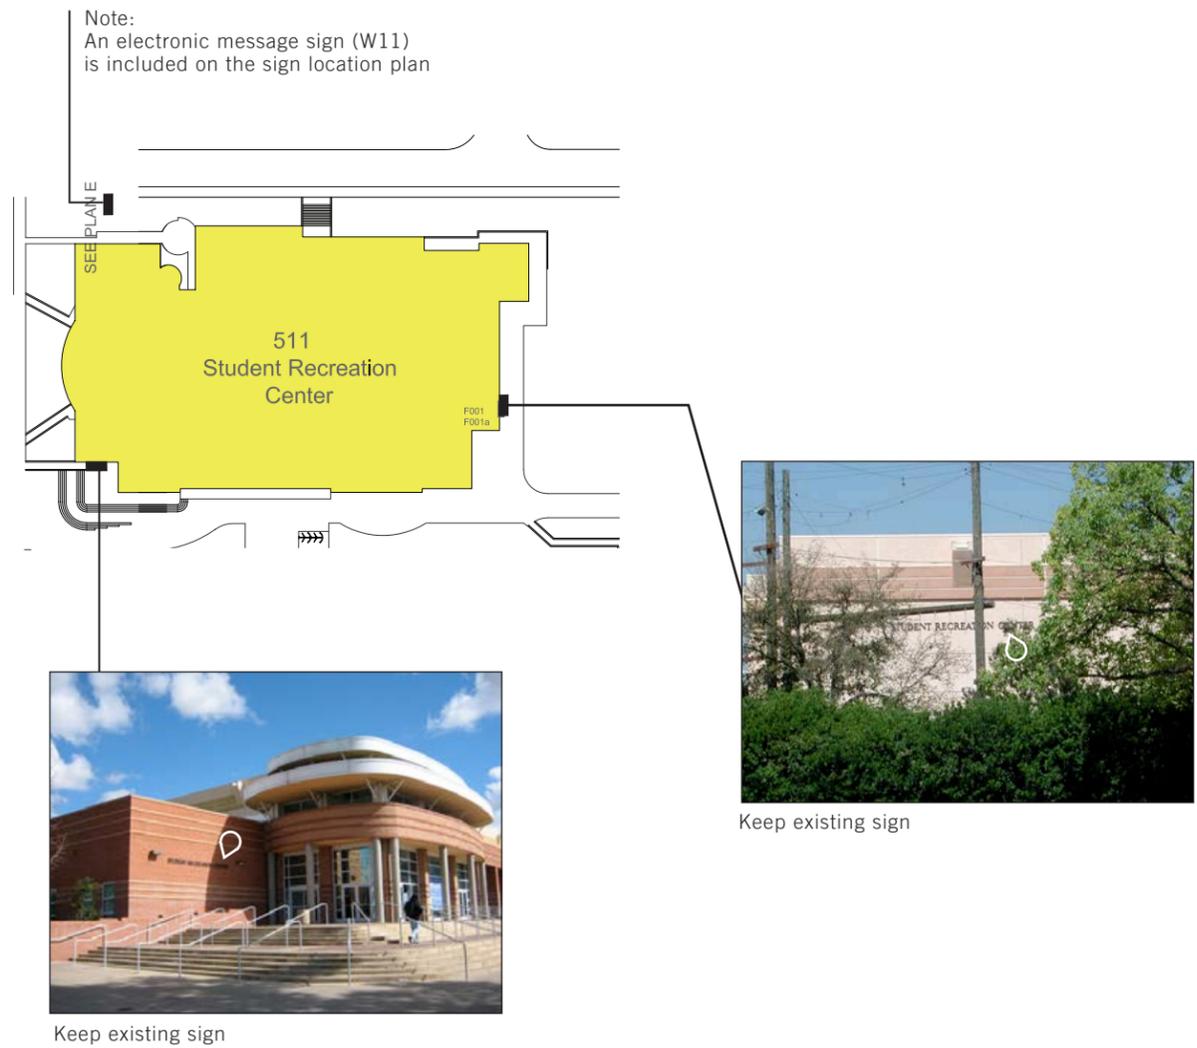

| UCR Athletic Complex (285) | | qty |
|----------------------------|-----------------------|-----|
| W50 | Vehicular Bldg ID | 1 |
| W51 | Freestanding, Ped | 2 |
| W52 | Wall Mounted | 0 |
| W53 | Vinyl Letters on Door | 0 |
| W54 | Parapet Letters | 0 |
| B95 | Loading Dock ID | 0 |



Replace with W50 Vehicular Bldg ID

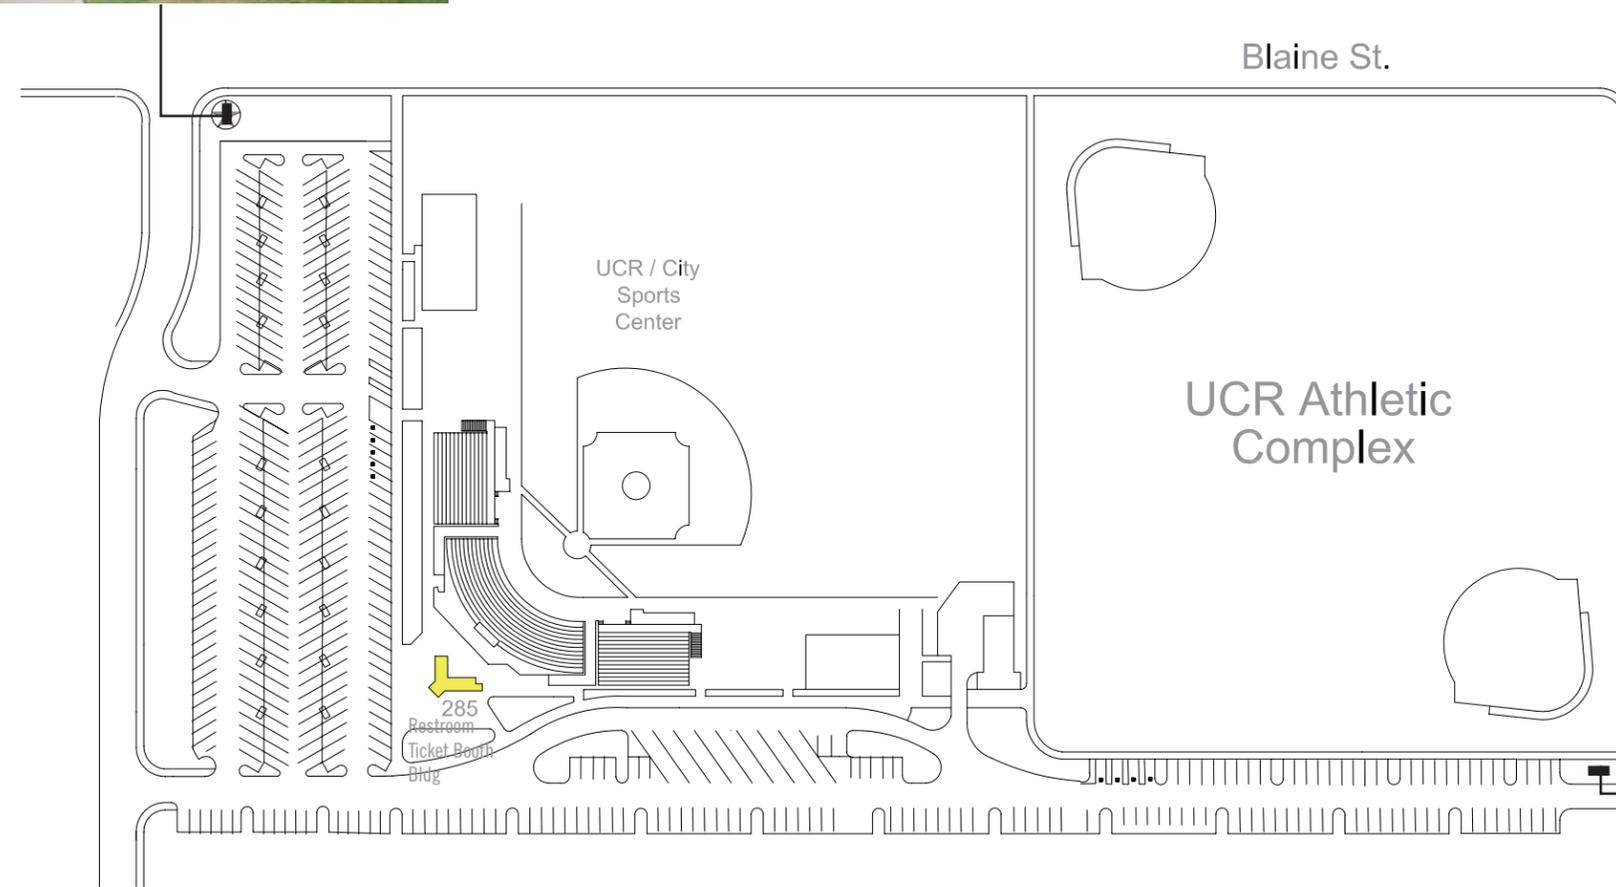

Note:
A Parking Sign (W70)
with the bldg name
has been included
in the sign location plan

| UCR Extension Center (722) | | qty |
|----------------------------|-----------------------|-----|
| W50 | Vehicular Bldg ID | 1 |
| W51 | Freestanding, Ped | 0 |
| W52 | Wall Mounted | 0 |
| W53 | Vinyl Letters on Door | 1 |
| W54 | Parapet Letters | 0 |
| B95 | Loading Dock ID | 0 |


* Replace Face of large freestanding sign



Keep existing sign



Keep existing sign

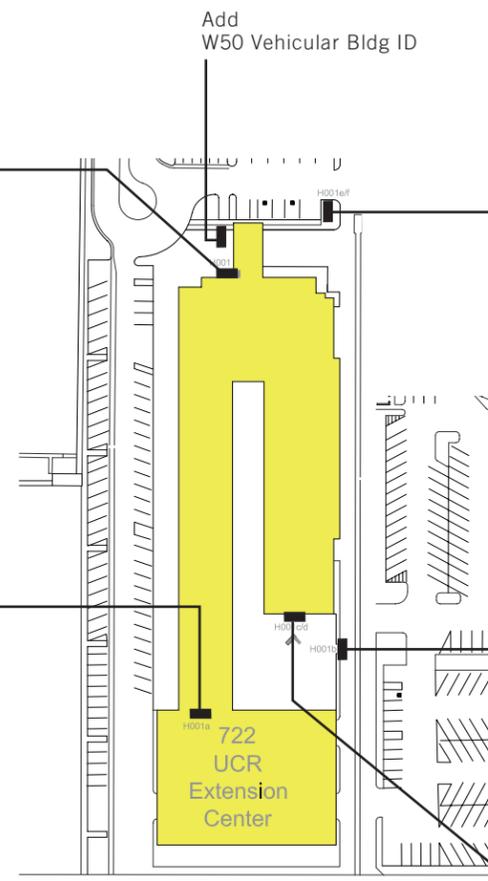

Replace face of sign to match current brand



Keep existing sign



Keep existing sign
Add
W53 Vinyl Letters on Door

| University Lab Bldg (263) | | qty |
|---------------------------|-----------------------|-----|
| W50 | Vehicular Bldg ID | 1 |
| W51 | Freestanding, Ped | 0 |
| W52 | Wall Mounted | 2 |
| W53 | Vinyl Letters on Door | 0 |
| W54 | Parapet Letters | 0 |
| B95 | Loading Dock ID | 0 |



| University Lecture Hall (383) | | qty |
|-------------------------------|-----------------------|-----|
| W50 | Vehicular Bldg ID | 0 |
| W51 | Freestanding, Ped | 1 |
| W52 | Wall Mounted | 4 |
| W53 | Vinyl Letters on Door | 2 |
| W54 | Parapet Letters | 0 |
| B95 | Loading Dock ID | 0 |




Add
W52 Wall Mounted Bldg ID



Add
W52 Wall Mounted Bldg ID



Add
W52 Wall Mounted Bldg ID

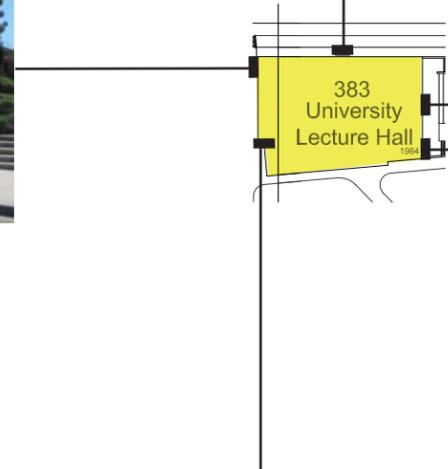

Add
W53 Vinyl Letters on Door




Add
W52 Wall Mounted Bldg ID
W53 Vinyl Letters on Door
W51 Freestanding Bldg ID


| University Office Bldg (205) | | qty |
|------------------------------|-----------------------|-----|
| W50 | Vehicular Bldg ID | 1 |
| W51 | Freestanding, Ped | 0 |
| W52 | Wall Mounted | 1 |
| W53 | Vinyl Letters on Door | 0 |
| W54 | Parapet Letters | 0 |
| B95 | Loading Dock ID | 0 |



Keep existing sign

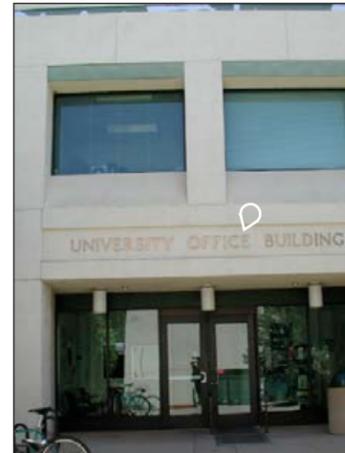

Keep existing sign
Add W53 Vinyl Letters on Door

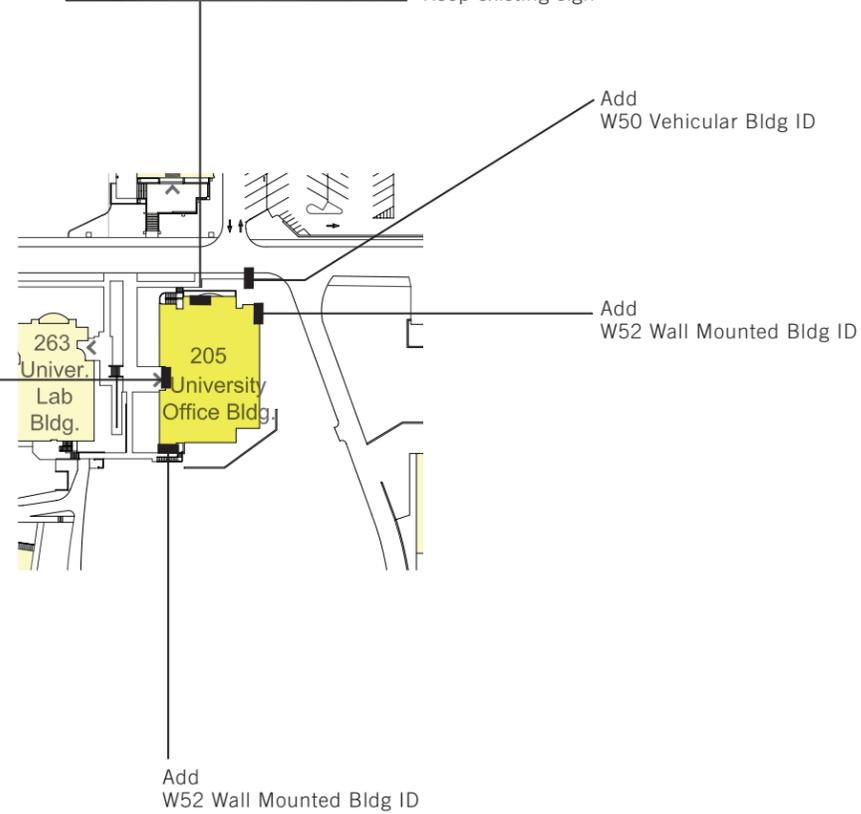


| | | |
|-----|-----------------------|---|
| W51 | Freestanding, Ped | 0 |
| W52 | Wall Mounted | 0 |
| W53 | Vinyl Letters on Door | 0 |
| W54 | Parapet Letters | 0 |


| | | |
|-----|-----------------|---|
| B95 | Loading Dock ID | 0 |
|-----|-----------------|---|

No Signs Recommended at this Time

Not UCR property - Leased

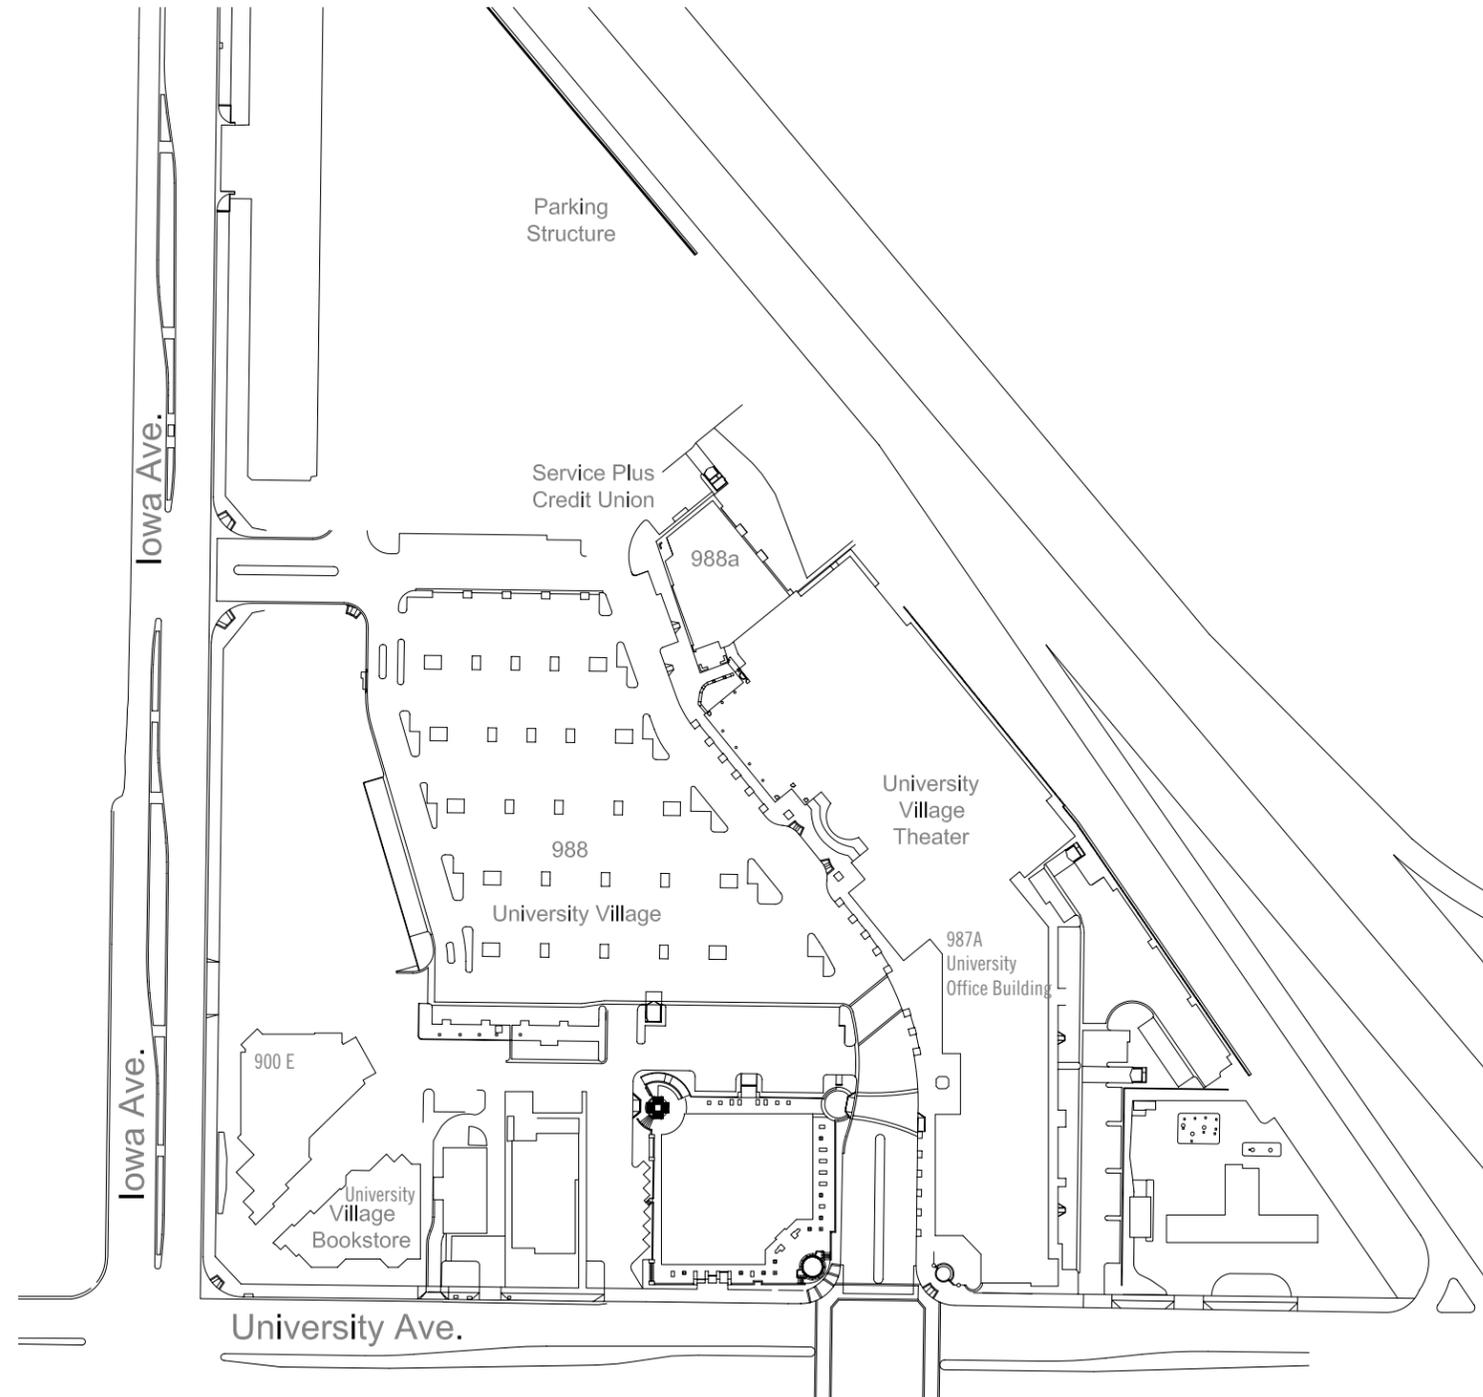

| University Plaza Apts. (715) | | qty |
|------------------------------|-----------------------|-----|
| W50 | Vehicular Bldg ID | 1 |
| W51 | Freestanding, Ped | 0 |
| W52 | Wall Mounted | 0 |
| W53 | Vinyl Letters on Door | 0 |
| W54 | Parapet Letters | 0 |
| B95 | Loading Dock ID | 0 |

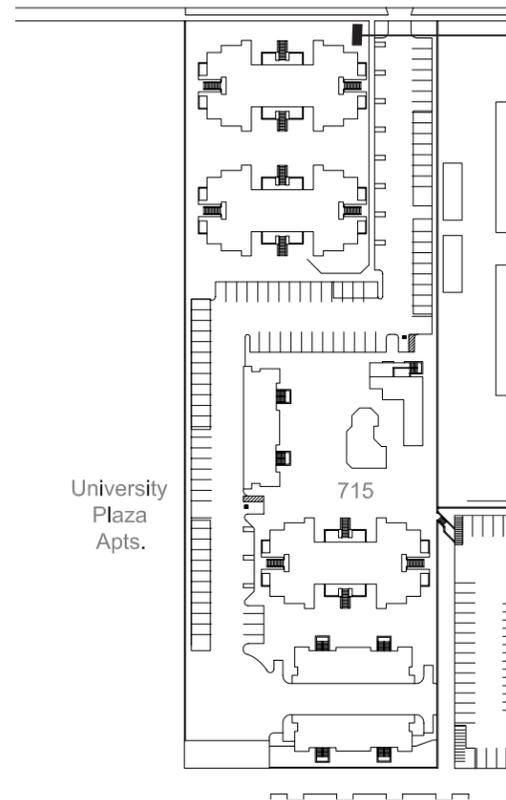

Replace with W50 Vehicular Bldg ID

Watkins Hall (354)

| | qty |
|---------------------------|-----|
| W50 Vehicular Bldg ID | 0 |
| W51 Freestanding, Ped | 2 |
| W52 Wall Mounted | 6 |
| W53 Vinyl Letters on Door | 4 |
| W54 Parapet Letters | 0 |
| B95 Loading Dock ID | 0 |



Possible Banner Location



Add W52 Wall Mounted Bldg ID



Possible Banner Location




Add W52 Wall Mounted Bldg ID





Add W51 Freestanding Bldg ID



Replace with W53 Vinyl Letters on Door

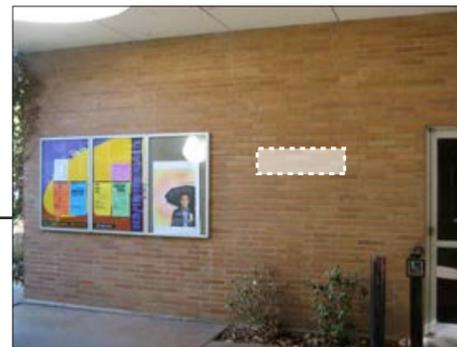

Add W52 Wall Mounted Bldg ID

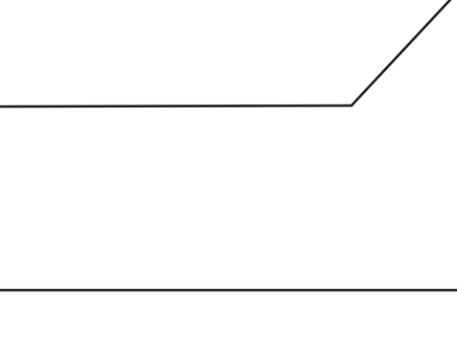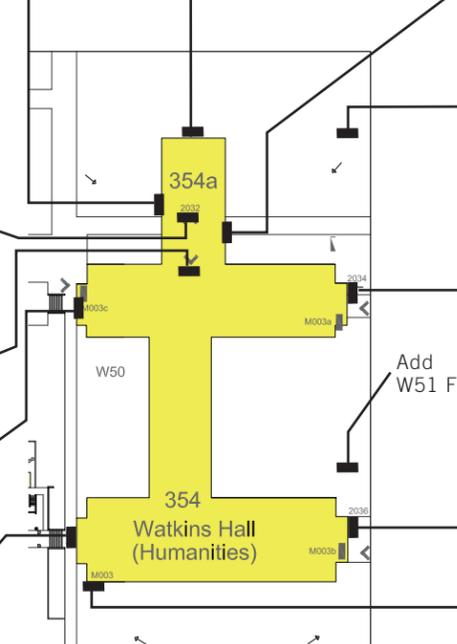

Add W51 Freestanding Bldg ID



Keep existing parapet sign
Add W52 Wall Mounted Bldg



Add W52 Wall Mounted Bldg ID



Keep existing sign



Replace with W53 Vinyl Letters on Door



Replace with W53 Vinyl Letters on Door



Add W52 Wall Mounted Bldg ID



Replace with W53 Vinyl Letters on Door



| Webber Hall (342) | | qty |
|-------------------|-----------------------|-----|
| W50 | Vehicular Bldg ID | 0 |
| W51 | Freestanding, Ped | 1 |
| W52 | Wall Mounted | 4 |
| W53 | Vinyl Letters on Door | 4 |
| W54 | Parapet Letters | 0 |
| B95 | Loading Dock ID | 0 |

